

8	9	10	11	12	13	14	15	

OWNER / DEVELOPER / APPLICANT: MARYLAND ZOO IN BALTIMORE 1876 MANSION HOUSE DRIVE BALTIMORE MD 21217 CONTACT: MR. KARL KRANZ PHONE: 443-552-3350 <u>LEGEND</u> PROPOSED BUILDING ------ 100 ------ PROPOSED MAJOR CONTOUR PROPOSED ASPHALT PROPOSED CURB PROPOSED CONCRETE WALK ----- LOD ----- LIMIT OF DISTURBANCE UGE PROPOSED UNDERGROUND ELECTRIC PROPOSED SANITARY CLEANOUT PROPOSED STORMDRAIN LINE PROPOSED STORMDRAIN MANHOLE PROPOSED SMALL SECTIONAL VAULT O)

PROPOSED WATER VALVE

## PROPOSED NOTES:

CONTRACTOR SHALL VERIFY FIELD CONDITIONS PRIOR TO AND DURING CONSTRUCTION/DEMOLITION AND NOTIFY THE OWNER IMMEDIATELY OF ANY DISCREPANCIES BETWEEN ACTUAL FIELD CONDITIONS AND THE APPROVED PLANS.

WVW

- CONTRACTOR SHALL MAINTAIN PEDESTRIAN & VEHICULAR ACCESS TO AND AROUND OVERALL SITE DURING CONSTRUCTION ACTIVITIES. CONTRACTOR SHALL FURNISH VEHICULAR AND PEDESTRIAN TRAFFIC PROTECTION IN ACCORDANCE WITH MUTCD LATEST VERSION AND THE CITY OF BALTIMORE REQUIREMENTS. 3. CONTRACTOR SHALL CONTACT THE OWNER AND DEVELOPER 72 HOURS PRIOR TO COMMENCING
- ANY WORK. 4. ALL UTILITY FRAMES AND COVERS TO REMAIN WITHIN THE PROJECT AREA SHALL BE ADJUSTED BY
- THE CONTRACTOR TO MEET NEW PAVEMENT OR GROUND ELEVATION. THE CONTRACTOR SHALL MAKE, CHECK, AND BE RESPONSIBLE FOR ALL MEASUREMENTS AND DIMENSIONS NECESSARY FOR THE PROPER CONSTRUCTION OF AND THE PREVENTION OF MISFITTINGS IN THE WORK. VERIFY LOCATIONS AND ELEVATIONS OF EXISTING UTILITIES BEFORE STARTING CONSTRUCTION IN EACH AREA.
- 5. CONTRACTOR TO COORDINATE WITH MISS UTILITY, THE CITY OF BALTIMORE, AND A PRIVATE UTILITY LOCATOR COMPANY PRIOR TO COMMENCING ANY WORK. THE CONTRACTOR MUST NOTIFY ALL PUBLIC UTILITY COMPANIES WITH UNDERGROUND FACILITIES IN THE AREA OF PROPOSED EXCAVATION AND HAVE THOSE FACILITIES LOCATED BY THE UTILITY COMPANIES PRIOR TO COMMENCING EXCAVATION.
- 6. LIVE UNDERGROUND UTILITIES EXIST WITHIN THE WORK AREA. CONTRACTOR SHALL USE EXTREME
- CAUTION AND SHALL COMPLY WITH APPLICABLE FEDERAL, STATE AND LOCAL REGULATIONS. CONTRACTOR SHALL TAKE NECESSARY PRECAUTIONS TO PROTECT EXISTING UTILITY STRUCTURES TO REMAIN DURING DEMOLITION AND CONSTRUCTION ACTIVITIES AND TO PREVENT DEBRIS, SEDIMENT, OR WATER FROM ENTERING THE STRUCTURES.
- 8. CONTRACTOR SHALL PROTECT ALL FACILITIES AND UTILITIES TO REMAIN FROM DAMAGE WHETHER SHOWN HEREON OR NOT. 9. ALL EXISTING PAINT MARKINGS ADJACENT TO THE PROJECT AREA WHICH BECOME FADED OR
- OBSCURED DUE TO CONSTRUCTION ACTIVITY SHALL BE REPAINTED OR RESTORED AT NO ADDITIONAL COST TO THE OWNER.
- 10. CONTRACTOR SHALL COORDINATE WITH OWNER AND UTILITY PROVIDER TO MINIMIZE DURATION OF UTILITY OUTAGES. 11. CONTRACTOR IS RESPONSIBLE FOR THE COORDINATION AND PLACEMENT OF ALL UTILITY CONDUITS
- AND ENCASEMENT. CONTRACTOR SHALL PROVIDE CONDUITS AND PULL STRINGS IN ACCORDANCE WITH UTILITY PROVIDER REQUIREMENTS FOR THEIR RESPECTIVE CONDUITS. 12. USE EXTREME CAUTION WHEN WORKING AROUND EXISTING TREES TO REMAIN SO AS NOT TO
- DAMAGE THE TREES OR ROOT SYSTEMS. 13. CONTRACTOR SHALL PROTECT ALL AREAS BEYOND THE LIMITS OF DISTURBANCE AND SHALL RESTORE ANY AND ALL AREAS DISTURBED DURING CONSTRUCTION TO THEIR ORIGINAL OR BETTER CONDITION.
- 14. INFORMATION SHOWN ON THIS DRAWING HAS BEEN PROVIDED AS A GUIDE TO ASSIST THE CONTRACTOR IN ESTABLISHING THE LOCATIONS OF PROPOSED CONSTRUCTION WITH RESPECT TO EXISTING SITE IMPROVEMENTS. IT IS THE RESPONSIBILITY OF THE CONTRACTOR TO PROVIDE ALL CONSTRUCTION SURVEY STAKEOUT REQUIRED AND TO CONFIRM ALL INFORMATION SHOWN HEREON. 15. CONTRACTOR SHALL FURNISH SHORING, SHEATHING, OR OTHERWISE SUPPORT EXCAVATIONS TO PROTECT EXCAVATIONS FROM CAVE-INS UNTIL BACKFILL PLACEMENT IS COMPLETE PER
- SPECIFICATIONS. 16. SEE EXISTING CONDITIONS PLAN FOR SITE BENCHMARKS. CONTRACTOR SHALL BE RESPONSIBLE FOR ESTABLISHING AND MAINTAINING TEMPORARY BENCHMARKS THROUGHOUT THE DURATION OF
- THE PROJECT FOR CONSTRUCTION LAYOUT PURPOSES. 17. REFER TO THE SITE LANDSCAPING PLANS FOR SITE FURNISHING AND PLANTING INFORMATION.

18

18. SEE LANDSCAPE PLANS FOR PROPOSED SCORING AND PAVER PATTERNS. 19. REFER TO THE ELECTRICAL PLANS FOR ADDITIONAL ELECTRICAL UTILITY INFORMATION.

> ALL WORK SHALL CONFORM TO CITY OF BALTIMORE DEPARTMENT OF PUBLIC WORKS SPECIFICATIONS FOR MATERIALS, HIGHWAYS, BRIDGES, UTILITIES, AND INCIDENTAL STRUCTURES 2006, AND SUPPLEMENTARY SPECIFICATIONS IN THE CONTRACT DOCUMENTS.

SCALE: 1"=20' BCNR # 11545

19

20

	DELPHIA, PA 1910 : 215.557.6509	2
CARROLI 215 SCHIL HUNT	<u>/IL ENGINEER:</u> L ENGINEERING, LING CIRCLE, STE VALLEY, MD 2103 : 410.785.7423	E 102
ROB <mark>INSON</mark> 28 WES ME	CAPE ARCHITEC ANDERSON SUM ST STATE STREE EDIA, PA 19063 : 302.888.1544	MER
TRUCTURA 225 EAST N SALT LA	TURAL ENGINEE AL DESIGN STUDI MURRAY HOLLAD AKE CITY, UT 841 : 801.274.3950	Ō, IN AY R
OVACS, W 190 WEST BALTI	EP ENGINEER: HITNEY & ASSOC OSTEND ST, STE IMORE, MD 21230 : 410.244.7191	
HE MARYLA 1 S	<b>YLAND ZQ</b> AND ZOO IN BALTI SAFARI PLACE	
BALIII	MORE, MD 21217	
<b>RED PANDA</b>	THE MARYLAND ZOO IN BALTIMORE 1 SAFARI PLACE BALTIMORE, MD 21217	
ARCHITECT IS METHODS, TECHN USED TO DO TH CONSTRUCTION, ANI OR IMPLIED CHANGES RESPONSIBLE FOR KI SUBMITTAL OF / ACKNOWLEDGEMENT HAVE BEEN FULLY AND THE BID PRICE.	D ILLISTRATE THE WORK TO BE DON NOT RESPONSIBLE FOR THE MEANS, IIQUES, SEQUENCES, AND PROCEDL 4 WORK OR THE SAFETY ASPECTS C D NOTHING ON THIS DRAWING EXP 5 THIS CONDITION. CONTRACTOR 5 NOWING HOW THEY AFFECT THE V A BID TO PERFORM THIS WORK IS A 1 OF THESE RESPONSIBILITIES, AND TH CONSIDERED IN PLANNING OF THE V NO CLAIMS FOR EXTRA CHARGES E VDITIONS WILL BE FORTHCOMING.	JRES F RESSED GHALL BE VORK. N IAT THEY VORK,
SEAL:		
	ALE A. CONTRACT	A
PRO	NO 14446	
	ONAL ENUM	
THAT THES APPROVED PROFESSIO	ONAL CERTIFICATION. I HEREBY CERTIFY SE DOCUMENTS WERE PREPARED OR D BY ME, AND THAT I AM A DULY LICENSED	
	ONAL ENGINEER UNDER THE LAWS OF THE MARYLAND, LICENSE NO. 14446 , N DATE 5/25/25 .	
EXPIRATIO	MARYLAND, LICENSE NO. 14446 , N DATE 5/25/25 .	
expiration	MARYLAND, LICENSE NO. 14446 ,	

BKP

ARCHITECT: BUELL KRATZER POWELL, P.C.

1525 LOCUST STREET

PROJECT TEAM:

DATE: JANUART 14, 2025				
PROJECT NO: 2023-10.04				
DRAWN BY	MJE			
CHECKED BY	CMS			
SUBMISSION	DATE			
BID SET	01/14/2025			
REVISION	DATE			

# DRAWING TITLE:

storm I	DRAIN
KEY PI	LAN

DRAWING NO:



			STORM DR	AIN SCHEDULE	
	STRUCTURE	RIM	INVERT IN	INVERT OUT	STRUCTURE/GRATE TYPE
ຊ່	I-2	314.00		311.00 (6")	2808AG/0899CGD
	HB-3		303.00 (6")	303.00 (6")	6" PVC 45° BEND
	I-4	302.50	300.00 (6")	295.35 (6")	2808AG/0899CGD
	MH-5	293.19	288.55 (12")	288.45 (12")	1599CGC
	I-6	292.75	290.05 (6")	289.55 (12")	1599CGD
	I-7	292.25	289.39 (12"); 289.39 (12")	289.29 (12")	3099CGD
	EX-8	292.26	291.10 (EX. 6")	289.61 (8")	EXIST. MH.
	I-9	302.00		299.00 (8")	1299CGS
	TD-10	296.00-296.00	295.00 (UPSTREAM END)	294.80 (DOWNSTREAM END) (4")	8'-8" LONG X 8" WIDE w/ LOCKING GRATE
-	MH-11	295.80	293.41 (4"); 293.08 (8"); 293.08 (8")	292.98 (12")	1899CGC
	I-12	296.00		294.00 (8")	SEE LS PLAN
	MH-13	295.85	293.78 (8")	293.68 (8")	1099CGC
	MH-14	295.80	292.58 (12"); 292.58 (8")	292.48 (12")	1899CGC
	I-15	294.11	292.78 (8")		1299CGD
	I-16	293.10		290.60 (6")	0899CGP
_	I-17	293.10	290.34 (6")	290.24 (6")	0899CGP
	I-18	293.10	289.98 (6")	289.88 (8")	1099CGP
	I-19	300.10	294.90 (12")	294.80 (12")	1599CGS
1	MH-20	300.80	295.20 (6"); 296.63 (12")	295.10 (12")	1599CGC
1	I-21	300.75		297.00 (12")	1299CGS
	MH-22	301.25	295.70 (12")	295.60 (12")	1299CGS
	MH-23	300.75	296.60 (8"); 296.60 (8")	296.27 (12")	1299CGC
_	I-24	300.75		297.37 (8")	SEE LS PLAN
	I-25	299.25		297.00 (8")	1299CGP
	I-26	301.50		295.75 (8")	1299CGD
	MH-27	294.50	289.65 (12"); 289.80 (8")	289.55 (12")	1599CGC
	TEE-28		289.20 (12"); 289.36 (8")	289.20 (12")	12"x8" TEE
	TEE-29		284.28 (12")	284.28 (12")	12" HDPE TEE
	EX-30	293.20 (EX)	288.24 (12")		EXIST. MH.
	DP-1	300.10	295.25 (6")		STORMBRIXX STORAGE CHAMBERS



HORIZONTAL DATUM: NAD 83(2011) VERTICAL DATUM: NAVD 88

1

2

NOTES:						
<u></u> .	/ERIFY SIZE, [	DEPTH. AND	MATERIAL	OF ALL	EXISTING	PIPE
	CTIONS PRIOR	,				
2. SHOP	DRAWINGS FOF	R STRUCTUI	RES SHALI	L BE SUE	BMITTED PF	RIOR TO
INSTALI	ATION. EQUIVE	ELANT STRU	CTURES N	IAY BE SI	JBSTITUTEI	Э.
	RATES SHALL E					


PIPE SCHEDULE					
FROM	TO	LENGTH (FEET)	SIZE (INCHES)	MATERIAL	
MH-05	EX-30	26	12	HDPE	
TEE-29	MH-05	54	12	HDPE	
TEE-28	TEE-29	11	12	HDPE	
I-07	TEE-28	9	12	HDPE	
MH-27	I-07	38	12	HDPE	
MH-14	MH-27	36	12	HDPE	
I-19	MH-14	52	12	HDPE	
MH-20	I-19	21	12	HDPE	
I-21	MH-20	28	12	HDPE	
I-06	TEE-29	8	12	HDPE	
ExMH-08	TEE-28	27	8	PVC	
MH-11	I-07	44	12	HDPE	
I-18	MH-27	9	8	PVC	
I-15	MH-14	40	12	HDPE	
DP-01	MH-20	4	6	PVC	
I-04	I-06	34	4	PVC	
TD-10	MH-11	6	4	PVC	
I-17	I-18	26	6	PVC	
HB-03	I-04	15	6	PVC	
I-16	I-17	26	6	PVC	
I-02	HB-03	40	6	PVC	
I-09	MH-11	53	8	PVC	
MH-13	MH-11	17	8	PVC	
I-12	MH-13	6	8	PVC	
I-26	PreStor	5	8	PVC	
MH-22	PreStor	5	12	HDPE	
MH-23	MH-22	58	12	HDPE	
I-24	MH-23	13	8	PVC	
I-25	MH-26	39	8	PVC	
MWS	DP-1	1	12	HDPE	
PreStor	MWS	2	8	PVC	

<u>NOTES</u>: 1. ALL HDPE PIPE SHALL BE N—12 DUAL WALL WITH WATER TIGHT JOINTS. 2. ALL PVC PIPE SHALL BE SCHDULE 40 WITH SOLVENT WELD JOINTS.


3	4	5	6	7	8	9	10	11	12	13	14	15

	(ВКР)
	PROJECT TEAM:
	<u>ARCHITECT:</u> BUELL KRATZER POWELL, P.C. 1525 LOCUST STREET PHILADELPHIA, PA 19102 T: 215.557.6509
-	<u>CIVIL ENGINEER:</u> CARROLL ENGINEERING, INC 215 SCHILLING CIRCLE, STE 102 HUNT VALLEY, MD 21031 T: 410.785.7423
- - - - )	LANDSCAPE ARCHITECT: ROBINSON ANDERSON SUMMERS 28 WEST STATE STREET MEDIA, PA 19063 T: 302.888.1544
	STRUCTURAL ENGINEER: STRUCTURAL DESIGN STUDIO, INC 2225 EAST MURRAY HOLLADAY RD SALT LAKE CITY, UT 84117 T: 801.274.3950
	MEP ENGINEER: KOVACS, WHITNEY & ASSOCIATES 190 WEST OSTEND ST, STE 300 BALTIMORE, MD 21230 T: 410.244.7191
	CLIENT:
	MARYLAND ZOO THE MARYLAND ZOO IN BALTIMORE 1 SAFARI PLACE
	BALTIMORE, MD 21217
	RED PANDA THE MARYLAND ZOO IN BALTIMORE I SAFARI PLACE ALTIMORE, MD 21217
	D P A ARYLA SALTIN FARI DRE,
	I SAL I SAL
	BAI TH
	THIS DRAWING IS TO ILLUSTRATE THE WORK TO BE DONE. THE ARCHITECT IS NOT RESPONSIBLE FOR THE MEANS, METHODS, TECHNIQUES, SEQUENCES, AND PROCEDURES USED TO DO THE WORK OR THE SAFETY ASPECTS OF CONSTRUCTION, AND NOTHING ON THIS DRAWING EXPRESSED OR IMPLIED CHANGES THIS CONDITION. CONTRACTOR SHALL BE RESPONSIBLE FOR KNOWING HOW THEY AFFECT THE WORK. SUBMITTAL OF A BID TO PERFORM THIS WORK IS AN ACKNOWLEDGEMENT OF THESE RESPONSIBILITIES, AND THAT THEY HAVE BEEN FULLY CONSIDERED IN PLANNING OF THE WORK, AND THE BID PRICE. NO CLAIMS FOR EXTRA CHARGES DUE TO
	SEAL:
	P R ALL MOINTE OF MARL
	PROFESSIONAL CERTIFICATION. I HEREBY CERTIFY
	THAT THESE DOCUMENTS WERE PREPARED OR APPROVED BY ME, AND THAT I AM A DULY LICENSED PROFESSIONAL ENGINEER UNDER THE LAWS OF THE STATE OF MARYLAND, LICENSE NO. 14446, EXPIRATION DATE 5/25/25.
	DATE: JANUARY 14, 2025 PROJECT NO: 2023-10.04
	DRAWN BY MJE CHECKED BY CMS
	SUBMISSIONDATEBID SET01/14/2025
	REVISION DATE
	DRAWING TITLE:
	SCHEDULES
	DRAWING NO:
	C510

OWNER / DEVELOPER/ APPLICANT: MARYLAND ZOO IN BALTIMORE 1876 MANSION HOUSE DRIVE BALTIMORE MD 21217 CONTACT: MR. KARL KRANZ PHONE: 443–552–3350

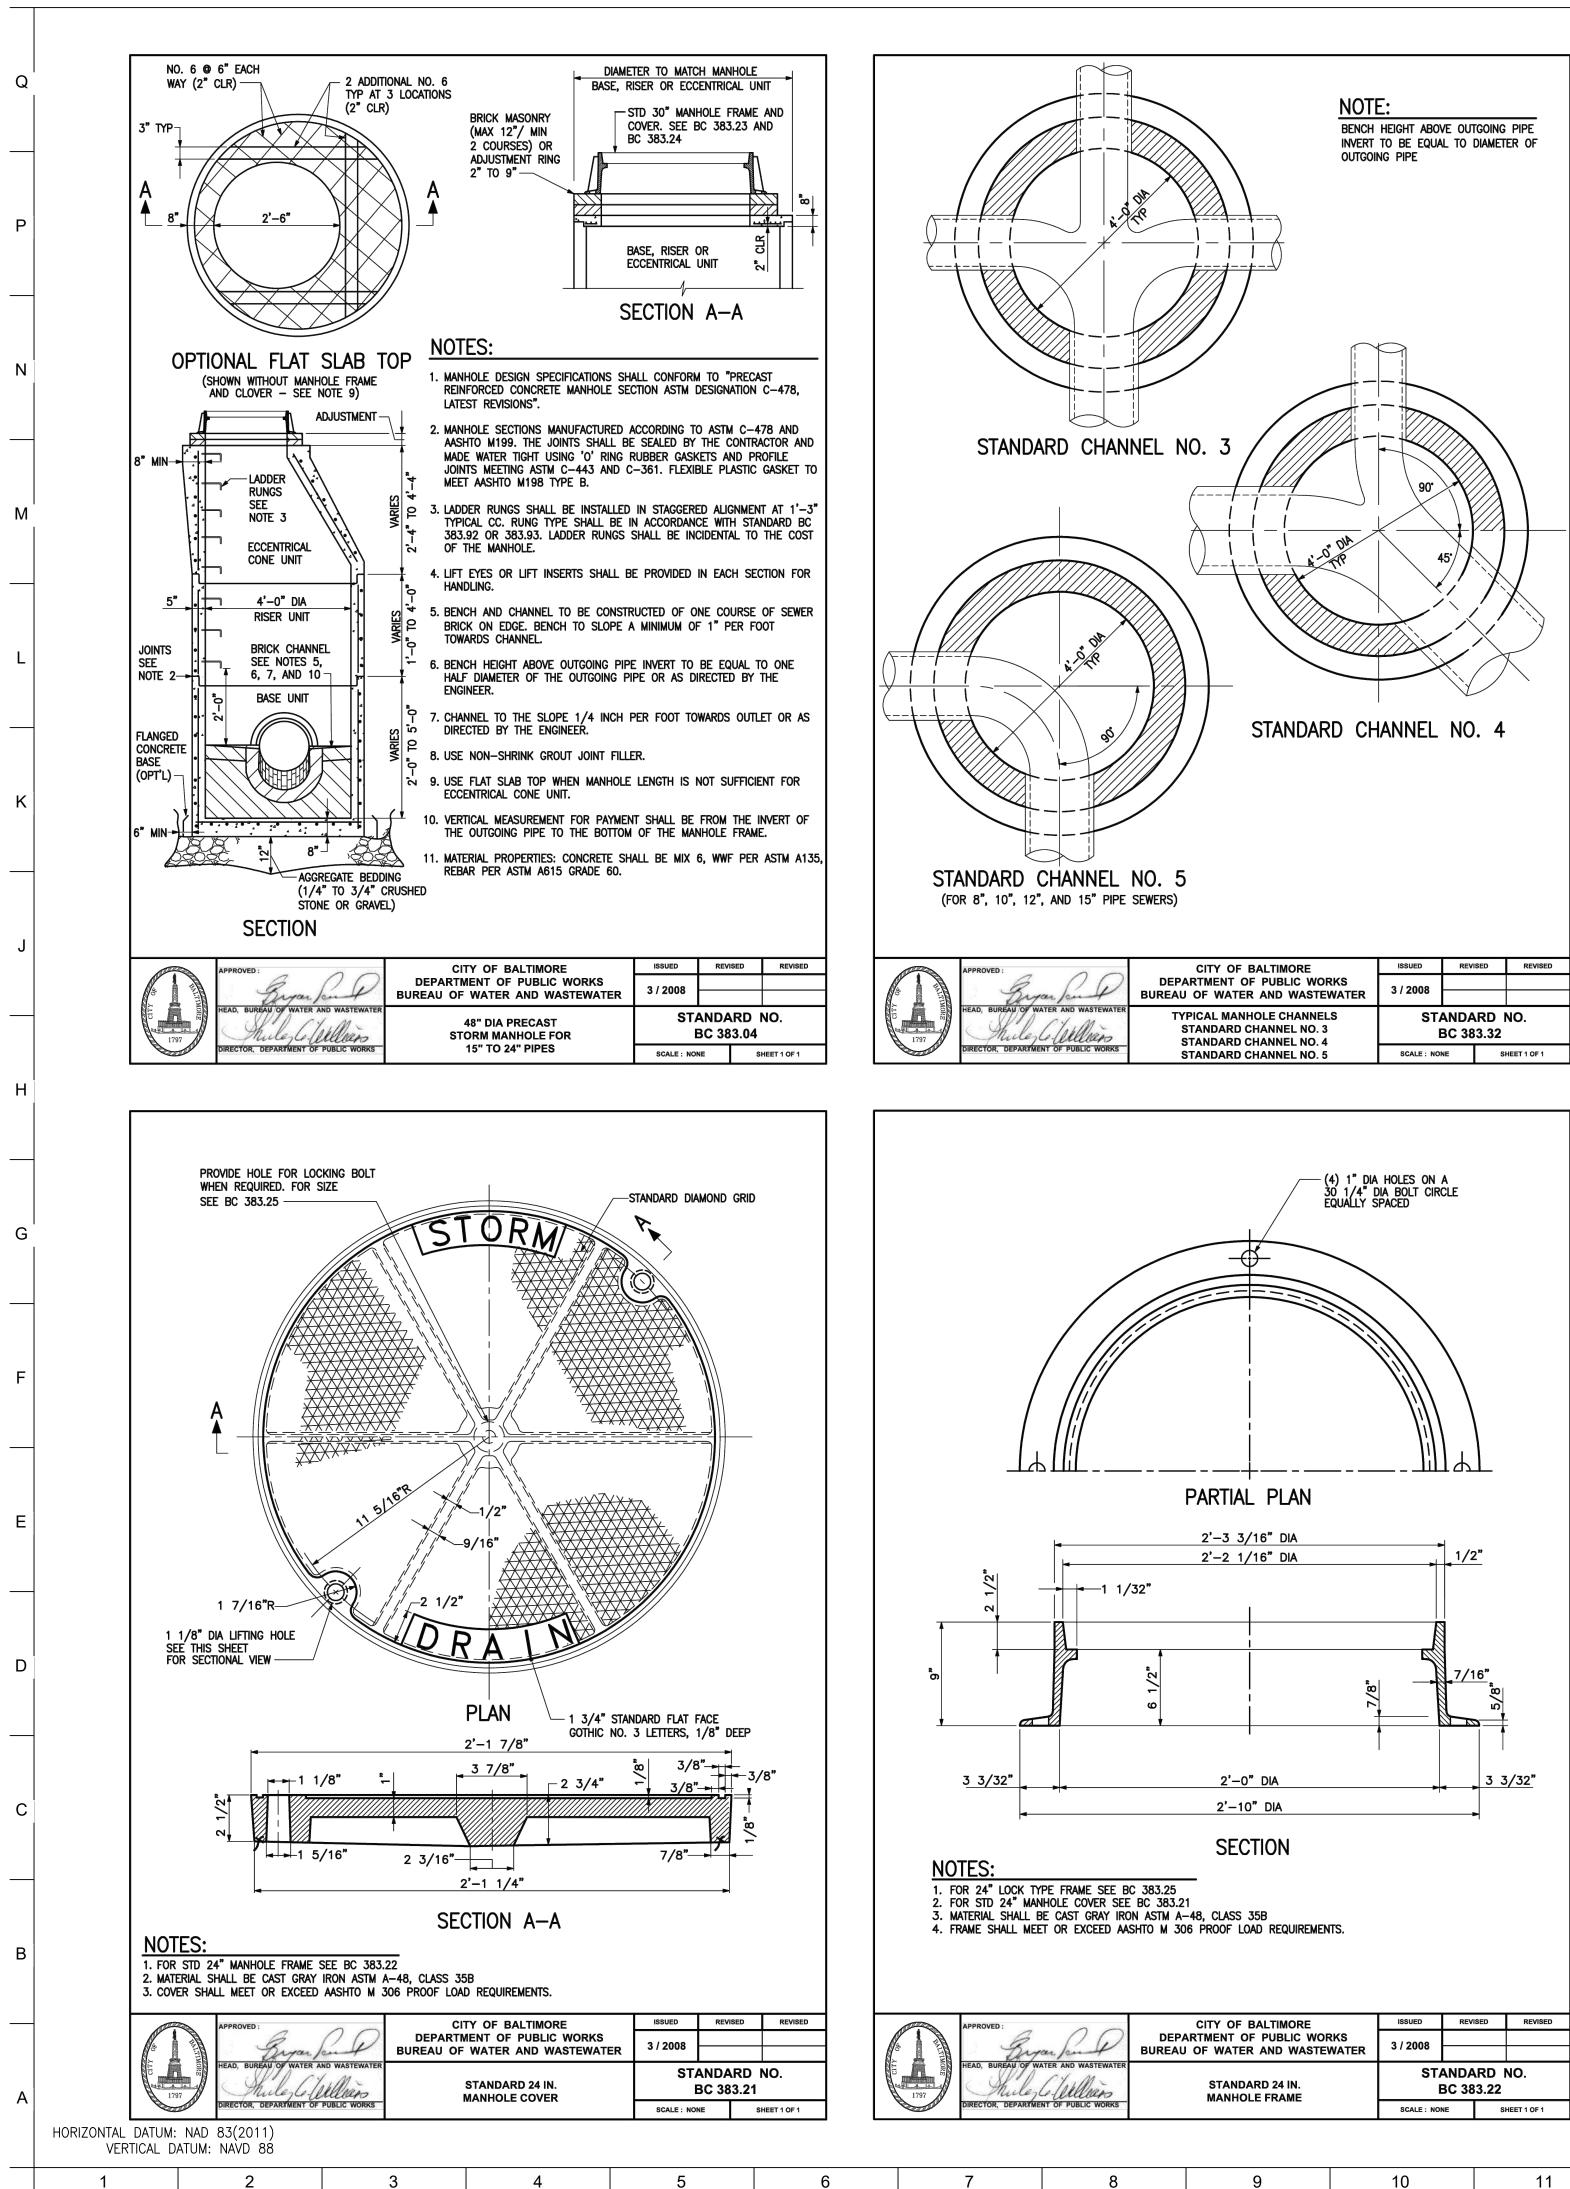

-	CITY OF BALTIMORE	ISSUED	REVISED	REVISED
yan for P	DEPARTMENT OF PUBLIC WORKS BUREAU OF WATER AND WASTEWATER			
WATER AND WASTEWATER	STANDARD 24 IN. MANHOLE FRAME	STANDARD NO. BC 383.22		
TMENT OF PUBLIC WORKS		SCALE : NONE		HEET 1 OF 1

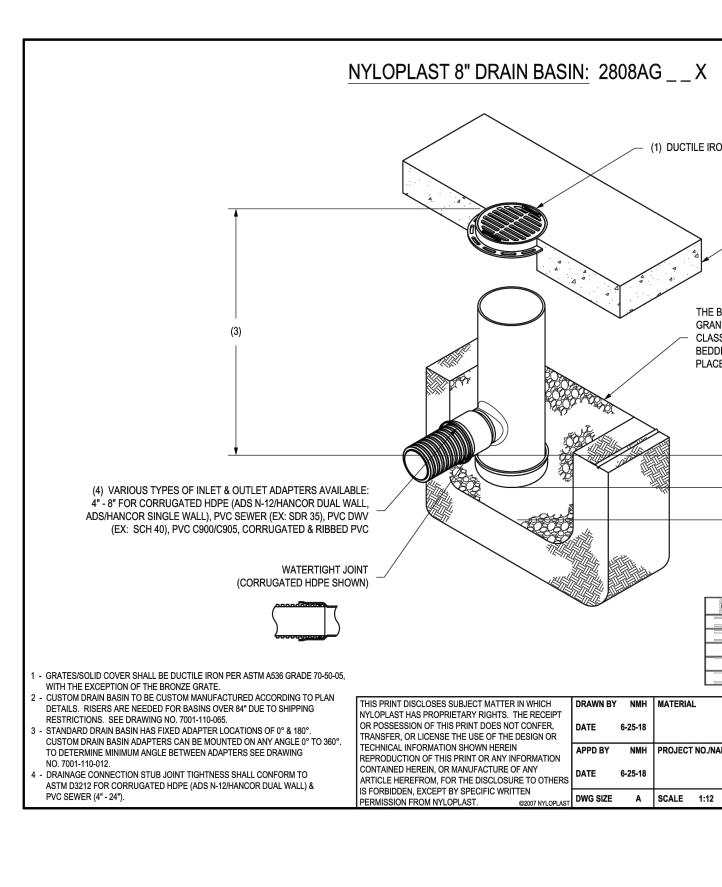


12

13

14


15

		BKP
		PROJECT TEAM:
		<u>ARCHITECT:</u> BUELL KRATZER POWELL, P.C. 1525 LOCUST STREET PHILADELPHIA, PA 19102 T: 215.557.6509
<u>OW</u>	<u>NER / DEVELOPER/ APPLICANT</u> : MARYLAND ZOO IN BALTIMORE	<u>CIVIL ENGINEER:</u> CARROLL ENGINEERING, INC 215 SCHILLING CIRCLE, STE 102 HUNT VALLEY, MD 21031 T: 410.785.7423
	1876 MANSION HOUSE DRIVE BALTIMORE MD 21217 CONTACT: MR. KARL KRANZ PHONE: 443–552–3350	LANDSCAPE ARCHITECT: ROBINSON ANDERSON SUMMERS 28 WEST STATE STREET MEDIA, PA 19063 T: 302.888.1544
		<u>STRUCTURAL ENGINEER:</u> STRUCTURAL DESIGN STUDIO, INC 2225 EAST MURRAY HOLLADAY RD SALT LAKE CITY, UT 84117 T: 801.274.3950
		MEP ENGINEER: KOVACS, WHITNEY & ASSOCIATES 190 WEST OSTEND ST, STE 300 BALTIMORE, MD 21230 T: 410.244.7191
		CLIENT:
		THE MARYLAND ZOO IN BALTIMORE 1 SAFARI PLACE BALTIMORE, MD 21217
		<b>VD ZOO</b> ND ZOO ORE LACE AD 21217
		PAND ALTIMO ARI PLA RE, MD
		<b>RED P</b> E MARY IN BALT I SAFAR TIMORE
X		BAL TH
_ ^		THIS DRAWING IS TO ILLUSTRATE THE WORK TO BE DONE. THE ARCHITECT IS NOT RESPONSIBLE FOR THE MEANS, METHODS, TECHNIQUES, SEQUENCES, AND PROCEDURES USED TO DO THE WORK OR THE SAFETY ASPECTS OF
TILE IRON GRATE		CONSTRUCTION, AND NOTHING ON THIS DRAWING EXPRESSED OR IMPLIED CHANGES THIS CONDITION. CONTRACTOR SHALL BE RESPONSIBLE FOR KNOWING HOW THEY AFFECT THE WORK. SUBMITTAL OF A BID TO PERFORM THIS WORK IS AN ACKNOWLEDGEMENT OF THESE RESPONSIBILITIES, AND THAT THEY HAVE BEEN FULLY CONSIDERED IN PLANNING OF THE WORK, AND THE BID PRICE. NO CLAIMS FOR EXTRA CHARGES DUE TO
CONCRETE WALKWAY OR DECK		SEAL:
THE BACKFILL MATERIAL SHALL BE CRUSHED STONE OR OTHER GRANULAR MATERIAL MEETING THE REQUIREMENTS OF CLASS I, - CLASS II, OR CLASS III MATERIAL AS DEFINED IN ASTM D2321. BEDDING & BACKFILL FOR SURFACE DRAINAGE INLETS SHALL BE PLACED & COMPACTED UNIFORMLY IN ACCORDANCE WITH ASTM D2321.		P P R A C Y A C Y L		PROFESSIONAL CERTIFICATION. I HEREBY CERTIFY THAT THESE DOCUMENTS WERE PREPARED OR APPROVED BY ME, AND THAT I AM A DULY LICENSED PROFESSIONAL ENGINEER UNDER THE LAWS OF THE STATE OF MARYLAND, LICENSE NO. 14446, EXPIRATION DATE 5/25/25.
VARIABLE SUMP DEPTH ACCORDING TO PLANS (6" MIN. BASED ON (6" MIN. BASED ON MANUFACTURING REQ.)		DATE: JANUARY 14, 2025
		PROJECT NO: 2023-10.04 DRAWN BY MJE CHECKED BY CMS
GRATE OPTIONS LOAD RATING PART # STANDARD LIGHT DUTY 0899CGSF		CHECKED BYCMSSUBMISSIONDATEBID SET01/14/2025
SOLID COVER      LIGHT DUTY      0899CGCF        BRONZE      N/A      0899CGBF        DOME      N/A      0899CGDF        DROP IN GRATE      LIGHT DUTY      0801DI		
IAL STANDARE INTITE INTITE REVISION DATE
TITLE      8 IN DRAIN BASIN QUICK SPEC INSTALLATION DETAIL      1:12    SHEET    1 OF 1    DWG NO.    7001-110-272    REV    F		DRAWING TITLE:
		STORM DRAIN DETAILS
		DRAWING NO:
	BCNR # 11545	C520
17 18	19 20	

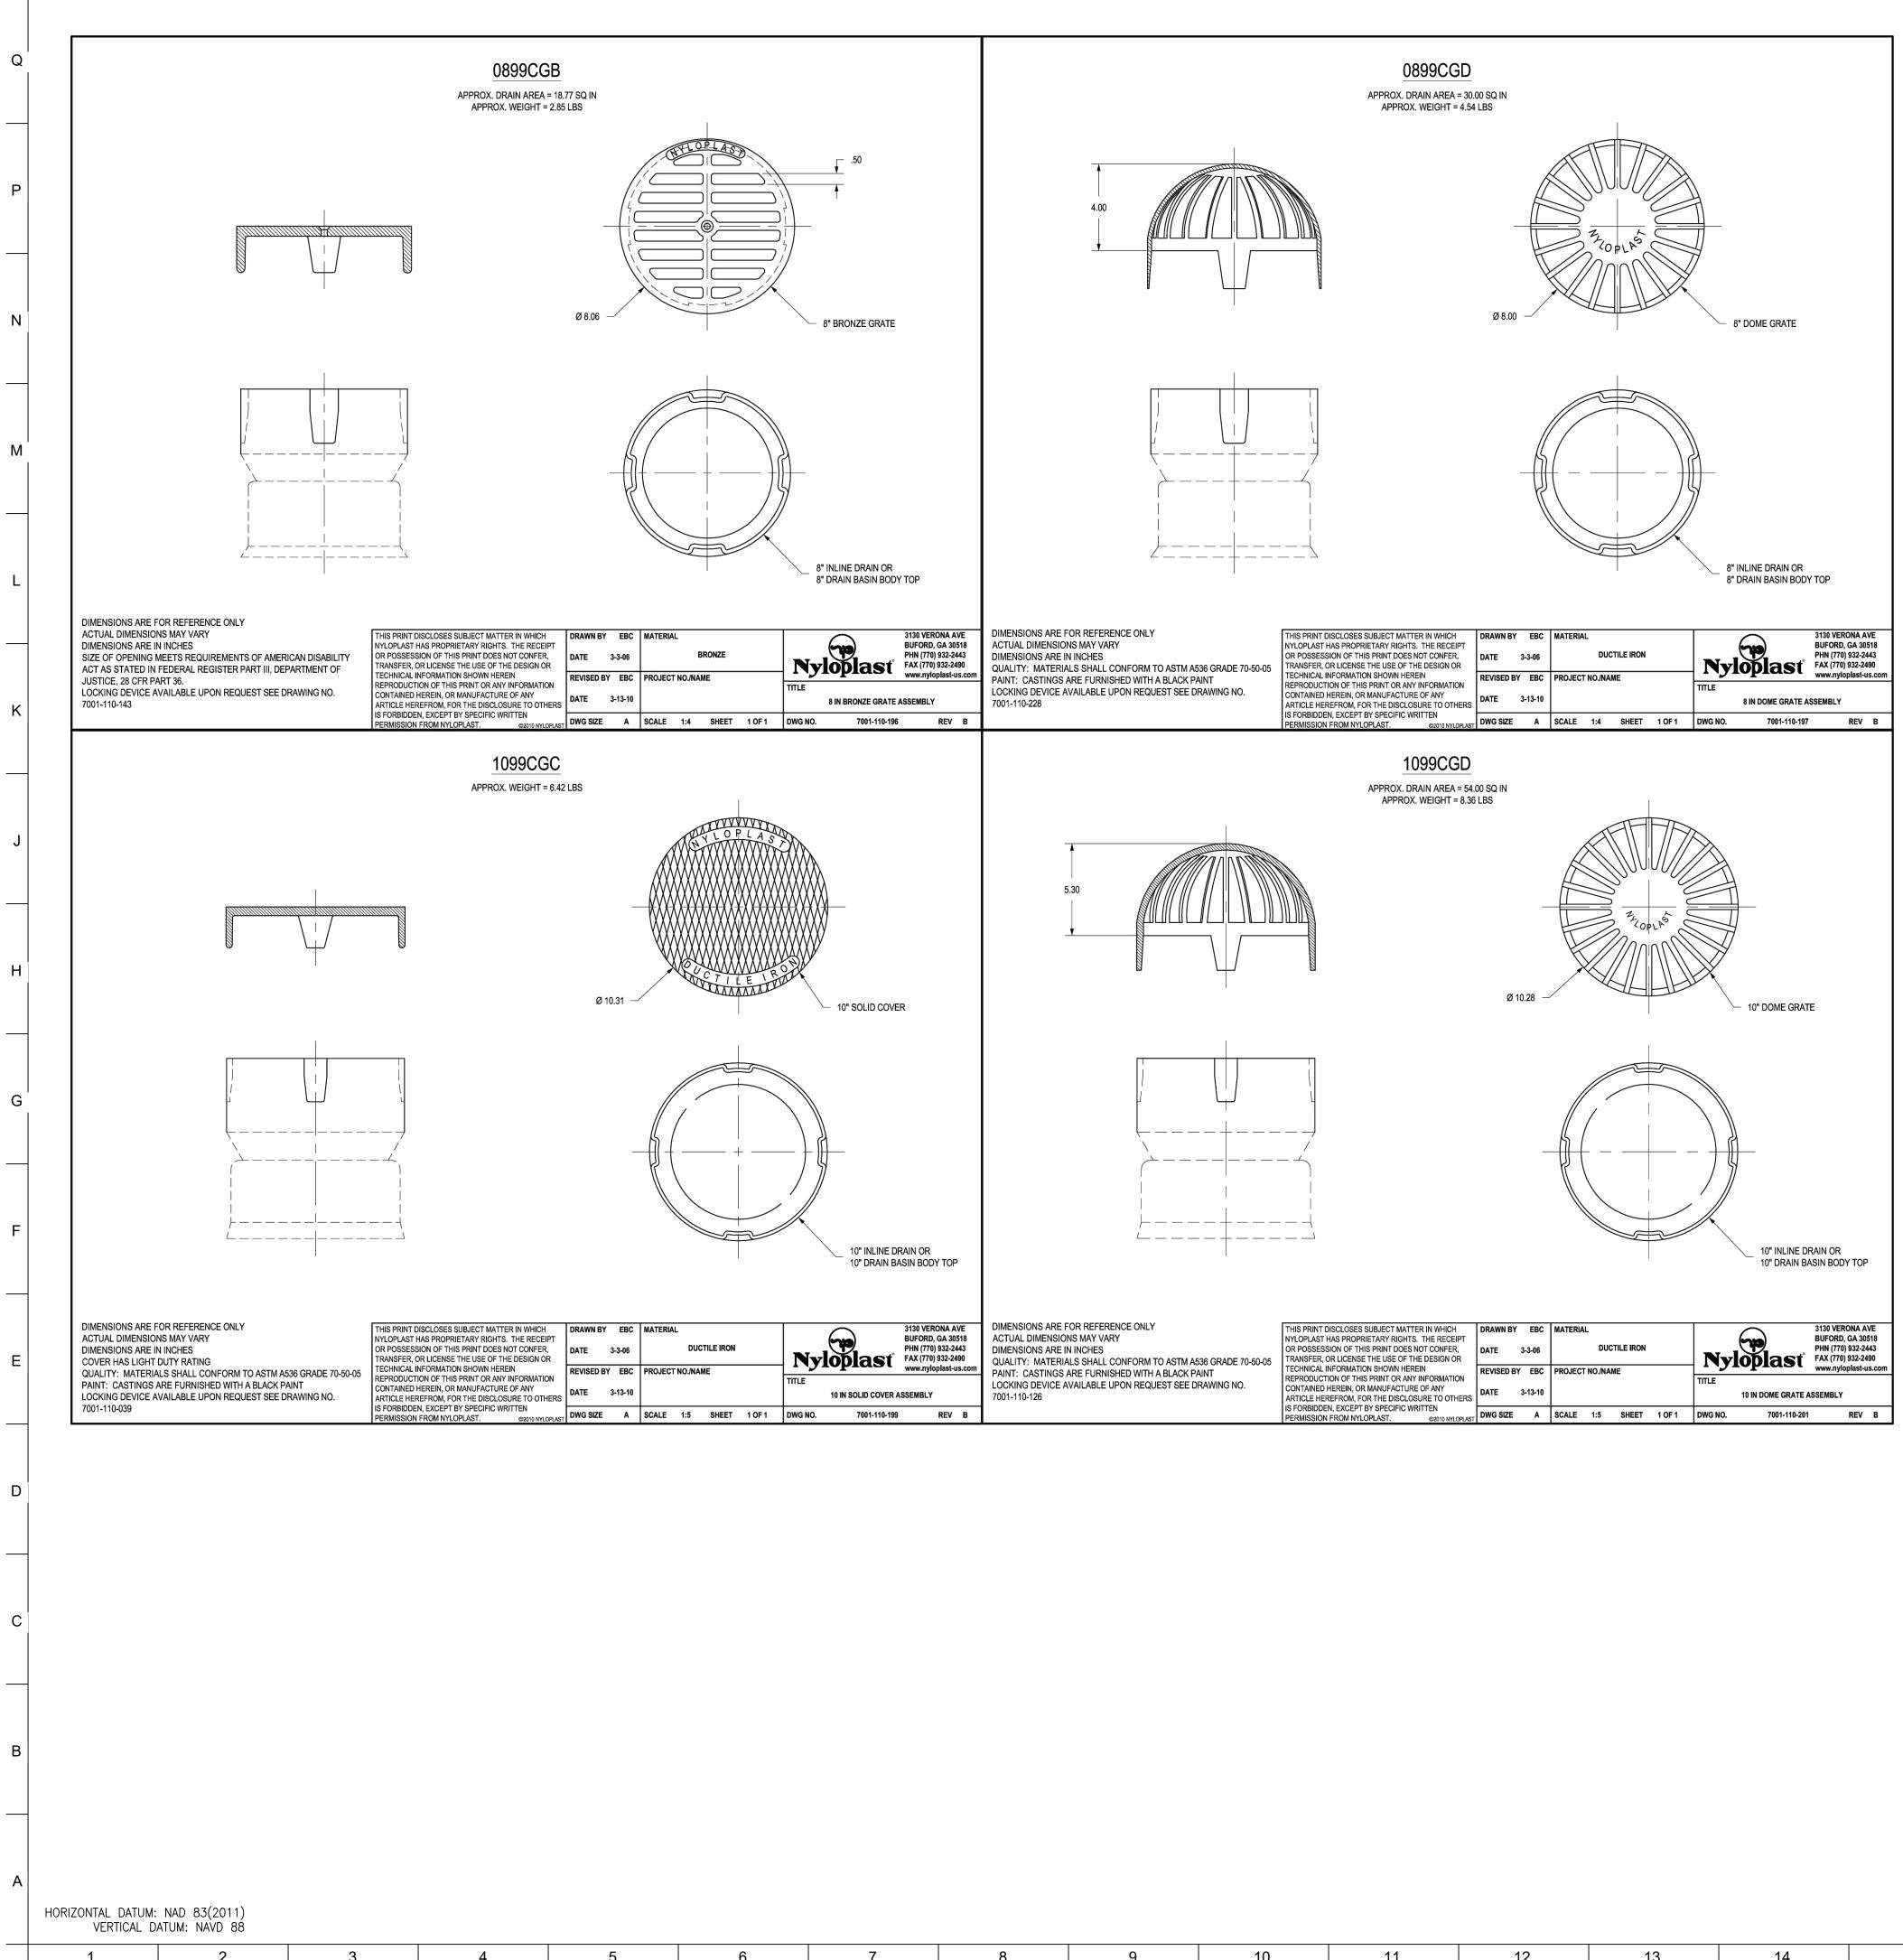


	$\frown$	
	ВКР	)
F	ROJECT TEAM:	
	ARCHITEC BUELL KRATZER PO	WELL, P.C.
	1525 LOCUST S PHILADELPHIA, F T: 215.557.6	PA 19102
	<u>CIVIL ENGINE</u> CARROLL ENGINEE 215 SCHILLING CIRC HUNT VALLEY, M T: 410.785.74	ERING, INC LE, STE 102 ID 21031
F	LANDSCAPE ARC OBINSON ANDERSO 28 WEST STATE MEDIA, PA 19 T: 302.888.1	N SUMMERS STREET 9063
	STRUCTURAL EN TRUCTURAL DESIGN 225 EAST MURRAY H SALT LAKE CITY, T: 801.274.3	I STUDIO, INC IOLLADAY RD UT 84117
к	MEP ENGINE OVACS, WHITNEY & 7 190 WEST OSTEND S BALTIMORE, ME T: 410.244.7	ASSOCIATES ST, STE 300 0 21230
	CLIENT:	
	MARYLAN	D ZQO
	HE MARYLAND ZOO II 1 SAFARI PLA BALTIMORE, MD	CE
	· · · · · · · · · · · · · · · · · · ·	
	RED PANDA      THE MARYLAND ZOO      IN BALTIMORE      IN CALADI DI ACE	MD 21217
	A I I M N D I I M N D I I M N N I I N N N N N N N N N N N N N	Ì₩ , ₩
	<b>d P.</b> Aryi Balt	ORE, N
	Η Η	BAI
	THIS DRAWING IS TO ILLUSTRATE THE WO ARCHITECT IS NOT RESPONSIBLE FO METHODS, TECHNIQUES, SEQUENCES, J USED TO DO THE WORK OR THE SAFE CONSTRUCTION, AND NOTHING ON THIS I DR IMPLIED CHANGES THIS CONDITION. C RESPONSIBLE FOR KNOWING HOW THEY SUBMITTAL OF A BID TO PERFORM TI ACKNOWLEDGEMENT OF THESE RESPONSIB HAVE BEEN FULLY CONSIDERED IN PLANI AND THE BID PRICE. NO CLAIMS FOR EXTR THESE CONDITIONS WILL BE FOR	DR THE MEANS, AND PROCEDURES ETY ASPECTS OF DRAWING EXPRESSED ONTRACTOR SHALL BE ' AFFECT THE WORK. HIS WORK IS AN HILTIES, AND THAT THEY NING OF THE WORK, RA CHARGES DUE TO
S	EAL:	uun.
	P P X	
	REDSTERES	
	PROFESSIONAL CERTIFICATION. I HEF THAT THESE DOCUMENTS WERE PRE APPROVED BY ME, AND THAT I AM A L PROFESSIONAL ENGINEER UNDER TH STATE OF MARYLAND, LICENSE NO. 1	PARED OR DULY LICENSED IE LAWS OF THE
		125
P	OATE: JANUARY 14, 20 ROJECT NO: 2023-10	.04
C	DRAWN BY CHECKED BY	MJE CMS
	UBMISSION ID SET	DATE 01/14/2025
R	EVISION	DATE
	DRAWING TITLE: STORM DR	AIN
	DETAILS	5
		Г
	C52	

OWNER / DEVELOPER/ APPLICANT: MARYLAND ZOO IN BALTIMORE 1876 MANSION HOUSE DRIVE BALTIMORE MD 21217 CONTACT: MR. KARL KRANZ PHONE: 443-552-3350

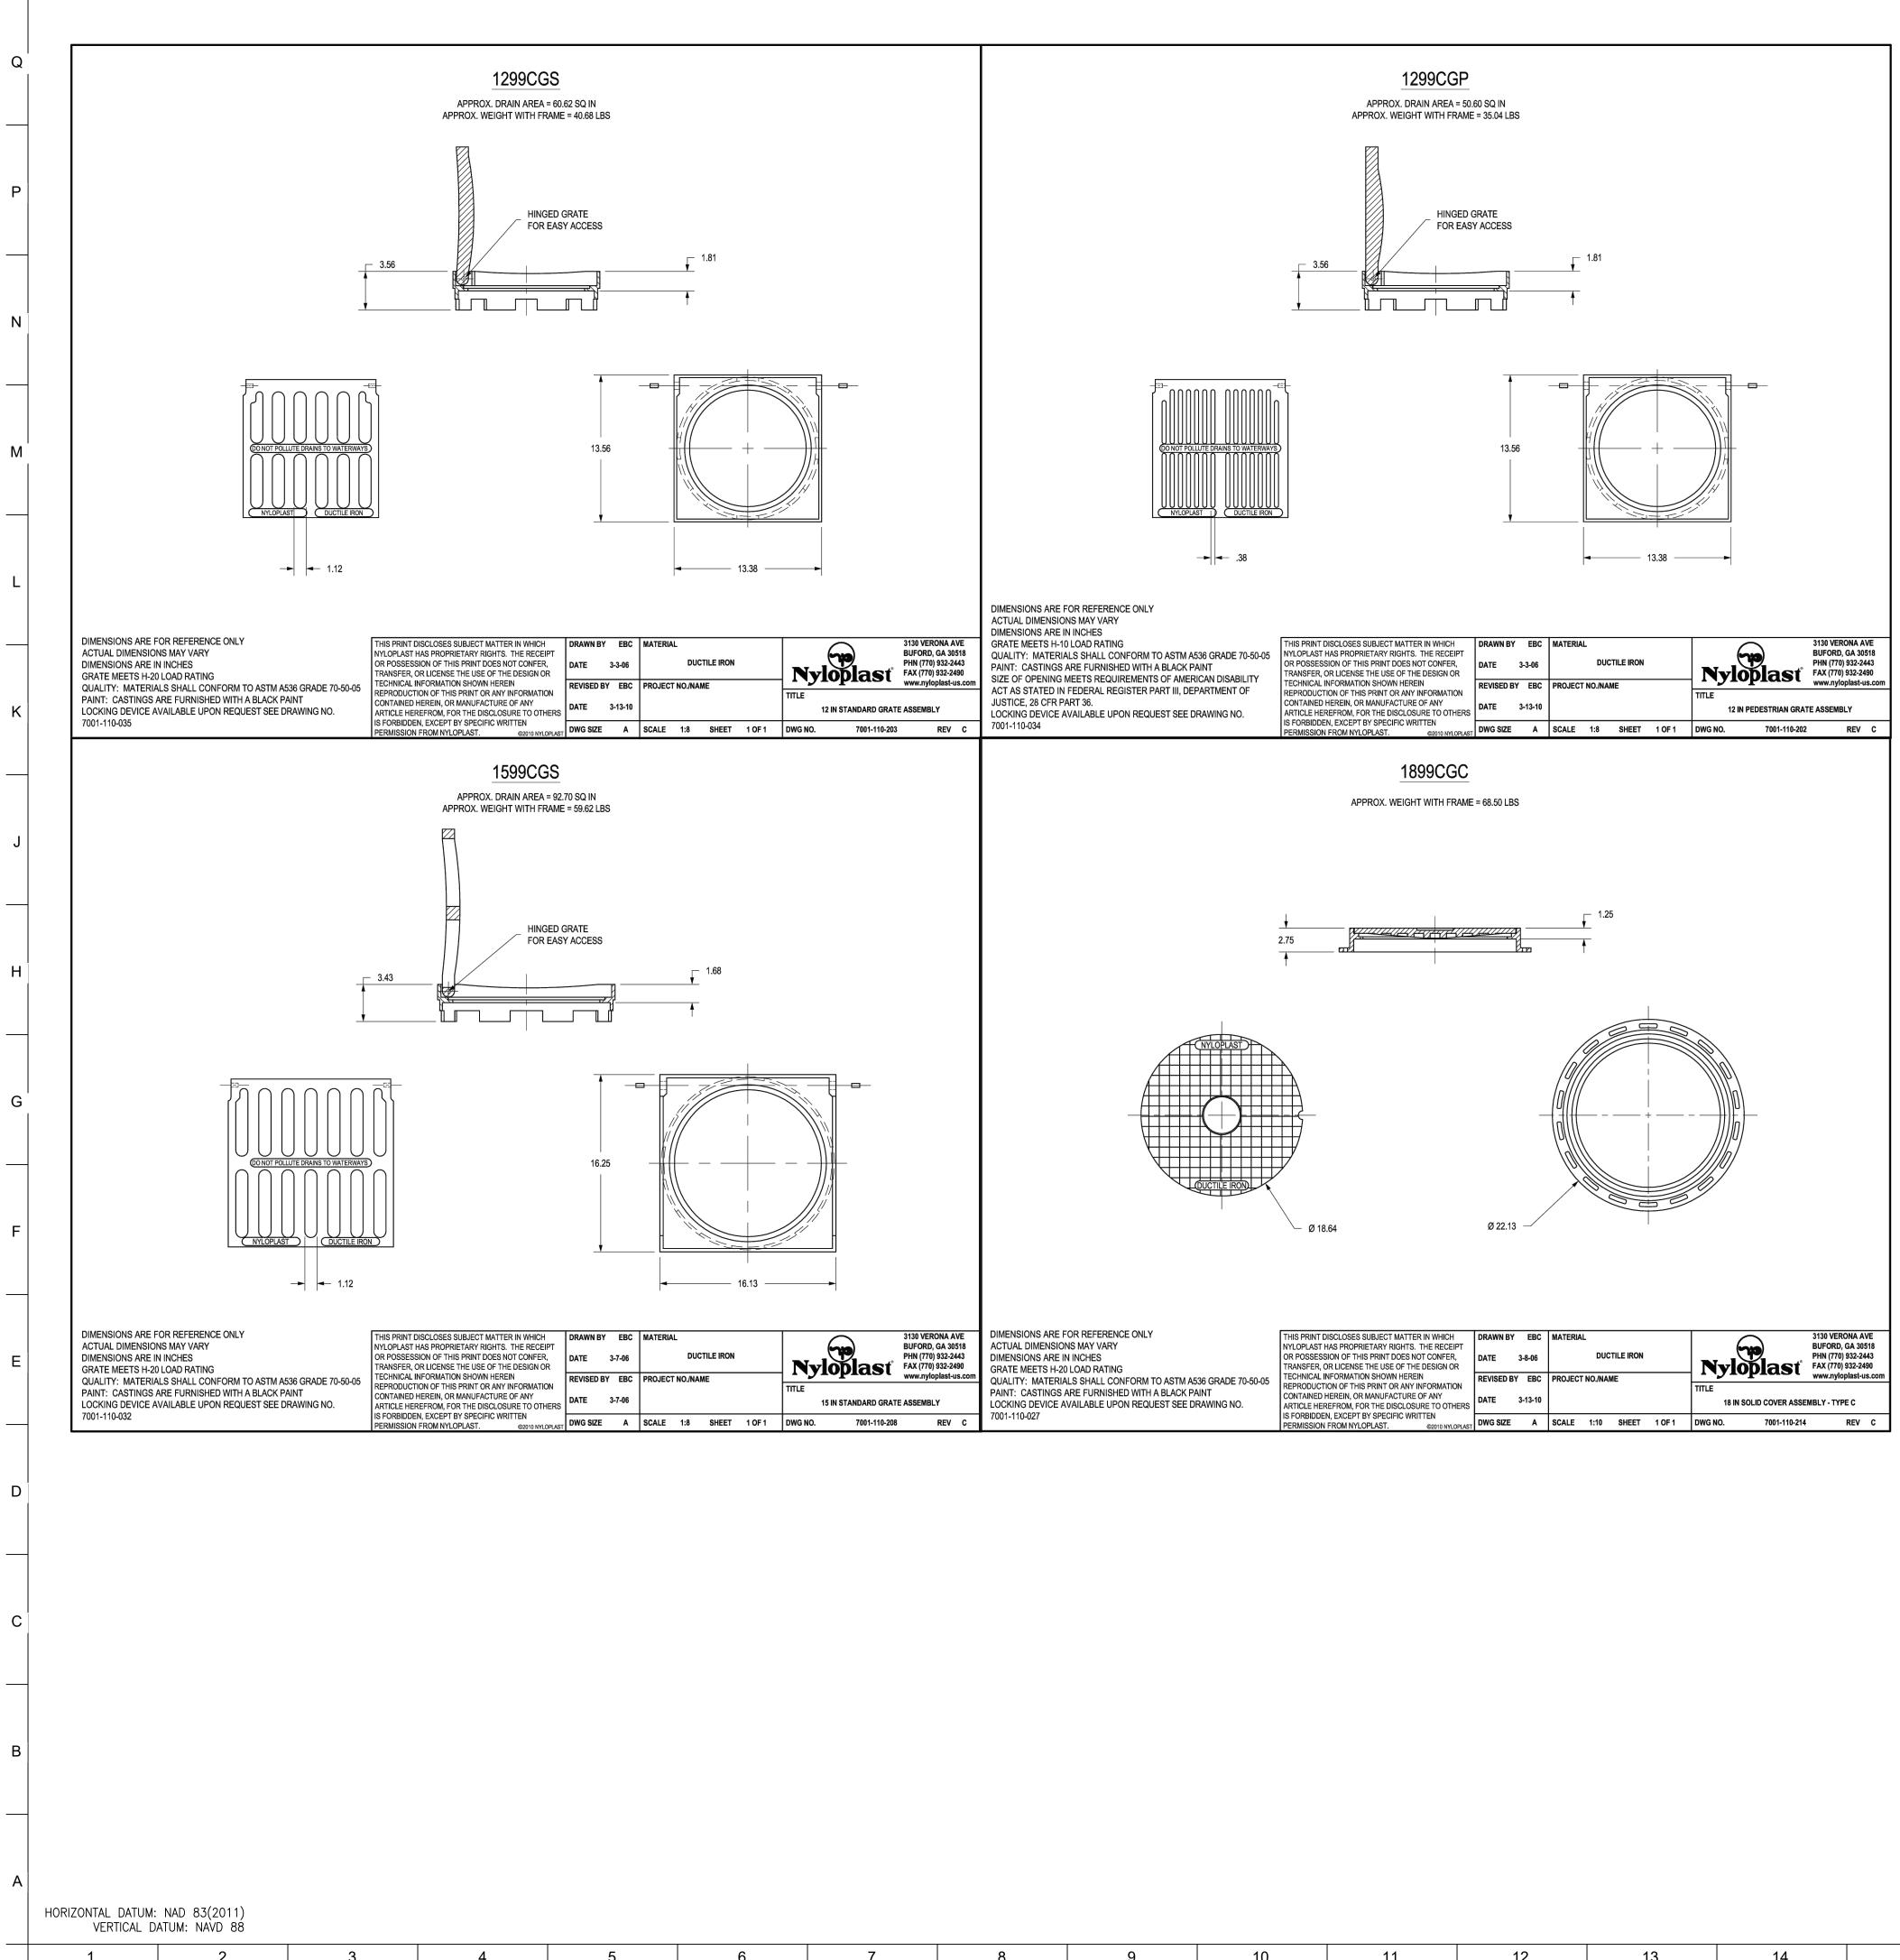

$\frown$	
ВКР	)
PROJECT TEAM:	
ARCHITEC	T:
BUELL KRATZER PO 1525 LOCUST S	<b>IREE</b> T
PHILADELPHIA, P T: 215.557.65	
<u>CIVIL ENGINE</u> CARROLL ENGINEE	
215 SCHILLING CIRC HUNT VALLEY, M	LE, STE 102
T: 410.785.74 LANDSCAPE ARC	
ROBINSON ANDERSO 28 WEST STATE S	N SUMMERS
MEDIA, PA 19 T: 302.888.15	063
STRUCTURAL EN STRUCTURAL DESIGN	
2225 EAST MURRAY H SALT LAKE CITY, U	OLLADAY RD
T: 801.274.39	950
MEP ENGINE KOVACS, WHITNEY & A	<b>ASS</b> OCIATES
190 WEST OSTEND S BALTIMORE, MD T: 410.244.7	21230
	. • 1
CLIENT: MARYLANI	חחק ר
IVIARULAINI THE MARYLAND ZOO IN	•
1 SAFARI PLA BALTIMORE, MD	CE
RED PANDA THE MARYLAND ZOO IN BALTIMORE	212
EED PANDA MARYLAND 20 IN BALTIMORE	
	. ∠ 2 ш`
D P BAL BAL	ORI
	TIM
	3AL
THIS DRAWING IS TO ILLUSTRATE THE WOR ARCHITECT IS NOT RESPONSIBLE FO METHODS, TECHNIQUES, SEQUENCES, A USED TO DO THE WORK OR THE SAFE CONSTRUCTION, AND NOTHING ON THIS DO OR IMPLIED CHANGES THIS CONDITION. CC RESPONSIBLE FOR KNOWING HOW THEY SUBMITAL OF A BID TO PERFORM TH ACKNOWLEDGEMENT OF THESE RESPONSIB HAVE BEEN FULLY CONSIDERED IN PLANN AND THE BID PRICE. NO CLAIMS FOR EXTR	K TO BE DONE. THE R THE MEANS, ND PROCEDURES TY ASPECTS OF RAWING EXPRESSED DNTRACTOR SHALL BE AFFECT THE WORK. IS WORK IS AN LITIES, AND THAT THEY ING OF THE WORK, A CHARGES DUE TO
THESE CONDITIONS WILL BE FORT	HCOMING.
MUMUMUM OF MARY	
PR	
NO 14446 PEOSTERED	
PROFESSIONAL CERTIFICATION. I HER THAT THESE DOCUMENTS WERE PREF	ARED OR
APPROVED BY ME, AND THAT I AM A D PROFESSIONAL ENGINEER UNDER THI STATE OF MARYLAND, LICENSE NO. 14 EXPIRATION DATE 5/25/25 .	LAWS OF THE
DATE: JANUARY 14, 20	25
PROJECT NO: 2023-10. DRAWN BY	
CHECKED BY	CMS
SUBMISSION BID SET	DATE 01/14/2025
REVISION	DATE
DRAWING TITLE:	
Storm Dr. Details	
DRAWING NO:	
(5)	2
	<b></b>

OWNER / DEVELOPER/ APPLICANT: MARYLAND ZOO IN BALTIMORE 1876 MANSION HOUSE DRIVE BALTIMORE MD 21217 CONTACT: MR. KARL KRANZ PHONE: 443-552-3350

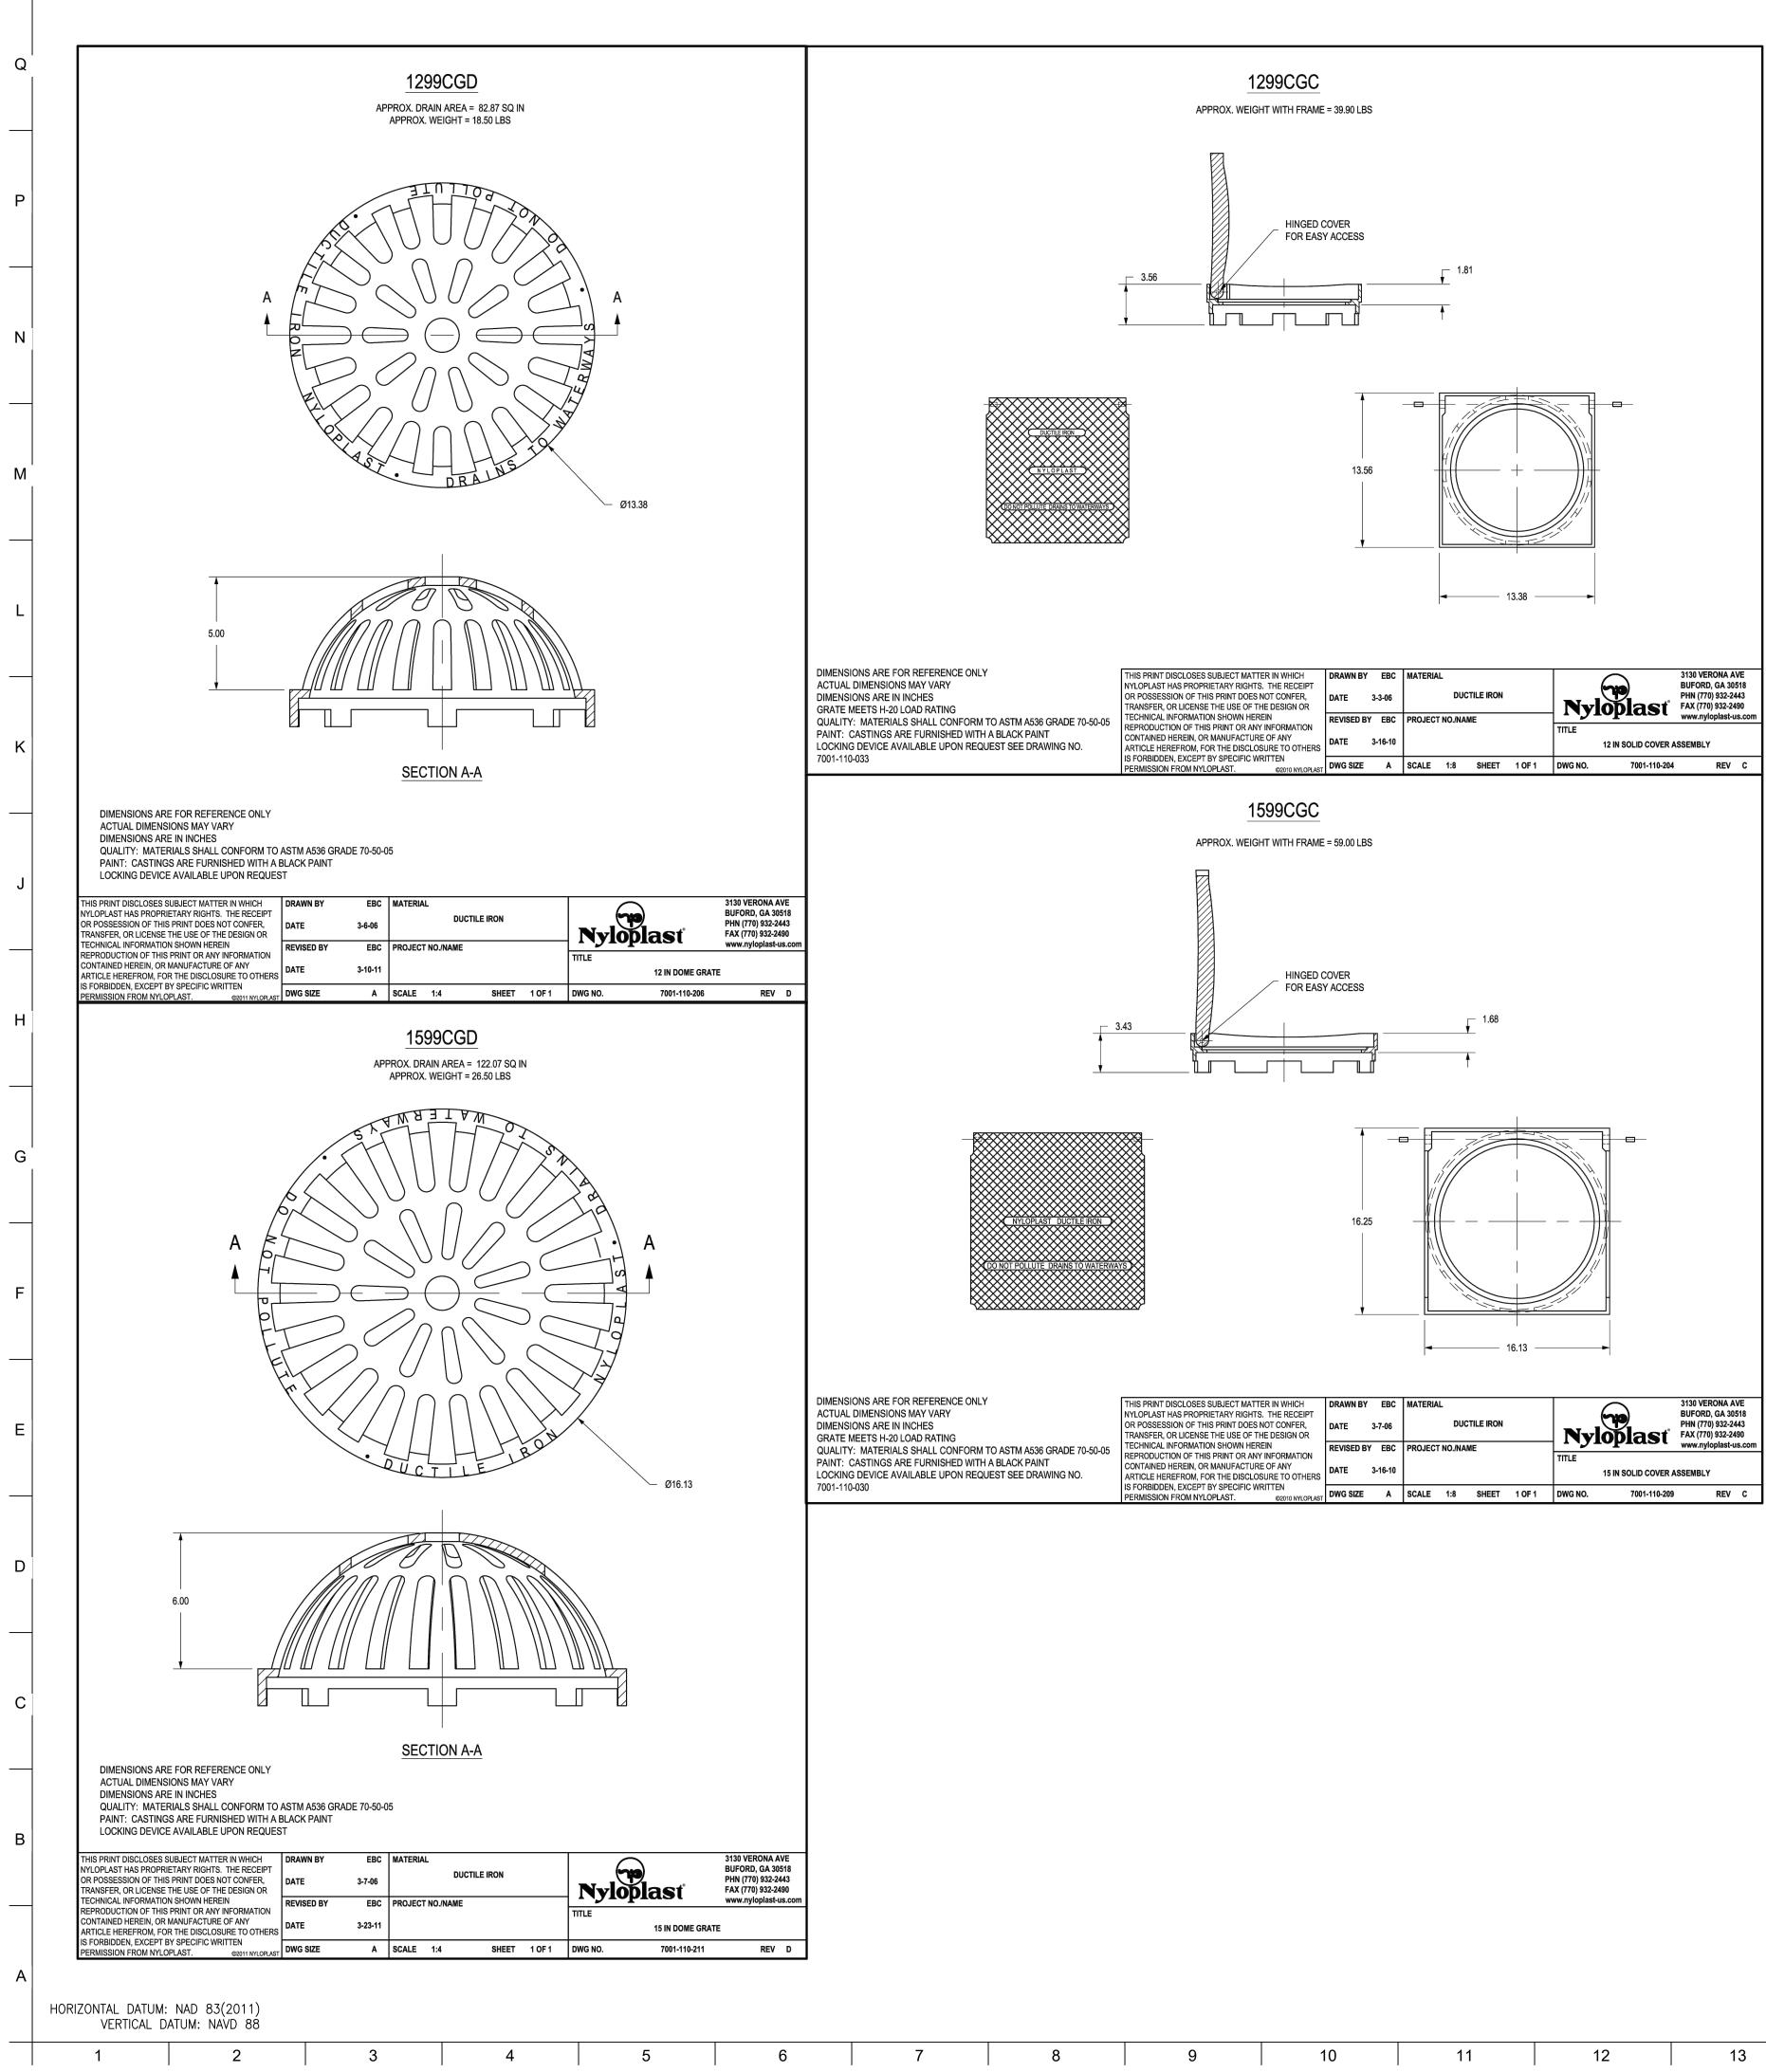


BKP	
PROJECT TEAM:	
ARCHITEC	-
T: 215.557.6	STREET PA 19102
CIVIL ENGIN CARROLL ENGINE 215 SCHILLING CIRC HUNT VALLEY, M T: 410.785.7	ERING, INC CLE, STE 102 MD 21031
LANDSCAPE AR ROBINSON ANDERS 28 WEST STATE MEDIA, PA 1 T: 302.888.7	ON SUMMERS STREET 9063
STRUCTURAL EI STRUCTURAL DESIG 2225 EAST MURRAY SALT LAKE CITY,	N STUDIO, INC HOLLADAY RD UT 84117
T: 801.274.3 <u>MEP ENGIN</u> KOVACS, WHITNEY & 190 WEST OSTEND BALTIMORE, M	<u>EER:</u> ASSOCIATES ST, STE 300
T: 410.244.7	
CLIENT: MARYLAN	ח 700
THE MARYLAND ZOO 1 SAFARI PL BALTIMORE, MI	IN BALTIMORE ACE
Q	217
RED PANDA THE MARYLAND ZOO IN BALTIMORE	PLACE MD 2121
RED PANDA MARYLAND ZO IN BALTIMORE	, MD
DP.	ore, i
	LTIM
	BA
THIS DRAWING IS TO ILLUSTRATE THE W ARCHITECT IS NOT RESPONSIBLE METHODS, TECHNIQUES, SEQUENCESS USED TO DO THE WORK OR THE SA CONSTRUCTION, AND NOTHING ON THI OR IMPLIED CHANGES THIS CONDITION. RESPONSIBLE FOR KNOWING HOW TH SUBMITTAL OF A BID TO PERFORM ACKNOWLEDGEMENT OF THESE RESPONS	FOR THE MEANS, 5, AND PROCEDURES SFETY ASPECTS OF S DRAWING EXPRESSED CONTRACTOR SHALL BE EY AFFECT THE WORK. THIS WORK IS AN SIBILITIES, AND THAT THEY
HAVE BEEN FULLY CONSIDERED IN PLA AND THE BID PRICE. NO CLAIMS FOR EX THESE CONDITIONS WILL BE FO	TRA CHARGES DUE TO
DEAL.	
REGISTERE SSIONAL	O
PROFESSIONAL CERTIFICATION. I + THAT THESE DOCUMENTS WERE P APPROVED BY ME, AND THAT I AM, PROFESSIONAL ENGINEER UNDER STATE OF MARYLAND, LICENSE NO EXPIRATION DATE 5/25/25.	REPARED OR A DULY LICENSED THE LAWS OF THE
DATE: JANUARY 14, 2 PROJECT NO: 2023-10	
DRAWN BY CHECKED BY	MJE CMS
SUBMISSION BID SET	DATE 01/14/2025
REVISION	DATE
DRAWING TITLE: STORM DF DETAIL	
	•
DRAWING NO:	
C52	23

<u>OWNER / DEVELOPER/ APPLICANT</u>: MARYLAND ZOO IN BALTIMORE 1876 MANSION HOUSE DRIVE BALTIMORE MD 21217 CONTACT: MR. KARL KRANZ PHONE: 443-552-3350

20

19

17

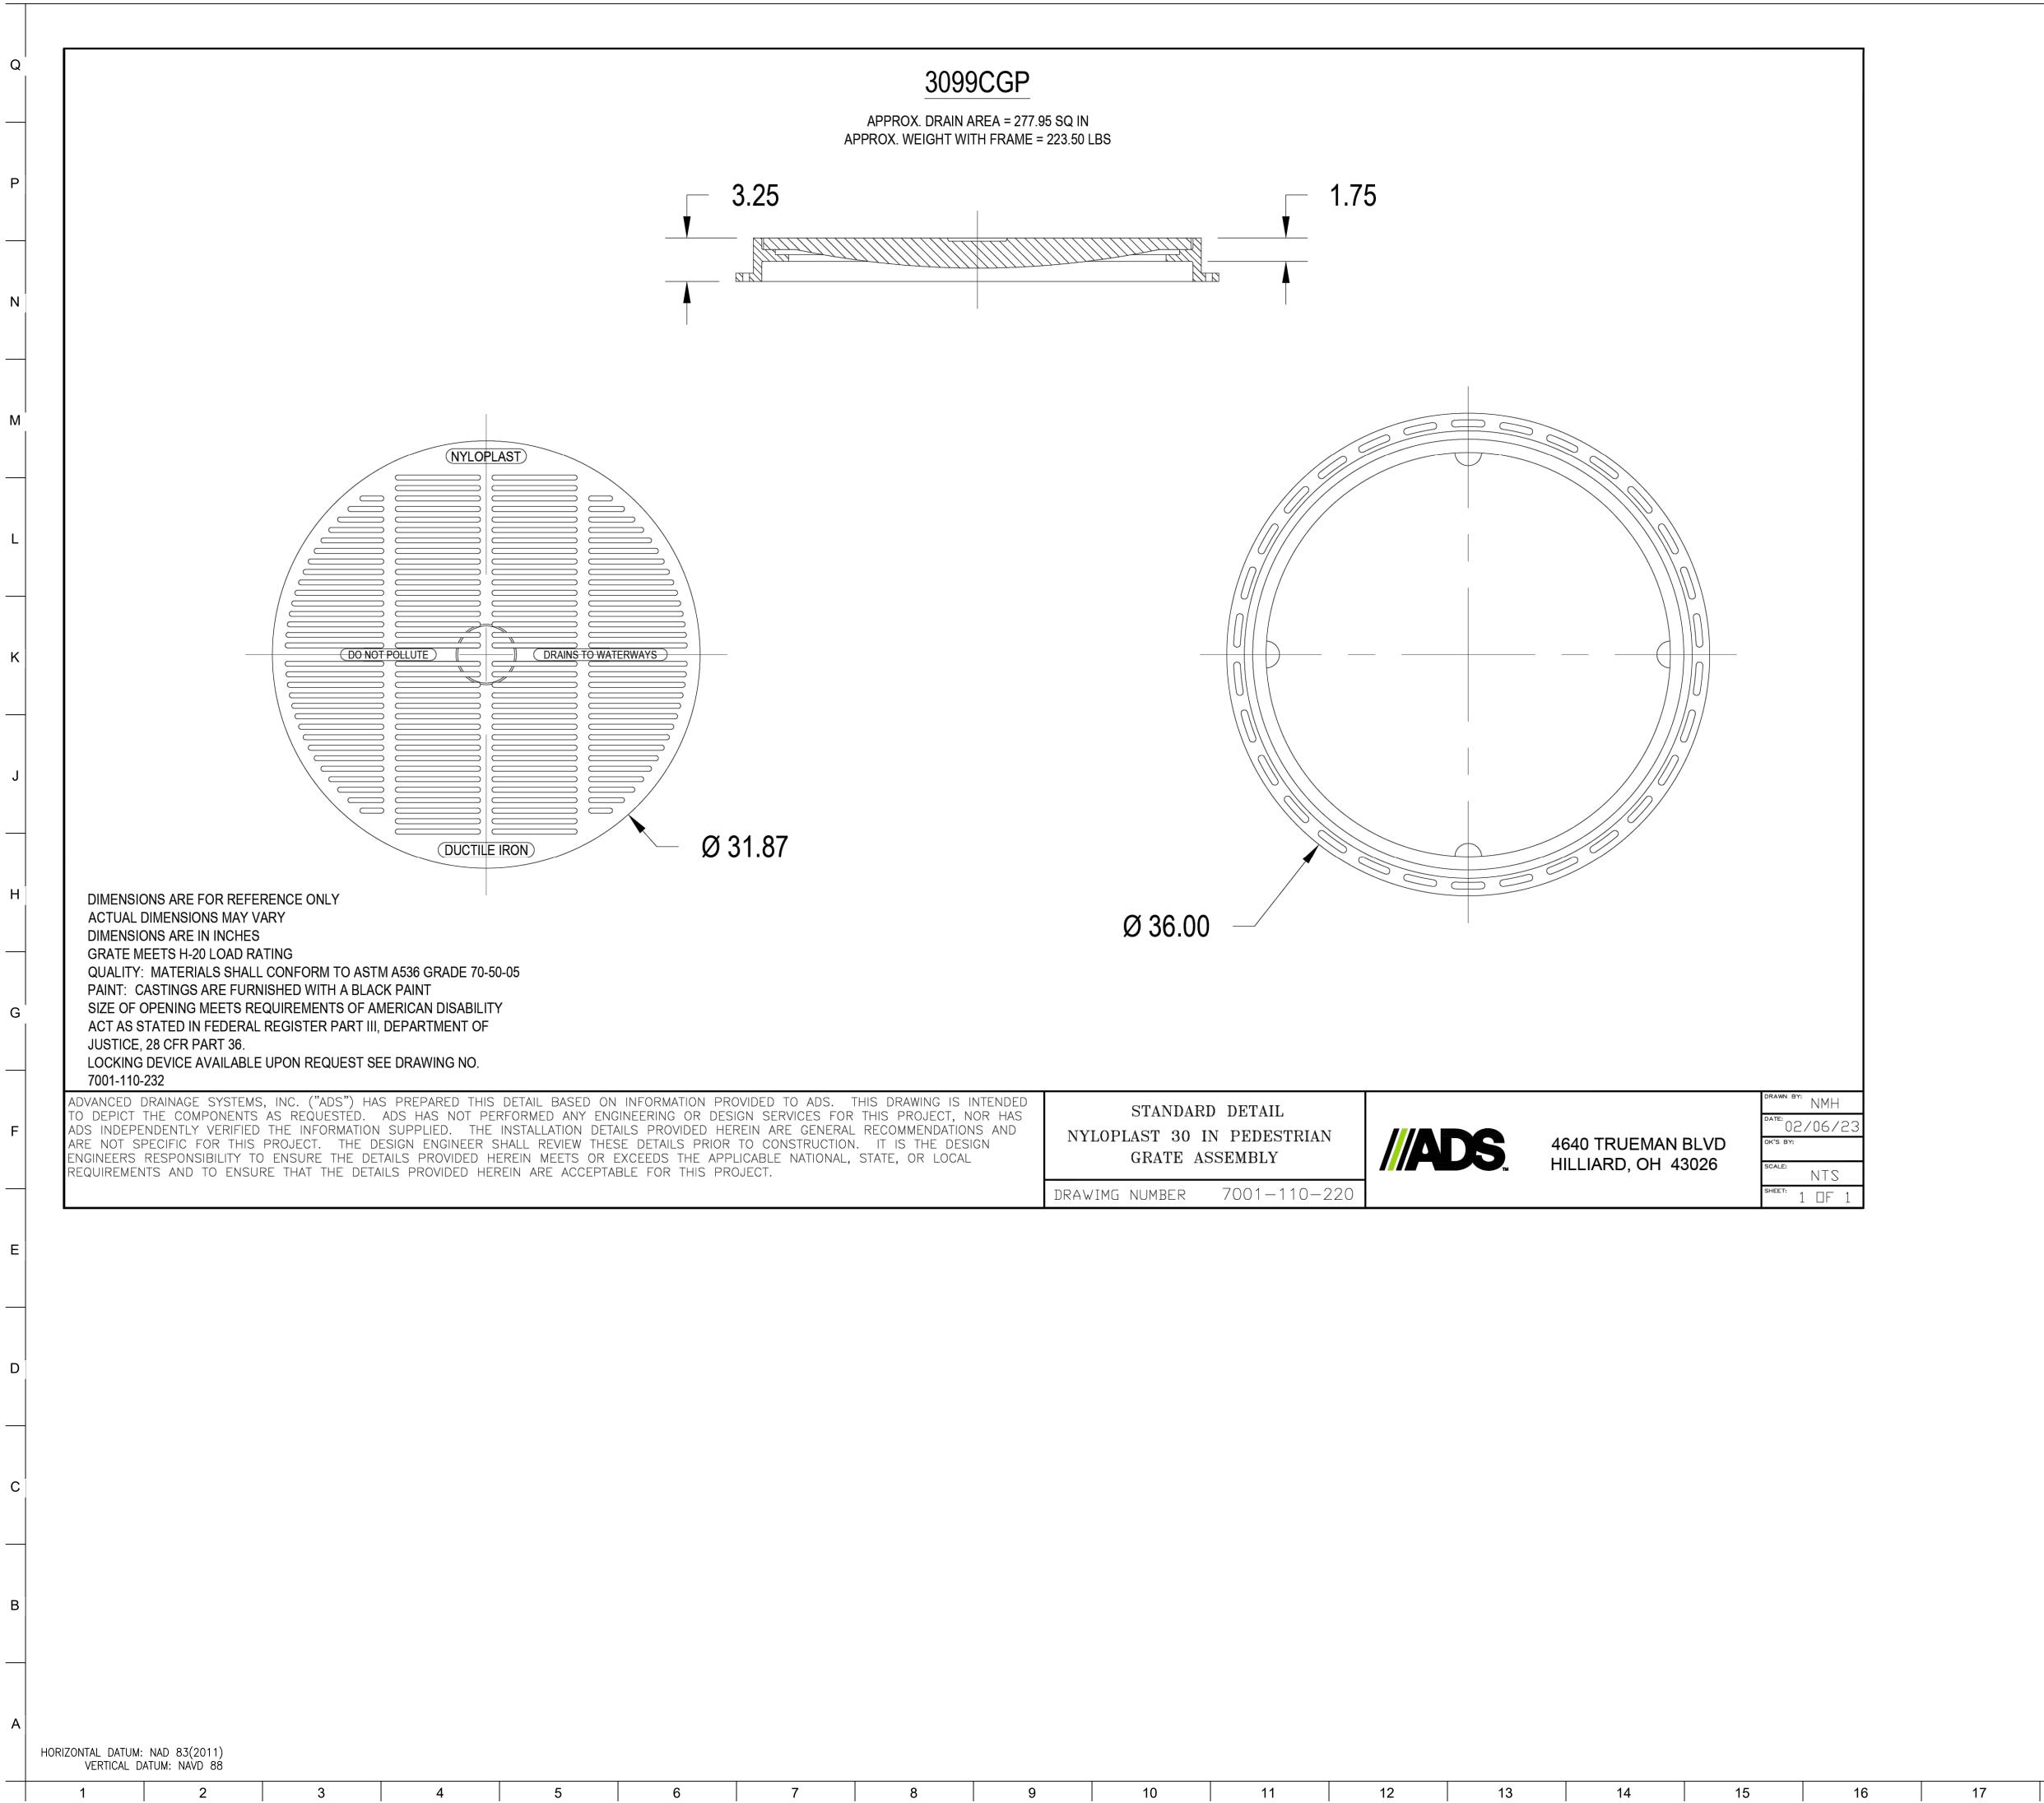


THIS DRAWING IS INTENDED OR THIS PROJECT, NOR HAS AL RECOMMENDATIONS AND ON. IT IS THE DESIGN L, STATE, OR LOCAL	NYLOPLAST 30	D DETAIL IN PEDESTRIAN SSEMBLY	4640 TRUEMAN BLVD HILLIARD, OH 43026	DRAWN BY: NMH DATE: 02/06/23 OK'S BY: SCALE: NTS
	DRAWIMG NUMBER	7001-110-220		SHEET: 1 OF 1

8	9	10	11	12	13	14	15


	BKP	
	PROJECT TEAM: <u>ARCHITECT:</u> BUELL KRATZER POWELL, P.C. 1525 LOCUST STREET PHILADELPHIA, PA 19102 T: 215.557.6509	
OWNER / DEVELOPER/ APPLICANT: MARYLAND ZOO IN BALTIMORE 1876 MANSION HOUSE DRIVE	<u>CIVIL ENGINEER:</u> CARROLL ENGINEERING, INC 215 SCHILLING CIRCLE, STE 102 HUNT VALLEY, MD 21031 T: 410.785.7423	
BALTIMORE MD 21217 CONTACT: MR. KARL KRANZ PHONE: 443–552–3350	LANDSCAPE ARCHITECT: ROBINSON ANDERSON SUMMERS 28 WEST STATE STREET MEDIA, PA 19063 T: 302.888.1544	
	STRUCTURAL ENGINEER: STRUCTURAL DESIGN STUDIO, INC 2225 EAST MURRAY HOLLADAY RE SALT LAKE CITY, UT 84117 T: 801.274.3950	
	MEP ENGINEER: KOVACS, WHITNEY & ASSOCIATES 190 WEST OSTEND ST, STE 300 BALTIMORE, MD 21230 T: 410.244.7191	
	CLIENT: MARYLAND ZOO	
	THE MARYLAND ZOO IN BALTIMORE 1 SAFARI PLACE BALTIMORE, MD 21217	_
	<b>PANDA</b> RYLAND ZOO ALTIMORE ARI PLACE RE, MD 21217	
	RED P THE MARY IN BAL I SAFAF BALTIMORF	
	THIS DRAWING IS TO ILLUSTRATE THE WORK TO BE DONE. THE ARCHITECT IS NOT RESPONSIBLE FOR THE MEANS, METHODS, TECHNIQUES, SEQUENCES, AND PROCEDURES USED TO DO THE WORK OR THE SAFETY ASPECTS OF CONSTRUCTION, AND NOTHING ON THIS DRAWING EXPRESSED OR IMPLIED CHANGES THIS CONDITION. CONTRACTOR SHALL BE RESPONSIBLE FOR KNOWING HOW THEY AFFECT THE WORK. SUBMITTAL OF A BID TO PERFORM THIS WORK IS AN ACKNOWLEDGEMENT OF THESE RESPONSIBILITIES, AND THAT THEY HAVE BEEN FULLY CONSIDERED IN PLANNING OF THE WORK, AND THE BID PRICE. NO CLAIMS FOR EXTRA CHARGES DUE TO THESE CONDITIONS WILL BE FORTHCOMING.	
	SEAL:	
	PROFESSIONAL CERTIFICATION. I HEREBY CERTIFY THAT THESE DOCUMENTS WERE PREPARED OR APPROVED BY ME, AND THAT I AM A DULY LICENSED PROFESSIONAL ENGINEER UNDER THE LAWS OF THE STATE OF MARYLAND, LICENSE NO. 14446, EXPIRATION DATE 5/25/25.	
	DATE: JANUARY 14, 2025 PROJECT NO: 2023-10.04	
	DRAWN BY MJE CHECKED BY CMS	_
	SUBMISSION DATE BID SET 01/14/2025	
	REVISION DATE	-
	DRAWING TITLE: STORM DRAIN DETAILS	
BCNR # 11545	C524	
18 19 20		


5		
F	1	

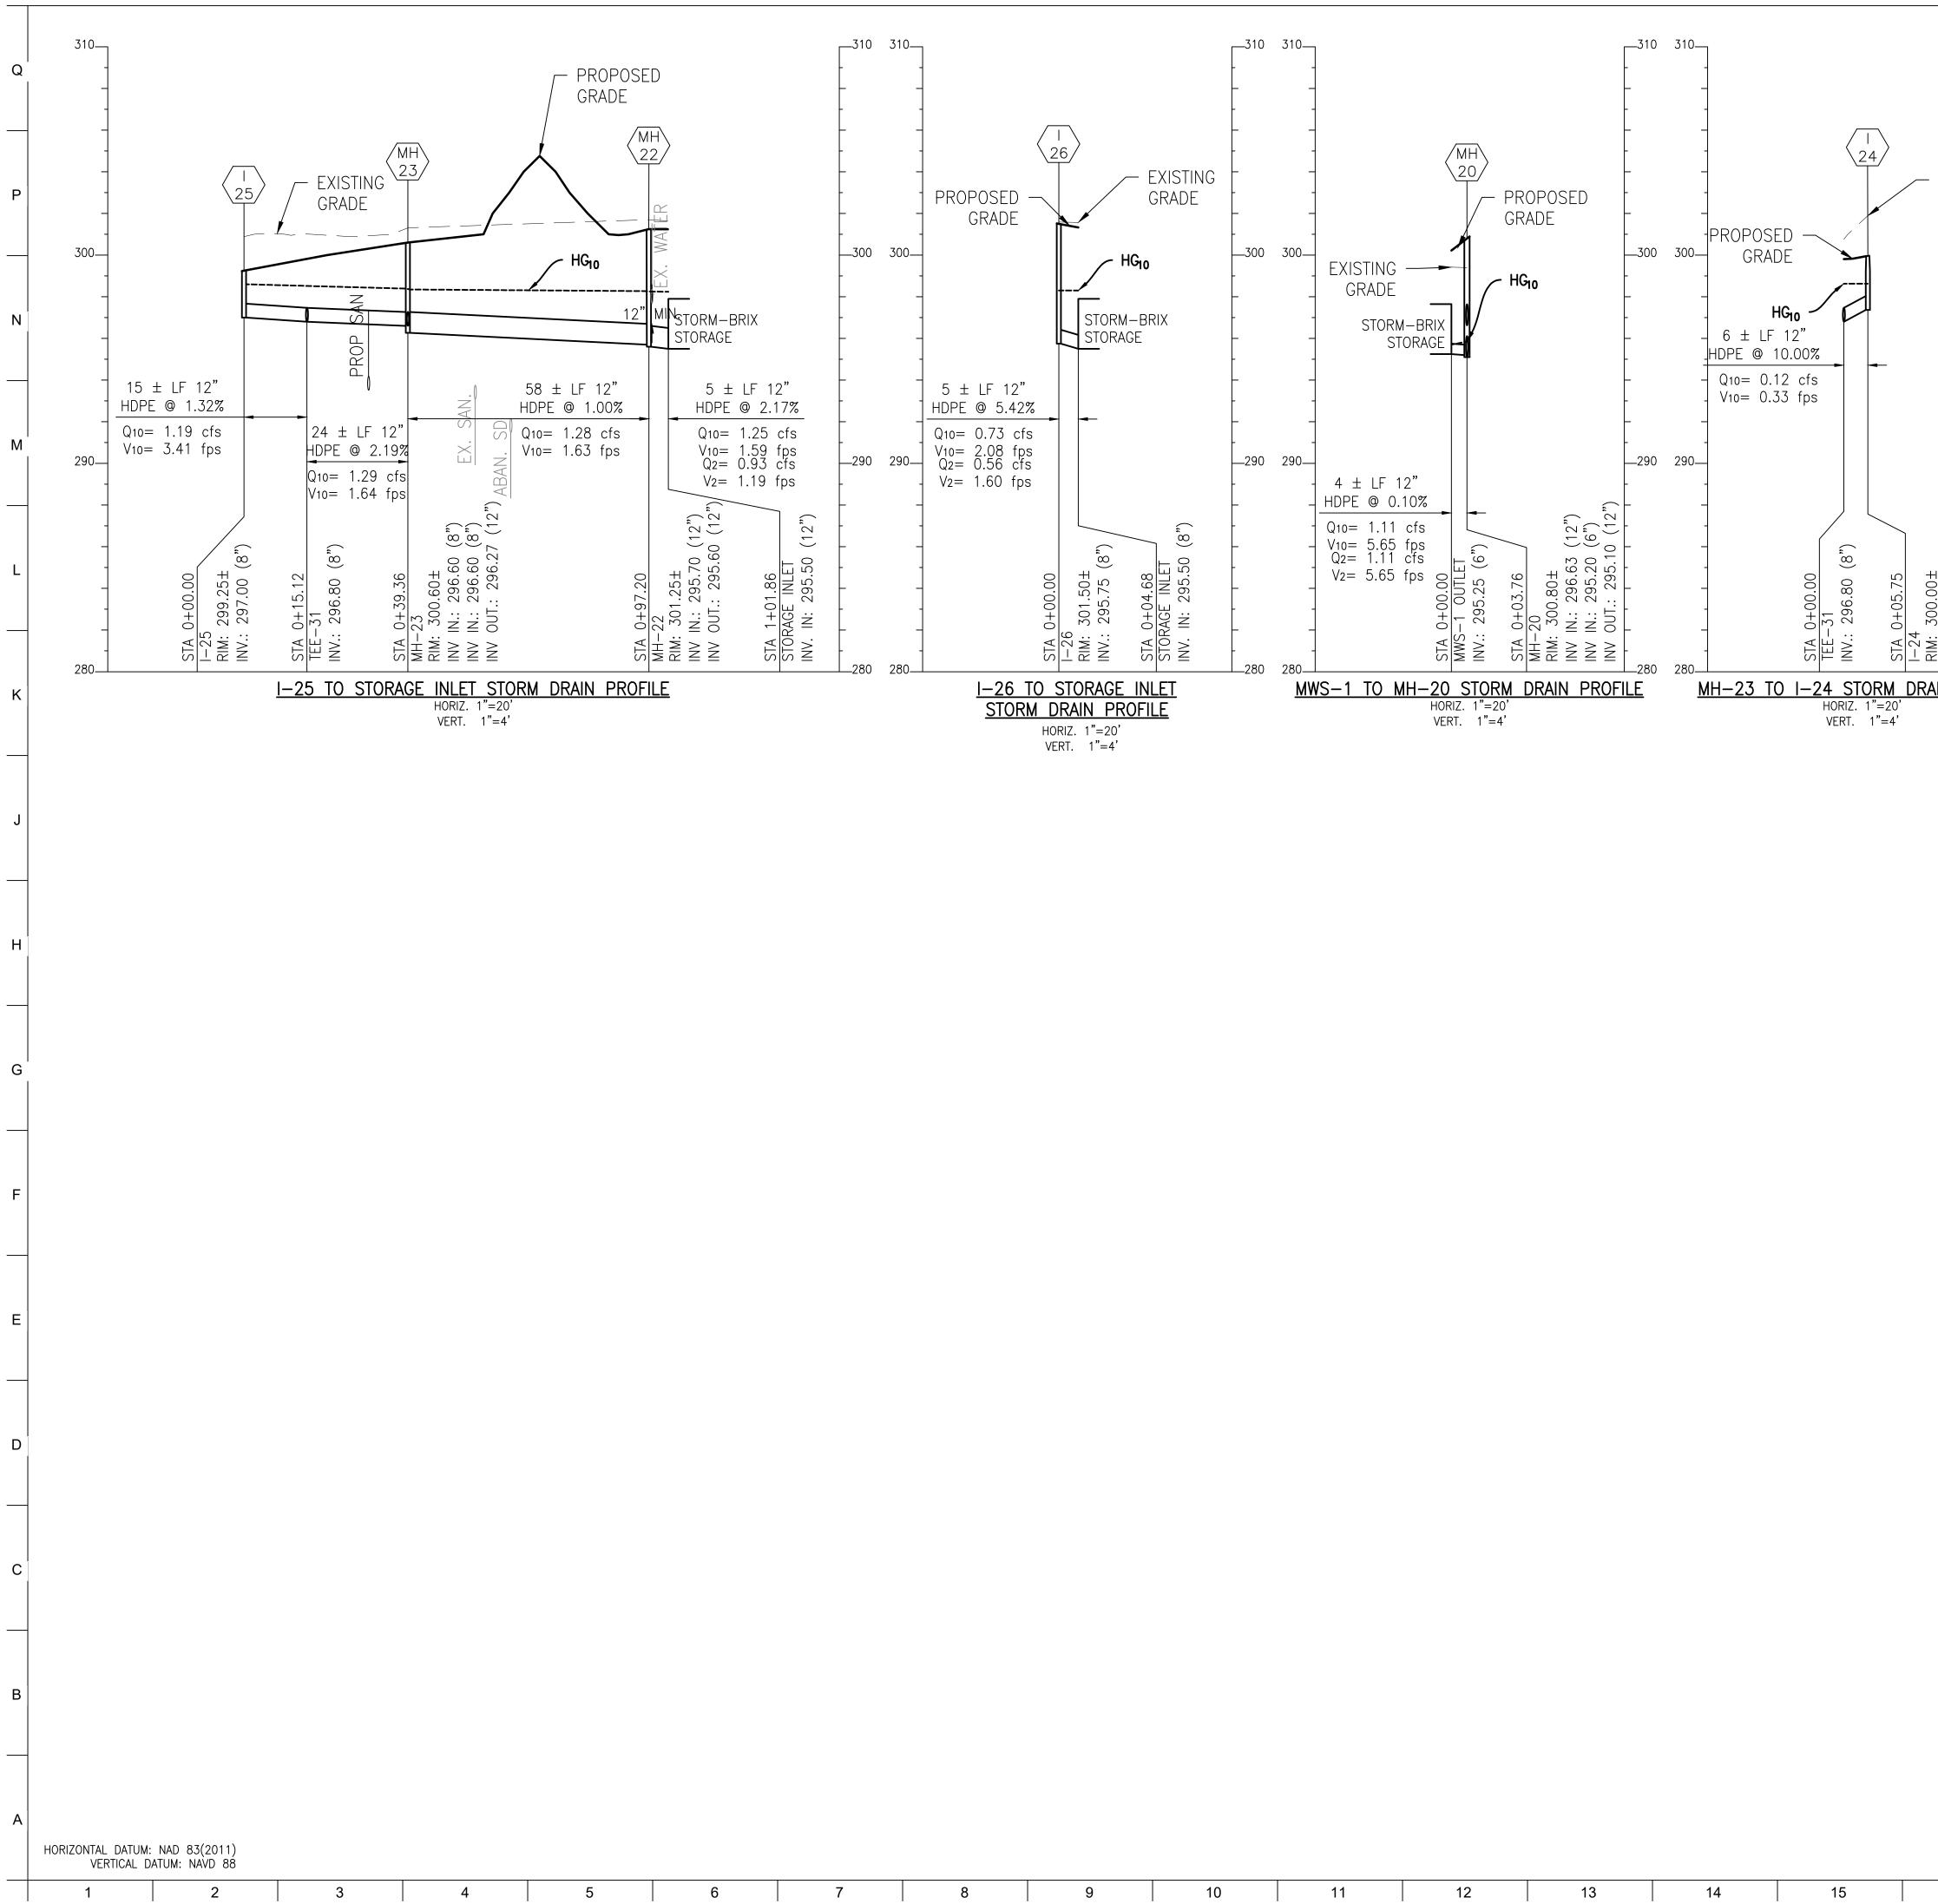

8	9	10	11	12	13	14	15

	310		ВКР
	-		PROJECT TEAM:
EXISTING GRADE	-		<u>ARCHITECT:</u> BUELL KRATZER POWELL, P.C. 1525 LOCUST STREET PHILADELPHIA, PA 19102 T: 215.557.6509
		<u>OWNER / DEVELOPER/ APPLICANT</u> : MARYLAND ZOO IN BALTIMORE	<u>CIVIL ENGINEER:</u> CARROLL ENGINEERING, INC 215 SCHILLING CIRCLE, STE 102 HUNT VALLEY, MD 21031 T: 410.785.7423
-	-	1876 MANSION HOUSE DRIVE BALTIMORE MD 21217 CONTACT: MR. KARL KRANZ PHONE: 443–552–3350	LANDSCAPE ARCHITECT: ROBINSON ANDERSON SUMMERS 28 WEST STATE STREET MEDIA, PA 19063 T: 302.888.1544
	- - 290		<u>STRUCTURAL ENGINEER:</u> STRUCTURAL DESIGN STUDIO, INC 2225 EAST MURRAY HOLLADAY RD SALT LAKE CITY, UT 84117 T: 801.274.3950
.75 00± 297.37 (8")	-		MEP ENGINEER: KOVACS, WHITNEY & ASSOCIATES 190 WEST OSTEND ST, STE 300 BALTIMORE, MD 21230 T: 410.244.7191
STA 0+05 STA 0+05 I - 24 INV. 0UT: INV. 0UT: I - 24 I - 24 I - 24 I - 27 I - 27 I - 20			CLIENT: MARYLAND ZOO THE MARYLAND ZOO IN BALTIMORE 1 SAFARI PLACE
1"=4'			
			RED PAND. E Maryland IN Baltimor I Safari Plao Timore, MD 2
			THIS DRAWING IS TO ILLUSTRATE THE WORK TO BE DONE. THE
			ARCHITECT IS NOT RESPONSIBLE FOR THE MEANS, METHODS, TECHNIQUES, SEQUENCES, AND PROCEDURES USED TO DO THE WORK OR THE SAFETY ASPECTS OF CONSTRUCTION, AND NOTHING ON THIS DRAWING EXPRESSED OR IMPLIED CHANGES THIS CONDITION. CONTRACTOR SHALL BE RESPONSIBLE FOR KNOWING HOW THEY AFFECT THE WORK. SUBMITTAL OF A BID TO PERFORM THIS WORK IS AN ACKNOWLEDGEMENT OF THESE RESPONSIBILITIES, AND THAT THEY HAVE BEEN FULLY CONSIDERED IN PLANNING OF THE WORK, AND THE BID PRICE. NO CLAIMS FOR EXTRA CHARGES DUE TO THESE CONDITIONS WILL BE FORTHCOMING. SEAL:
			P Rote S S O N A L ENGLINE
			PROFESSIONAL CERTIFICATION. I HEREBY CERTIFY THAT THESE DOCUMENTS WERE PREPARED OR APPROVED BY ME, AND THAT I AM A DULY LICENSED PROFESSIONAL ENGINEER UNDER THE LAWS OF THE STATE OF MARYLAND, LICENSE NO. 14446, EXPIRATION DATE 5/25/25.
			DATE: JANUARY 14, 2025 PROJECT NO: 2023-10.04 DRAWN BY MJE CHECKED BY CMS SUBMISSION DATE BID SET 01/14/2025
			REVISION DATE
		4 2 0 4 8	DRAWING TITLE: STORM DRAIN PROFILES
		SCALE: 1"=4'	
		20 10 0 20 40 SCALE: 1"=20' BCNR # 11545	drawing no: C530
16	17	18 19 20	

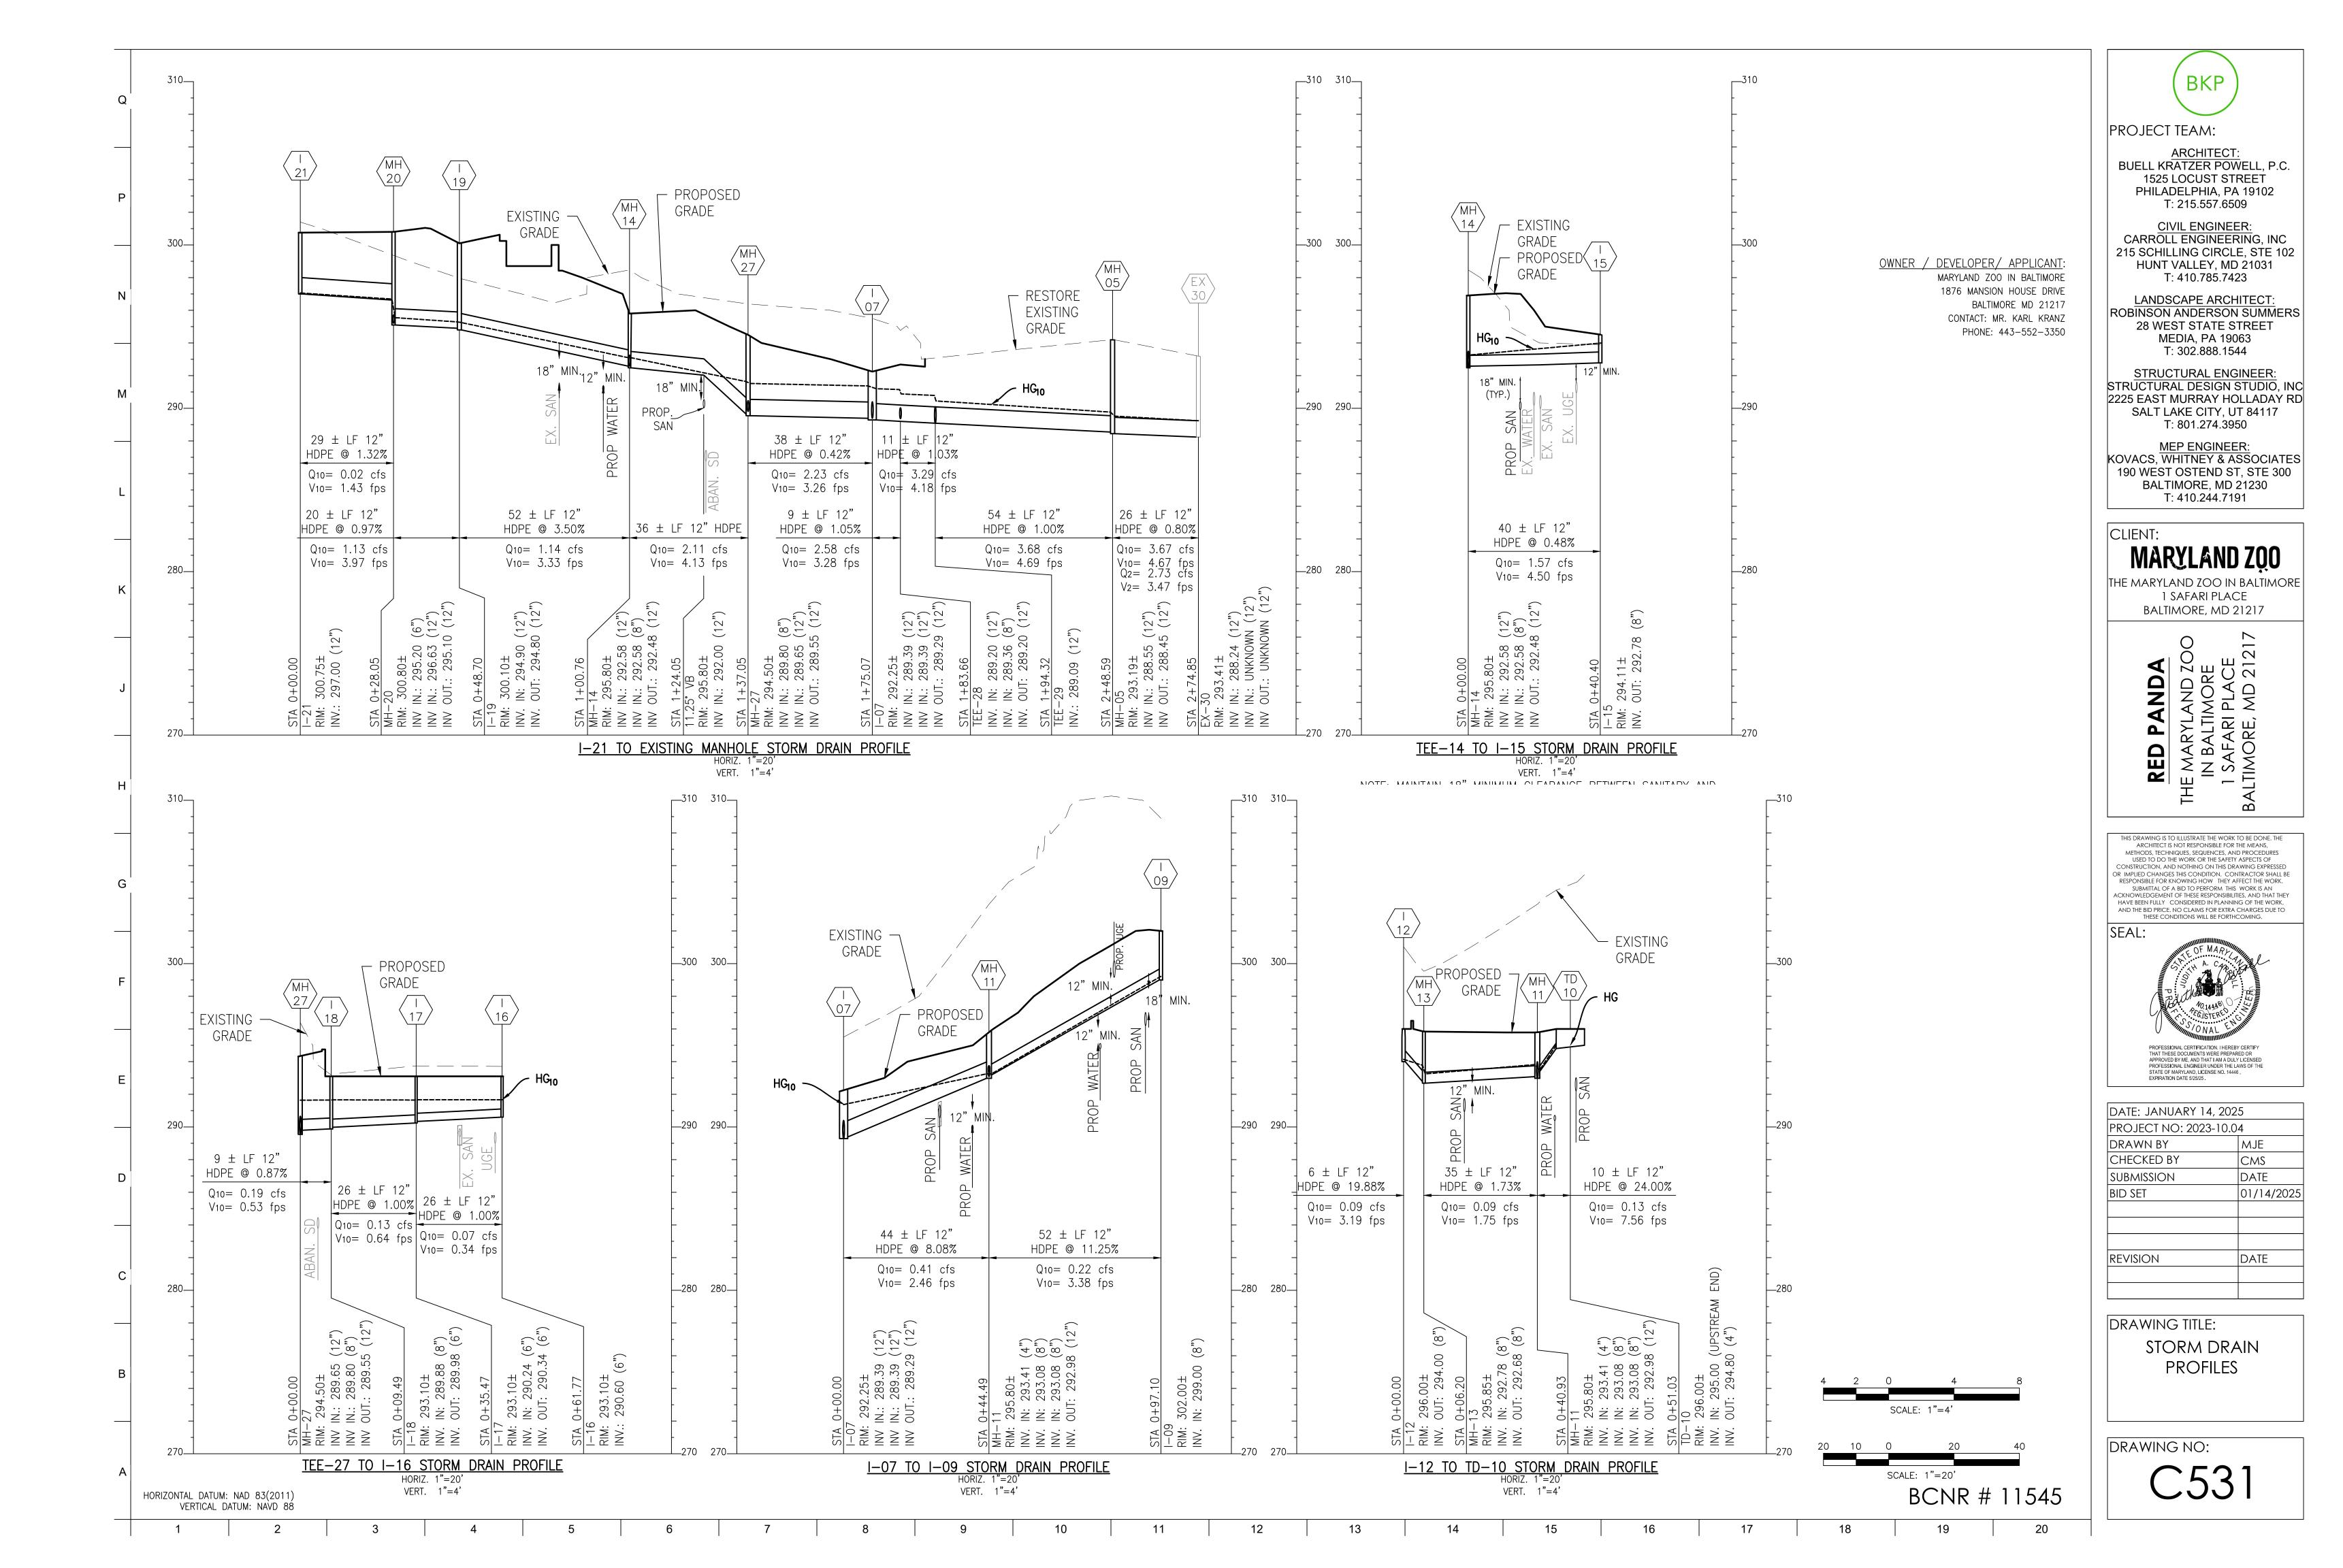


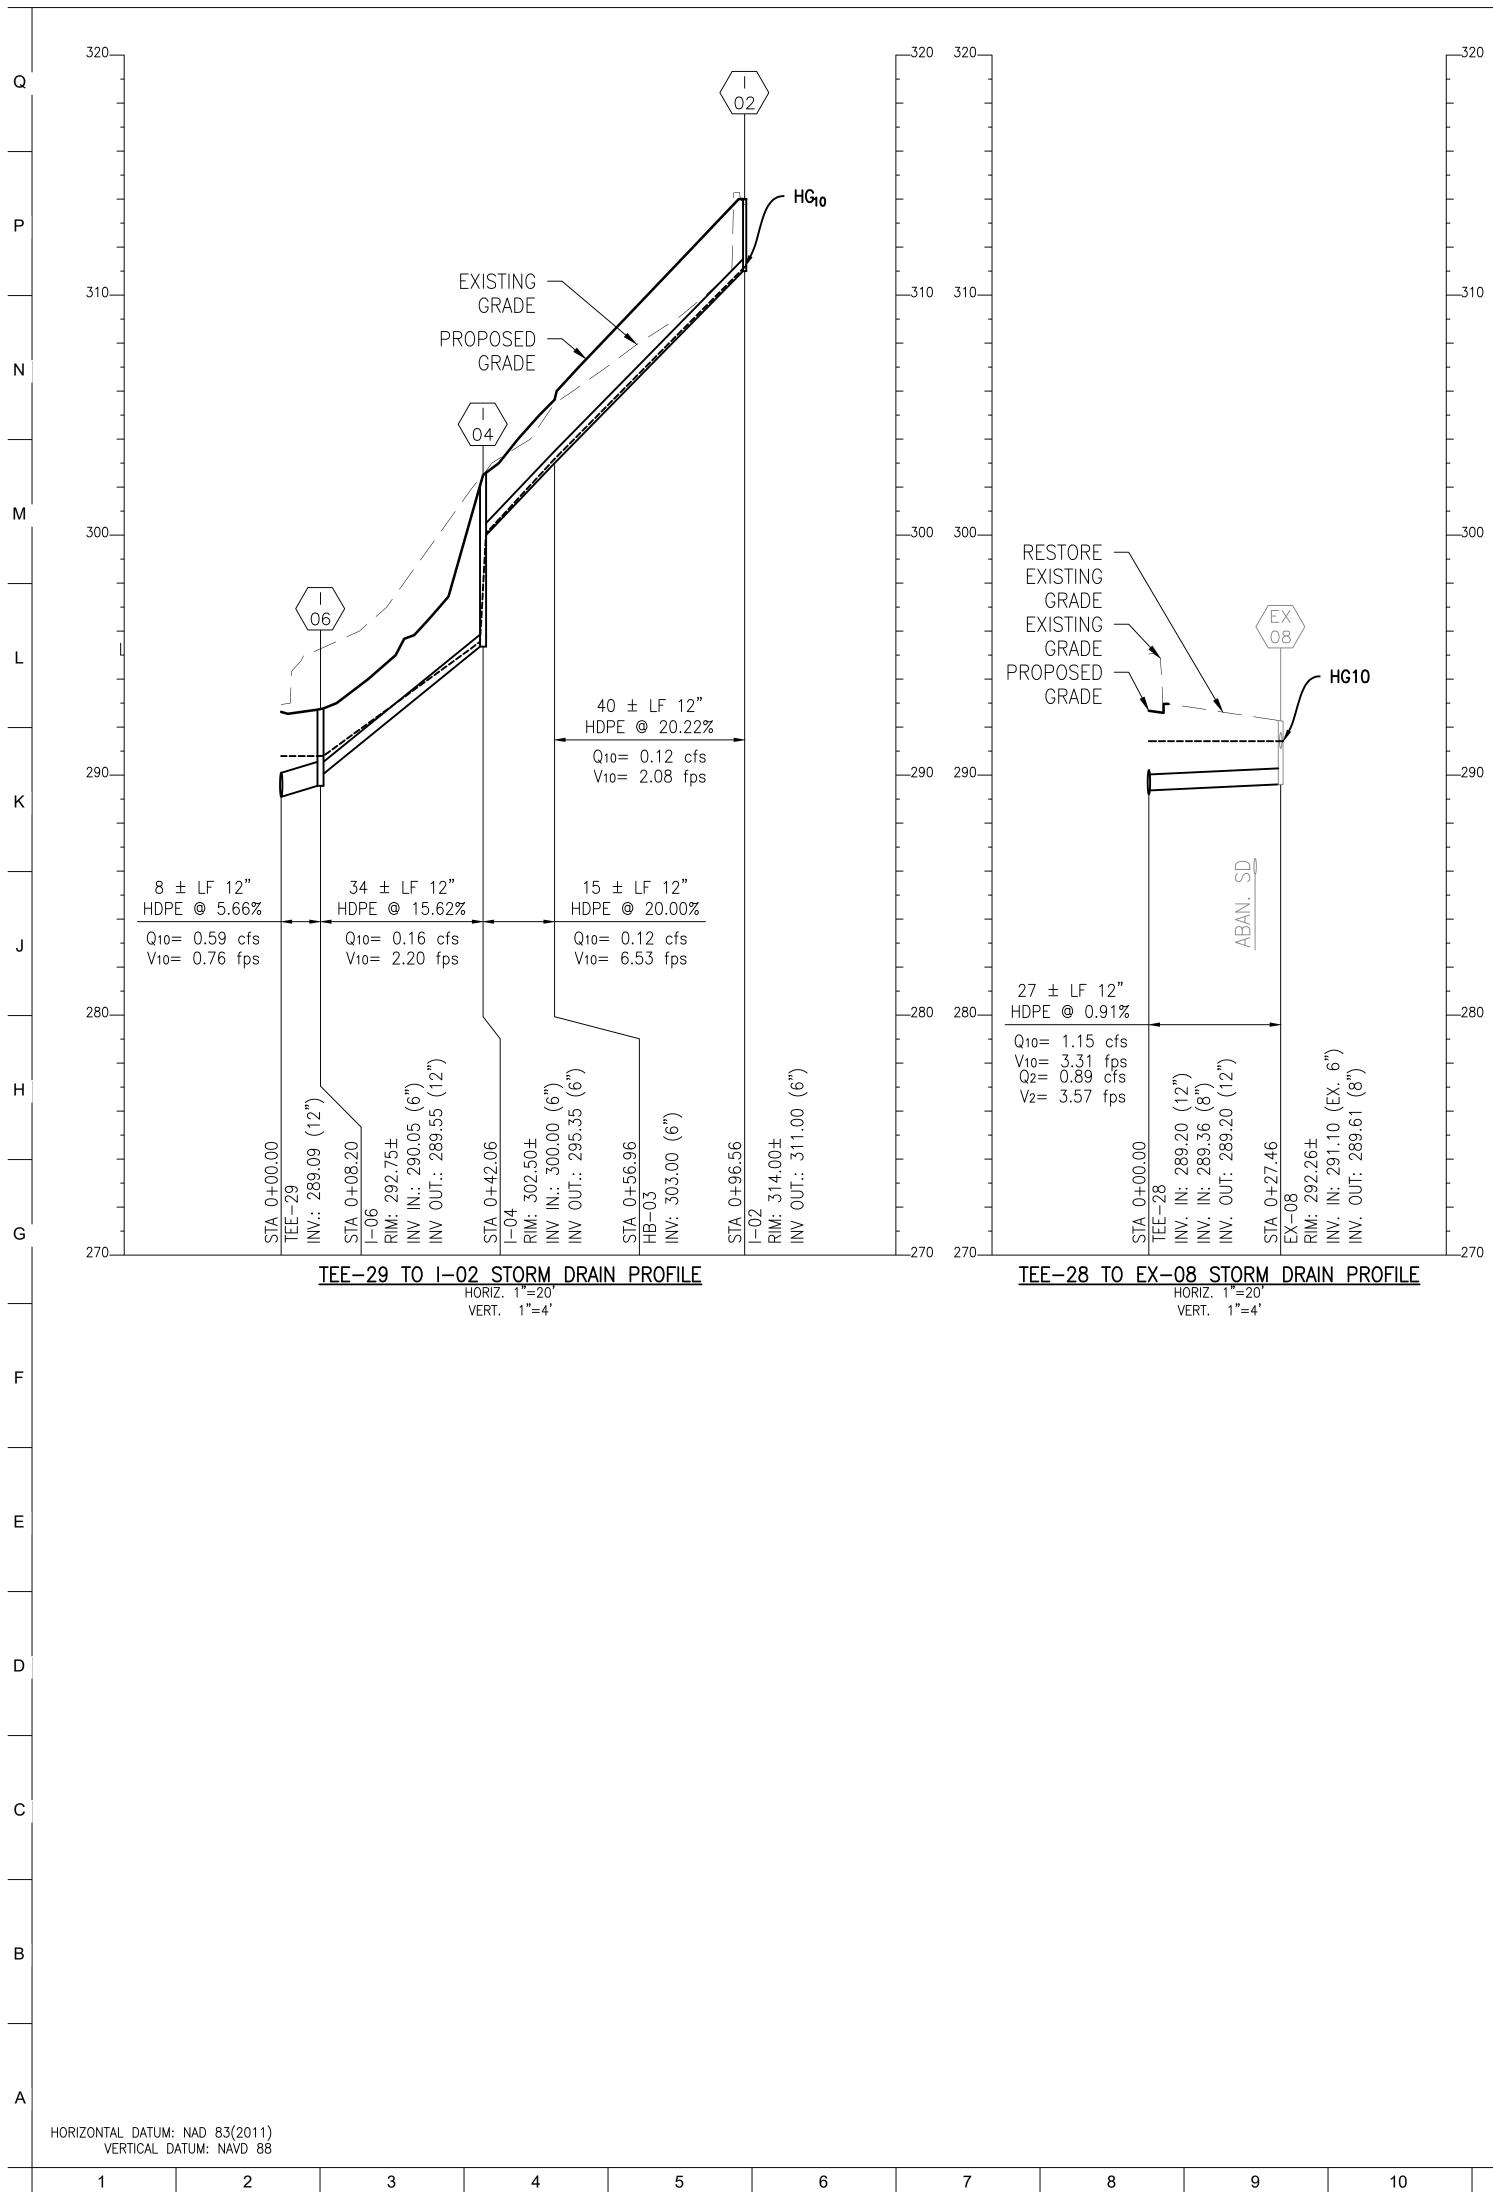

8	9	10	11	12	13	14	15

	ВКР
	PROJECT TEAM:
	ARCHITECT:
	BUELL KRATZER POWELL, P.C. 1525 LOCUST STREET
	PHILADELPHIA, PA 19102 T: 215.557.6509
	<u>CIVIL ENGINEER:</u> CARROLL ENGINEERING, INC
OWNER / DEVELOPER/ APPLICANT:	215 SCHILLING CIRCLE, STE 102 HUNT VALLEY, MD 21031
MARYLAND ZOO IN BALTIMORE 1876 MANSION HOUSE DRIVE	T: 410.785.7423
BALTIMORE MD 21217 CONTACT: MR. KARL KRANZ	LANDSCAPE ARCHITECT: ROBINSON ANDERSON SUMMERS
PHONE: 443-552-3350	28 WEST STATE STREET MEDIA, PA 19063
	T: 302.888.1544 STRUCTURAL ENGINEER:
	STRUCTURAL DESIGN STUDIO, INC 2225 EAST MURRAY HOLLADAY RD
	SALT LAKE CITY, UT 84117 T: 801.274.3950
	MEP ENGINEER:
	KOVACS, WHITNEY & ASSOCIATES 190 WEST OSTEND ST, STE 300
	BALTIMORE, MD 21230 T: 410.244.7191
	CLIENT:
	MARYLAND ZOO
	THE MARYLAND ZOO IN BALTIMORE
	1 SAFARI PLACE BALTIMORE, MD 21217
	RED PANDA E Maryland Z In Baltimore I Safari Place Timore, MD 21
	BAL THE
	THIS DRAWING IS TO ILLUSTRATE THE WORK TO BE DONE. THE ARCHITECT IS NOT RESPONSIBLE FOR THE MEANS, METHODS, TECHNIQUES, SEQUENCES, AND PROCEDURES USED TO DO THE WORK OR THE SAFETY ASPECTS OF CONSTRUCTION, AND NOTHING ON THIS DRAWING EXPRESSED OR IMPLIED CHANGES THIS CONDITION. CONTRACTOR SHALL BE RESPONSIBLE FOR KNOWING HOW THEY AFFECT THE WORK. SUBMITTAL OF A BID TO PERFORM THIS WORK IS AN ACKNOWLEDGEMENT OF THESE RESPONSIBILITIES, AND THAT THEY HAVE BEEN FULLY CONSIDERED IN PLANNING OF THE WORK, AND THE BID PRICE. NO CLAIMS FOR EXTRA CHARGES DUE TO THESE CONDITIONS WILL BE FORTHCOMING.
	SEAL:
	A C TANK
	PR
	PEOSTERE () HILLSSONAL EMILIA
	PROFESSIONAL CERTIFICATION. I HEREBY CERTIFY THAT THESE DOCUMENTS WERE PREPARED OR APPROVED BY ME, AND THAT I AM A DULY LICENSED
	PROFESSIONAL ENGINEER UNDER THE LAWS OF THE STATE OF MARYLAND, LICENSE NO. 14446 , EXPIRATION DATE 5/25/25 .
	DATE: JANUARY 14, 2025
	PROJECT NO: 2023-10.04 DRAWN BY MJE
	CHECKED BY CMS
	SUBMISSIONDATEBID SET01/14/2025
	REVISION DATE
	DRAWING TITLE:
	STORM DRAIN PROFILES
0 4 8	
SCALE: 1"=4'	
0 20 40	DRAWING NO:
SCALE: 1"=20'	C532
BCNR # 11545	
19 20	

10 0

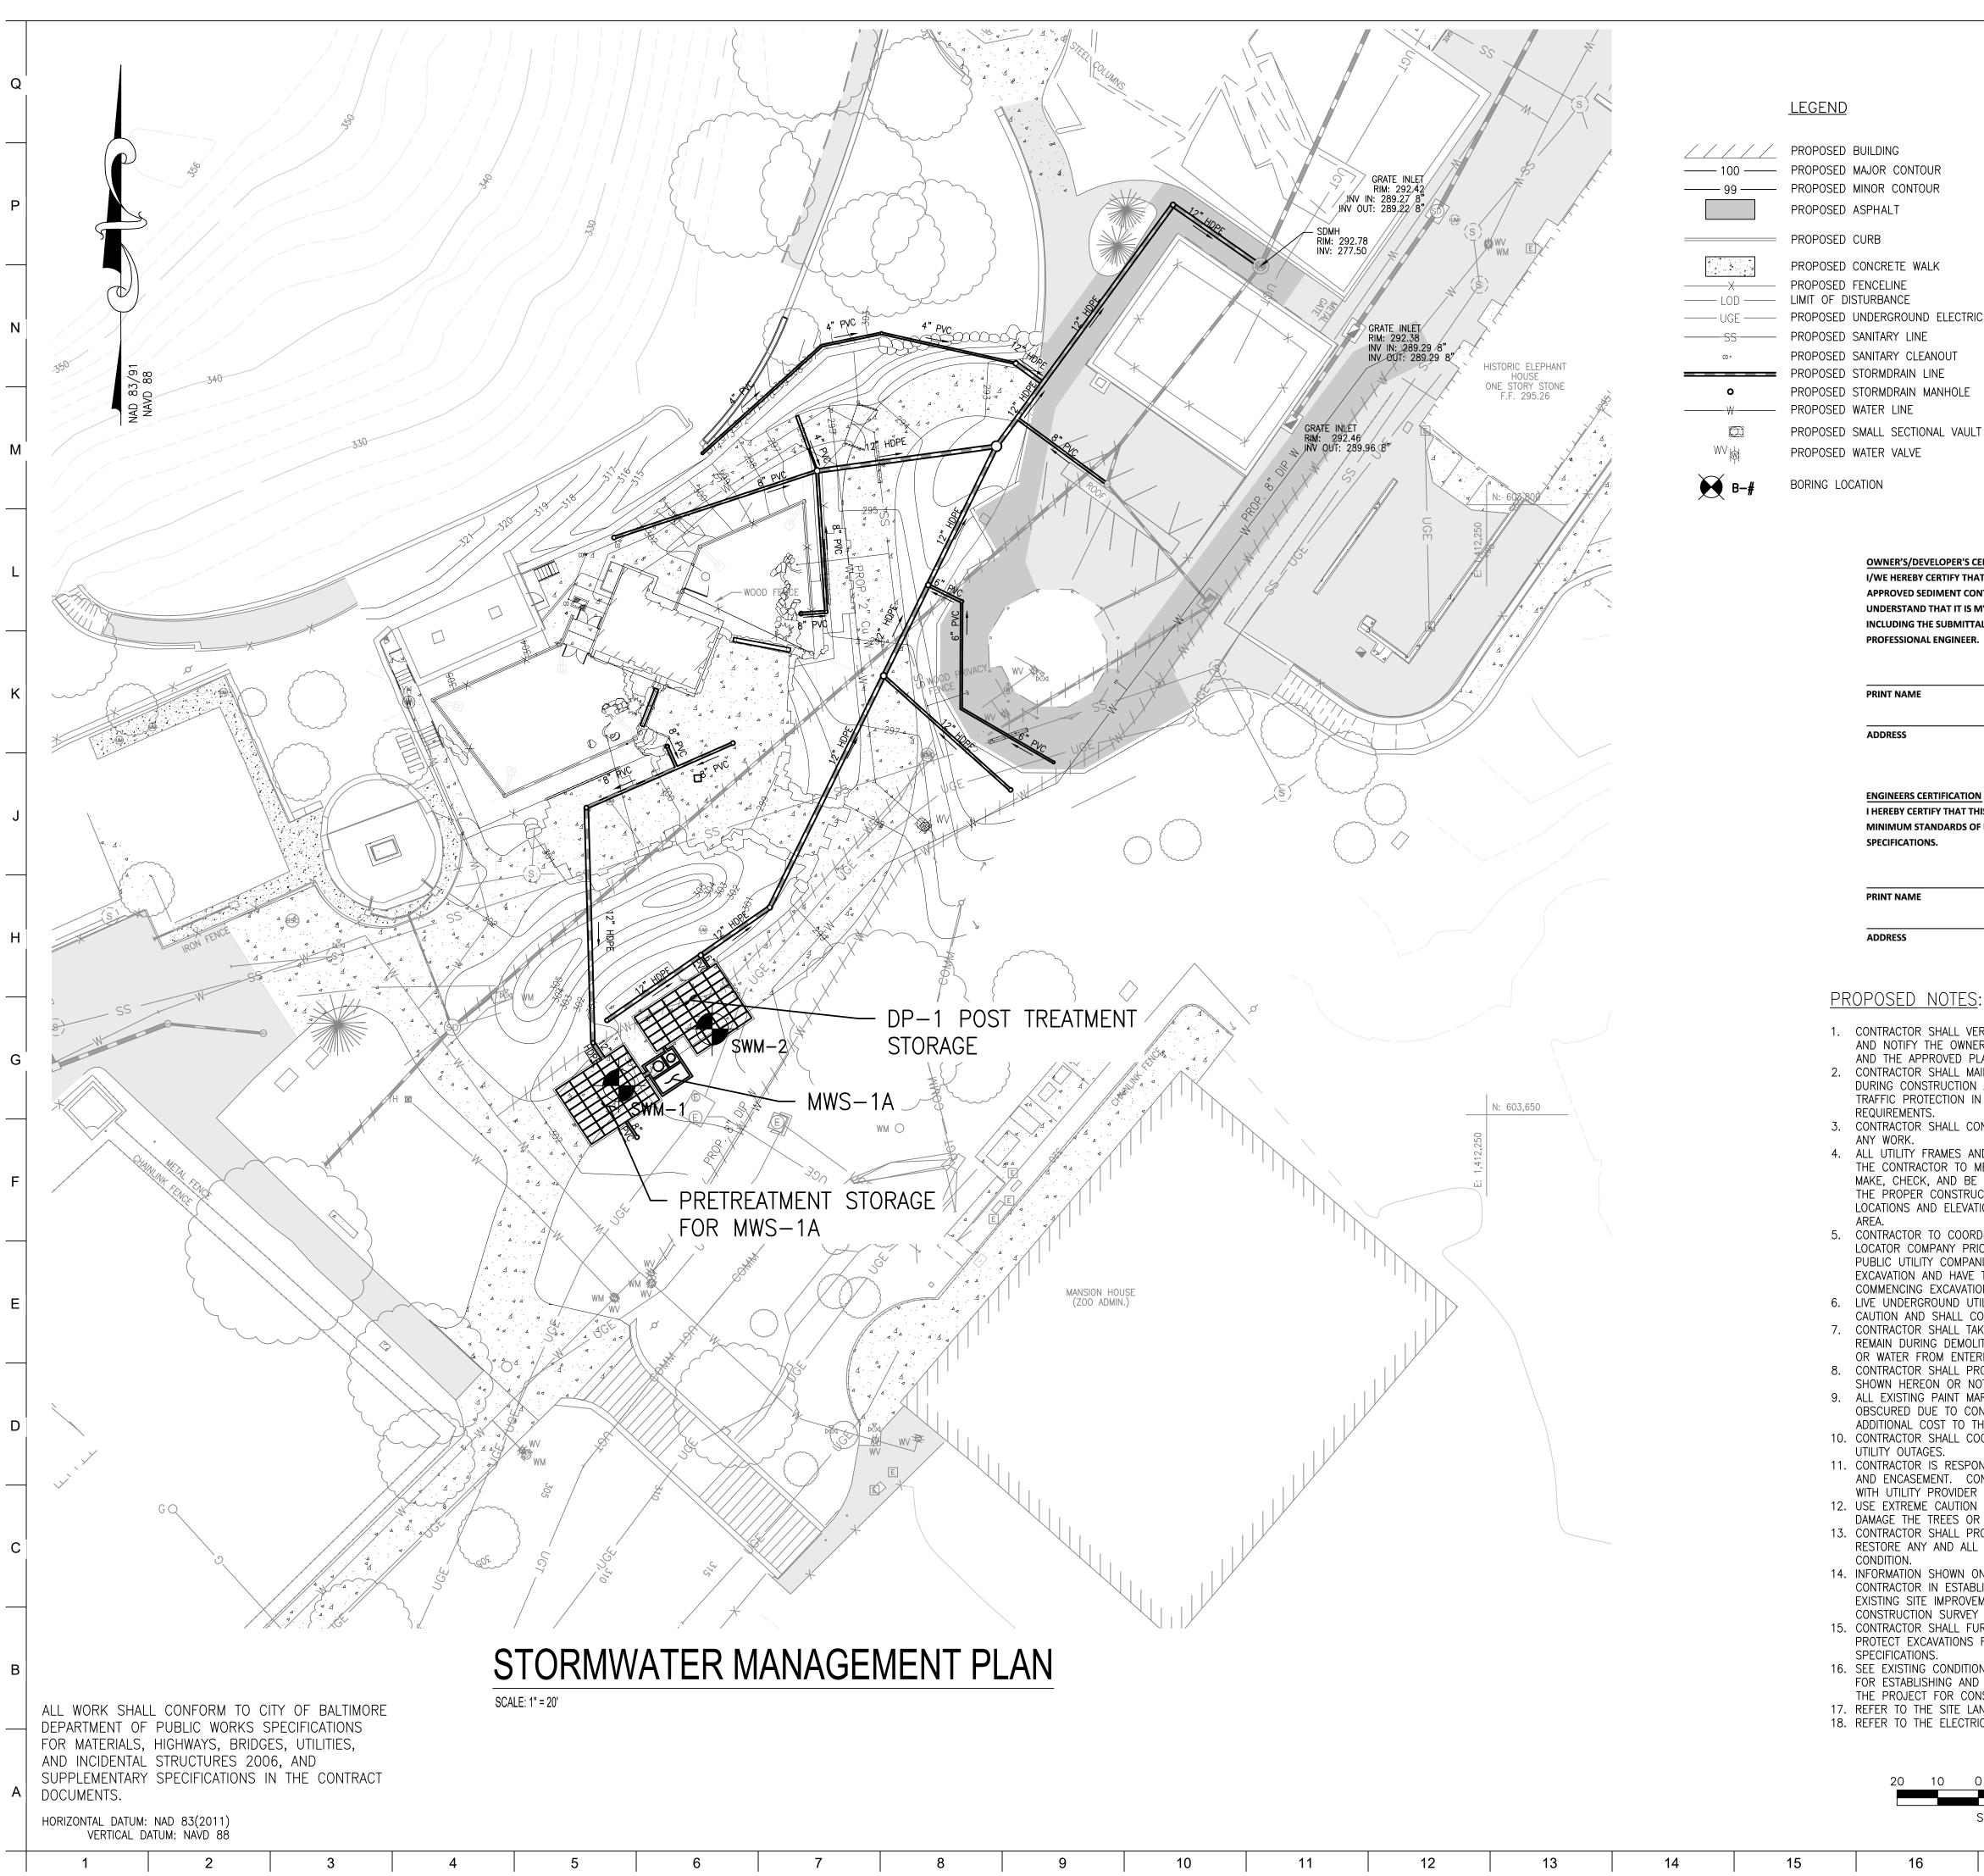

8	9	10	11	12	13	14	

N	G
	CONTOUR
	CONTOUR
١L	T

PROPOSED STORMDRAIN MANHOLE PROPOSED SMALL SECTIONAL VAULT

#### SWM CERTIFICATIONS SHEET REVISION DATE: May 18, 2022

OWNER'S/DEVELOPER'S CERTIFICATION

I/WE HEREBY CERTIFY THAT ALL PROPOSED WORK SHOWN IN THESE CONSTRUCTION DRAWING(S) AND APPROVED SEDIMENT CONTROL DRAWING(S) WILL BE ACCOMPLISHED PURSUANT TO THESE PLANS. I/WE ALSO UNDERSTAND THAT IT IS MY/OUR RESPONSIBILITY TO HAVE THE CONSTRUCTION SUPERVISED AND CERTIFIED INCLUDING THE SUBMITTAL OF "AS-BUILT" PLANS WITHIN THIRTY (30) DAYS OF COMPLETION, BY A REGISTERED **PROFESSIONAL ENGINEER** 

BLABAT		
NAME		

SIGNATURE

ADDRESS

TELEPHONE NUMBER

ENGINEERS CERTIFICATION

I HEREBY CERTIFY THAT THIS PLAN HAS BEEN PREPARED BY ME OR UNDER MY SUPERVISION AND MEETS THE MINIMUM STANDARDS OF BALTIMORE CITY DEPARTMENT OF PUBLIC WORKS REQUIREMENTS AND SPECIFICATIONS.

PRINT NAME

**TELEPHONE NUMBER** 

DATE

BCNR # 11545

20

19

# PROPOSED NOTES:

1. CONTRACTOR SHALL VERIFY FIELD CONDITIONS PRIOR TO AND DURING CONSTRUCTION/DEMOLITION AND NOTIFY THE OWNER IMMEDIATELY OF ANY DISCREPANCIES BETWEEN ACTUAL FIELD CONDITIONS AND THE APPROVED PLANS.

SIGNATURE

2. CONTRACTOR SHALL MAINTAIN PEDESTRIAN & VEHICULAR ACCESS TO AND AROUND OVERALL SITE DURING CONSTRUCTION ACTIVITIES. CONTRACTOR SHALL FURNISH VEHICULAR AND PEDESTRIAN TRAFFIC PROTECTION IN ACCORDANCE WITH MUTCD LATEST VERSION AND THE CITY OF BALTIMORE REQUIREMENTS.

3. CONTRACTOR SHALL CONTACT THE OWNER AND DEVELOPER 72 HOURS PRIOR TO COMMENCING ANY WORK. 4. ALL UTILITY FRAMES AND COVERS TO REMAIN WITHIN THE PROJECT AREA SHALL BE ADJUSTED BY

THE CONTRACTOR TO MEET NEW PAVEMENT OR GROUND ELEVATION. THE CONTRACTOR SHALL MAKE, CHECK, AND BE RESPONSIBLE FOR ALL MEASUREMENTS AND DIMENSIONS NECESSARY FOR THE PROPER CONSTRUCTION OF AND THE PREVENTION OF MISFITTINGS IN THE WORK. VERIFY LOCATIONS AND ELEVATIONS OF EXISTING UTILITIES BEFORE STARTING CONSTRUCTION IN EACH

5. CONTRACTOR TO COORDINATE WITH MISS UTILITY, THE CITY OF BALTIMORE, AND A PRIVATE UTILITY LOCATOR COMPANY PRIOR TO COMMENCING ANY WORK. THE CONTRACTOR MUST NOTIFY ALL PUBLIC UTILITY COMPANIES WITH UNDERGROUND FACILITIES IN THE AREA OF PROPOSED EXCAVATION AND HAVE THOSE FACILITIES LOCATED BY THE UTILITY COMPANIES PRIOR TO COMMENCING EXCAVATION.

6. LIVE UNDERGROUND UTILITIES EXIST WITHIN THE WORK AREA. CONTRACTOR SHALL USE EXTREME CAUTION AND SHALL COMPLY WITH APPLICABLE FEDERAL, STATE AND LOCAL REGULATIONS. CONTRACTOR SHALL TAKE NECESSARY PRECAUTIONS TO PROTECT EXISTING UTILITY STRUCTURES TO REMAIN DURING DEMOLITION AND CONSTRUCTION ACTIVITIES AND TO PREVENT DEBRIS, SEDIMENT, OR WATER FROM ENTERING THE STRUCTURES. 8. CONTRACTOR SHALL PROTECT ALL FACILITIES AND UTILITIES TO REMAIN FROM DAMAGE WHETHER

SHOWN HEREON OR NOT. 9. ALL EXISTING PAINT MARKINGS ADJACENT TO THE PROJECT AREA WHICH BECOME FADED OR

OBSCURED DUE TO CONSTRUCTION ACTIVITY SHALL BE REPAINTED OR RESTORED AT NO ADDITIONAL COST TO THE OWNER. 10. CONTRACTOR SHALL COORDINATE WITH OWNER AND UTILITY PROVIDER TO MINIMIZE DURATION OF

UTILITY OUTAGES. 11. CONTRACTOR IS RESPONSIBLE FOR THE COORDINATION AND PLACEMENT OF ALL UTILITY CONDUITS AND ENCASEMENT. CONTRACTOR SHALL PROVIDE CONDUITS AND PULL STRINGS IN ACCORDANCE

WITH UTILITY PROVIDER REQUIREMENTS FOR THEIR RESPECTIVE CONDUITS. 12. USE EXTREME CAUTION WHEN WORKING AROUND EXISTING TREES TO REMAIN SO AS NOT TO DAMAGE THE TREES OR ROOT SYSTEMS.

13. CONTRACTOR SHALL PROTECT ALL AREAS BEYOND THE LIMITS OF DISTURBANCE AND SHALL RESTORE ANY AND ALL AREAS DISTURBED DURING CONSTRUCTION TO THEIR ORIGINAL OR BETTER CONDITION.

14. INFORMATION SHOWN ON THIS DRAWING HAS BEEN PROVIDED AS A GUIDE TO ASSIST THE CONTRACTOR IN ESTABLISHING THE LOCATIONS OF PROPOSED CONSTRUCTION WITH RESPECT TO EXISTING SITE IMPROVEMENTS. IT IS THE RESPONSIBILITY OF THE CONTRACTOR TO PROVIDE ALL CONSTRUCTION SURVEY STAKEOUT REQUIRED AND TO CONFIRM ALL INFORMATION SHOWN HEREON. 15. CONTRACTOR SHALL FURNISH SHORING, SHEATHING, OR OTHERWISE SUPPORT EXCAVATIONS TO PROTECT EXCAVATIONS FROM CAVE-INS UNTIL BACKFILL PLACEMENT IS COMPLETE PER SPECIFICATIONS.

16. SEE EXISTING CONDITIONS PLAN FOR SITE BENCHMARKS. CONTRACTOR SHALL BE RESPONSIBLE FOR ESTABLISHING AND MAINTAINING TEMPORARY BENCHMARKS THROUGHOUT THE DURATION OF THE PROJECT FOR CONSTRUCTION LAYOUT PURPOSES. 17. REFER TO THE SITE LANDSCAPING PLANS FOR ADDITIONAL INFORMATION AND DETAILS.

18

18. REFER TO THE ELECTRICAL PLANS FOR ADDITIONAL ELECTRICAL UTILITY INFORMATION.

20	10	0	20	40
		SCALE	E: 1"=20'	

17

16

OWNER / DEVELOPER / APPLICANT: MARYLAND ZOO IN BALTIMORE 1876 MANSION HOUSE DRIVE BALTIMORE MD 21217 CONTACT: MR. KARL KRANZ PHONE: 443-552-3350

PROJECT TEAM: ARCHITECT: BUELL KRATZER POWELL, P.C. 1525 LOCUST STREET PHILADELPHIA, PA 19102 T: 215.557.6509 CIVIL ENGINEER: CARROLL ENGINEERING, INC 215 SCHILLING CIRCLE, STE 102 HUNT VALLEY, MD 21031 T: 410.785.7423 LANDSCAPE ARCHITECT:

**ROBINSON ANDERSON SUMMERS** 28 WEST STATE STREET MEDIA, PA 19063 T: 302.888.1544 STRUCTURAL ENGINEER:

BKP

STRUCTURAL DESIGN STUDIO, INC 2225 EAST MURRAY HOLLADAY RD SALT LAKE CITY, UT 84117 T: 801.274.3950

MEP ENGINEER: KOVACS, WHITNEY & ASSOCIATES 190 WEST OSTEND ST, STE 300 BALTIMORE, MD 21230 T: 410.244.7191

# CLIENT: MARYLAND ZQO

THE MARYLAND ZOO IN BALTIMORE 1 SAFARI PLACE BALTIMORE, MD 21217

HIS DRAWING IS TO ILLUSTRATE THE WORK TO BE DONE. THE ARCHITECT IS NOT RESPONSIBLE FOR THE MEANS, METHODS, TECHNIQUES, SEQUENCES, AND PROCEDURES USED TO DO THE WORK OR THE SAFETY ASPECTS OF CONSTRUCTION, AND NOTHING ON THIS DRAWING EXPRESSED

OR IMPLIED CHANGES THIS CONDITION. CONTRACTOR SHALL BE RESPONSIBLE FOR KNOWING HOW THEY AFFECT THE WORK SUBMITTAL OF A BID TO PERFORM THIS WORK IS AN ACKNOWLEDGEMENT OF THESE RESPONSIBILITIES, AND THAT THEY HAVE BEEN FULLY CONSIDERED IN PLANNING OF THE WORK. AND THE BID PRICE. NO CLAIMS FOR EXTRA CHARGES DUE TO

THESE CONDITIONS WILL BE FORTHCOMING.

SEAL:




DATE: JANUARY 14, 202	5			
PROJECT NO: 2023-10.04				
DRAWN BY	MJE			
CHECKED BY	CMS			
SUBMISSION	DATE			
BID SET	01/14/2025			
REVISION	DATE			

DRAWING TITLE:

STORMWATER MANAGEMENT PLAN


DRAWING NO:



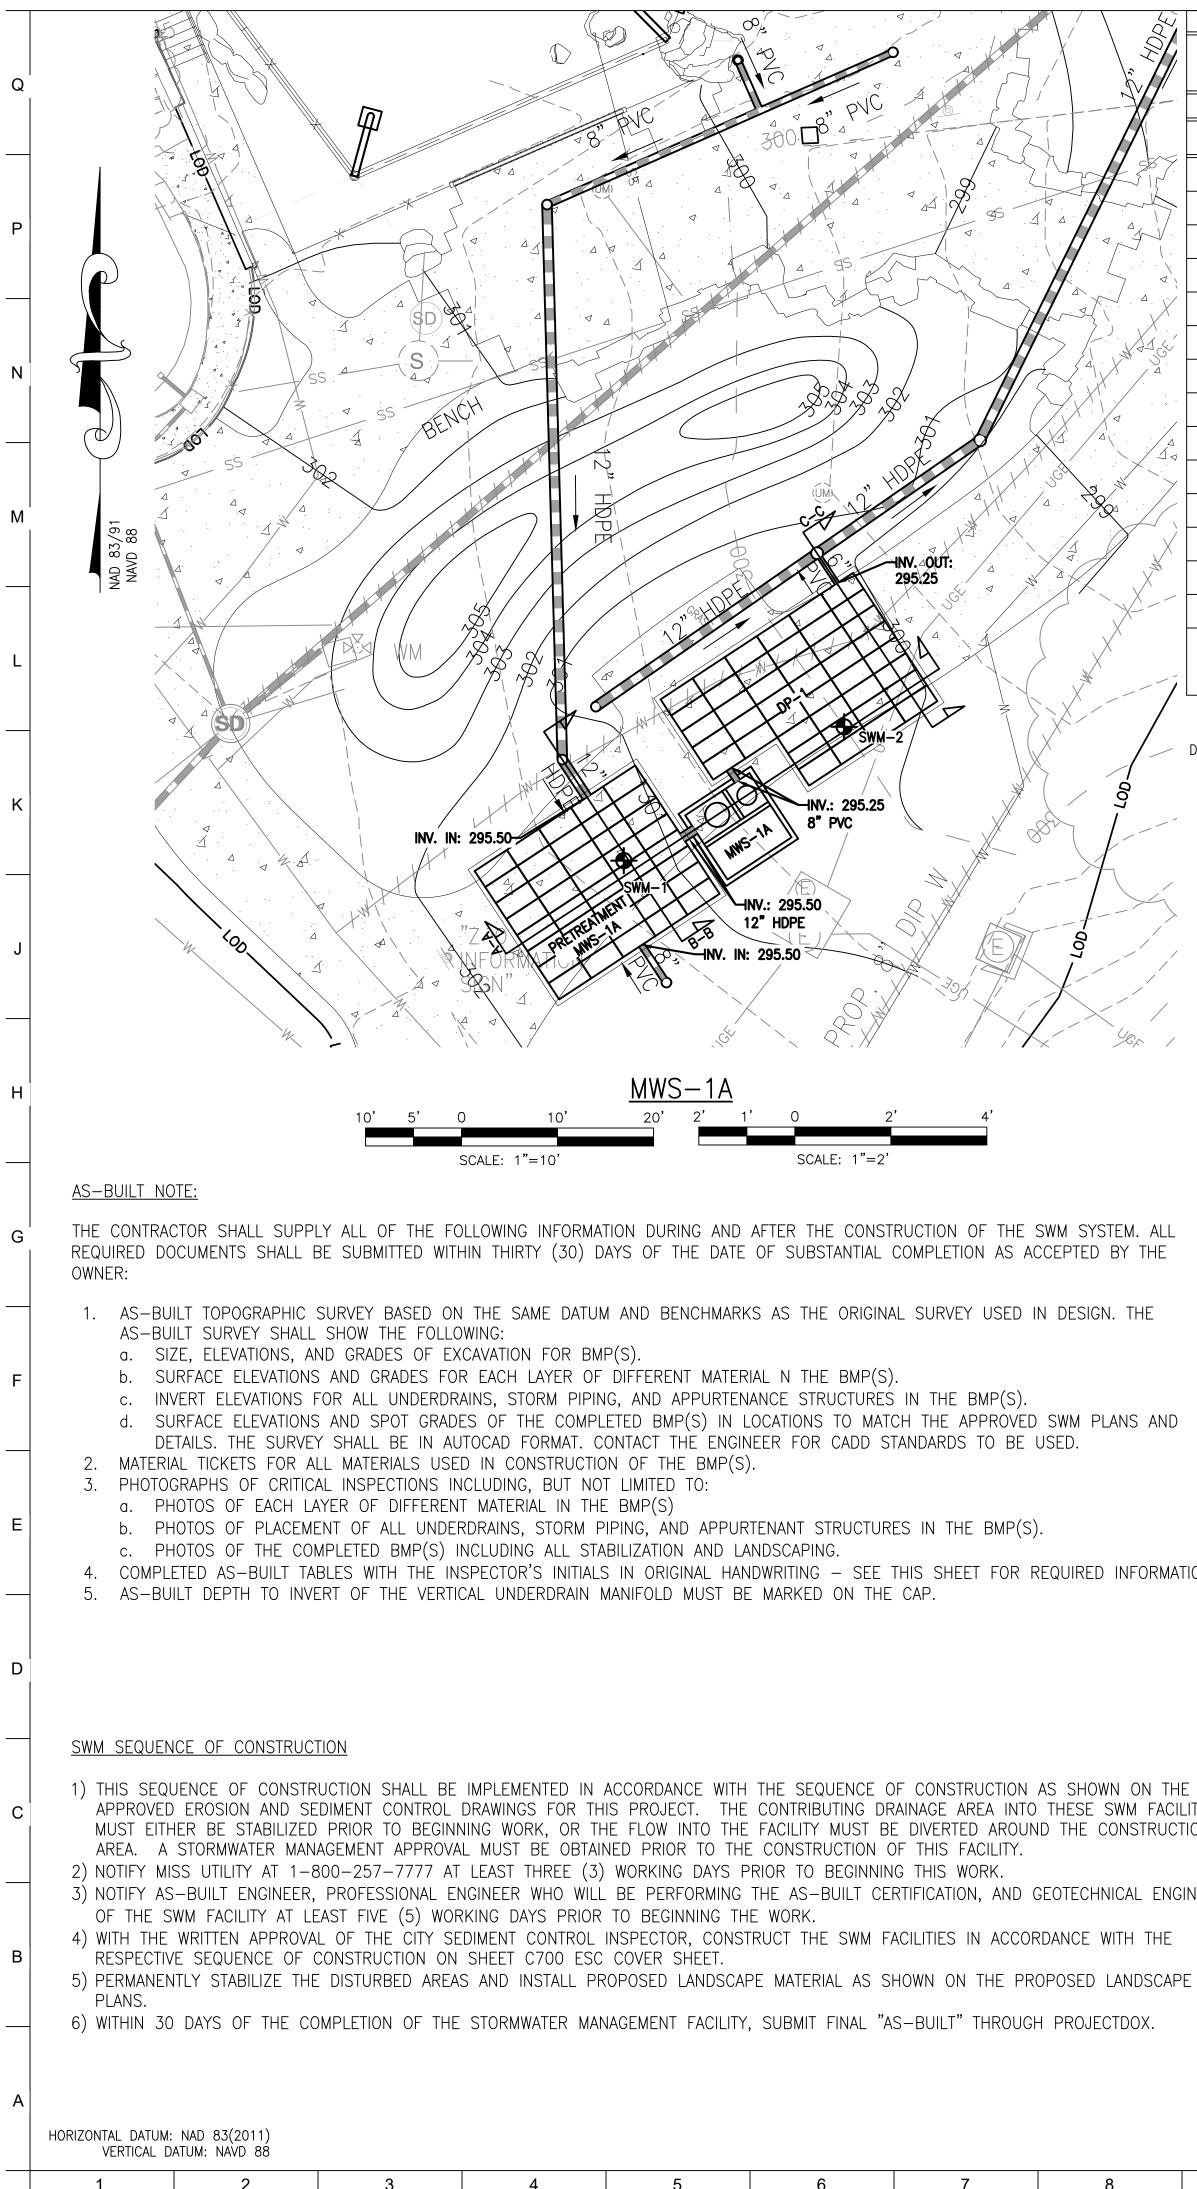


	PROJECT NAME: MARYLAND ZOO RED PANDA	EXHIBIT BALTIMORE CITY BCN	NR NO. 11545	MAINTENANCE AND LIABILITY
$\setminus \mathbb{Z}$	AS-BUILT DATA FOR MOL	DULAR WETLAND FACIL	LITY	MAINTENANCE OF THE STORMWATER MANAGEM
	*TO BE COMPLETED BY T	HE PROJECT CONTRACTOR		FOR ALL DAMAGE OR INJURIES THAT MAY BE SUST
	BMP ID: MWS-1A			FAILURE OR MALFUNCTION OF THE STORMWATER
	FEATURE	DESIGN	*AS-BUILT	
	FACILITY DETAIL	MWS-L-8-8-V		PRINT NAME
Think	FACILITY LxW	9' × 9'		ADDRESS
	TOP OF FACILITY	300.40		
	MIN. TOP OF GRADE (3" MULCH)	300.65		AS-BUILT CERTIFICATION
	BOTTOM OF FACILITY (INTERNAL)	295.25		I HEREBY CERTIFY THAT THE FACILITY SHOWN ON T "AS-BUILT" PLANS AND MEETS THE APPROVED PLA
- 1- 4-1- C+	BOTTOM OF FACILITY (EXTERNAL)	294.59		
	INLET SIZE & TYPE	12"HDPE		PRINT NAME
	INLET INVERT	295.50		
	MWS INTERNAL WIER LENGTH / ELEVATION	3.5' / 298.12		ADDRESS
A N Y	PRETREATMENT CHAMBER SIZE & TYPE	STORMBRIX 2'W X 4'L X 3'H		CONTRACT
The last	TOTAL PRETREATMENT CHAMBER UNITS/VOLUME	40 UNITS / 796 C.F.		AS-BUILT PLANS AND CERTIFICATIONS ARE REC
	PRETREATMENT CHAMBER INVERT	295.50		THESE MUST BE PREPARED AND SEALED BY A I BALTIMORE CITY WILL NOT PERFORM THE INSI
	OUTLET PIPE SIZE & TYPE	1.5 FT 8" PVC		CERTIFICATION. THE STORMWATER MANAGE

- STANDARDS
- INSTALLATION HAS BEEN COMPLETED.
- CONTROL MEASURES.
- REQUIREMENTS.

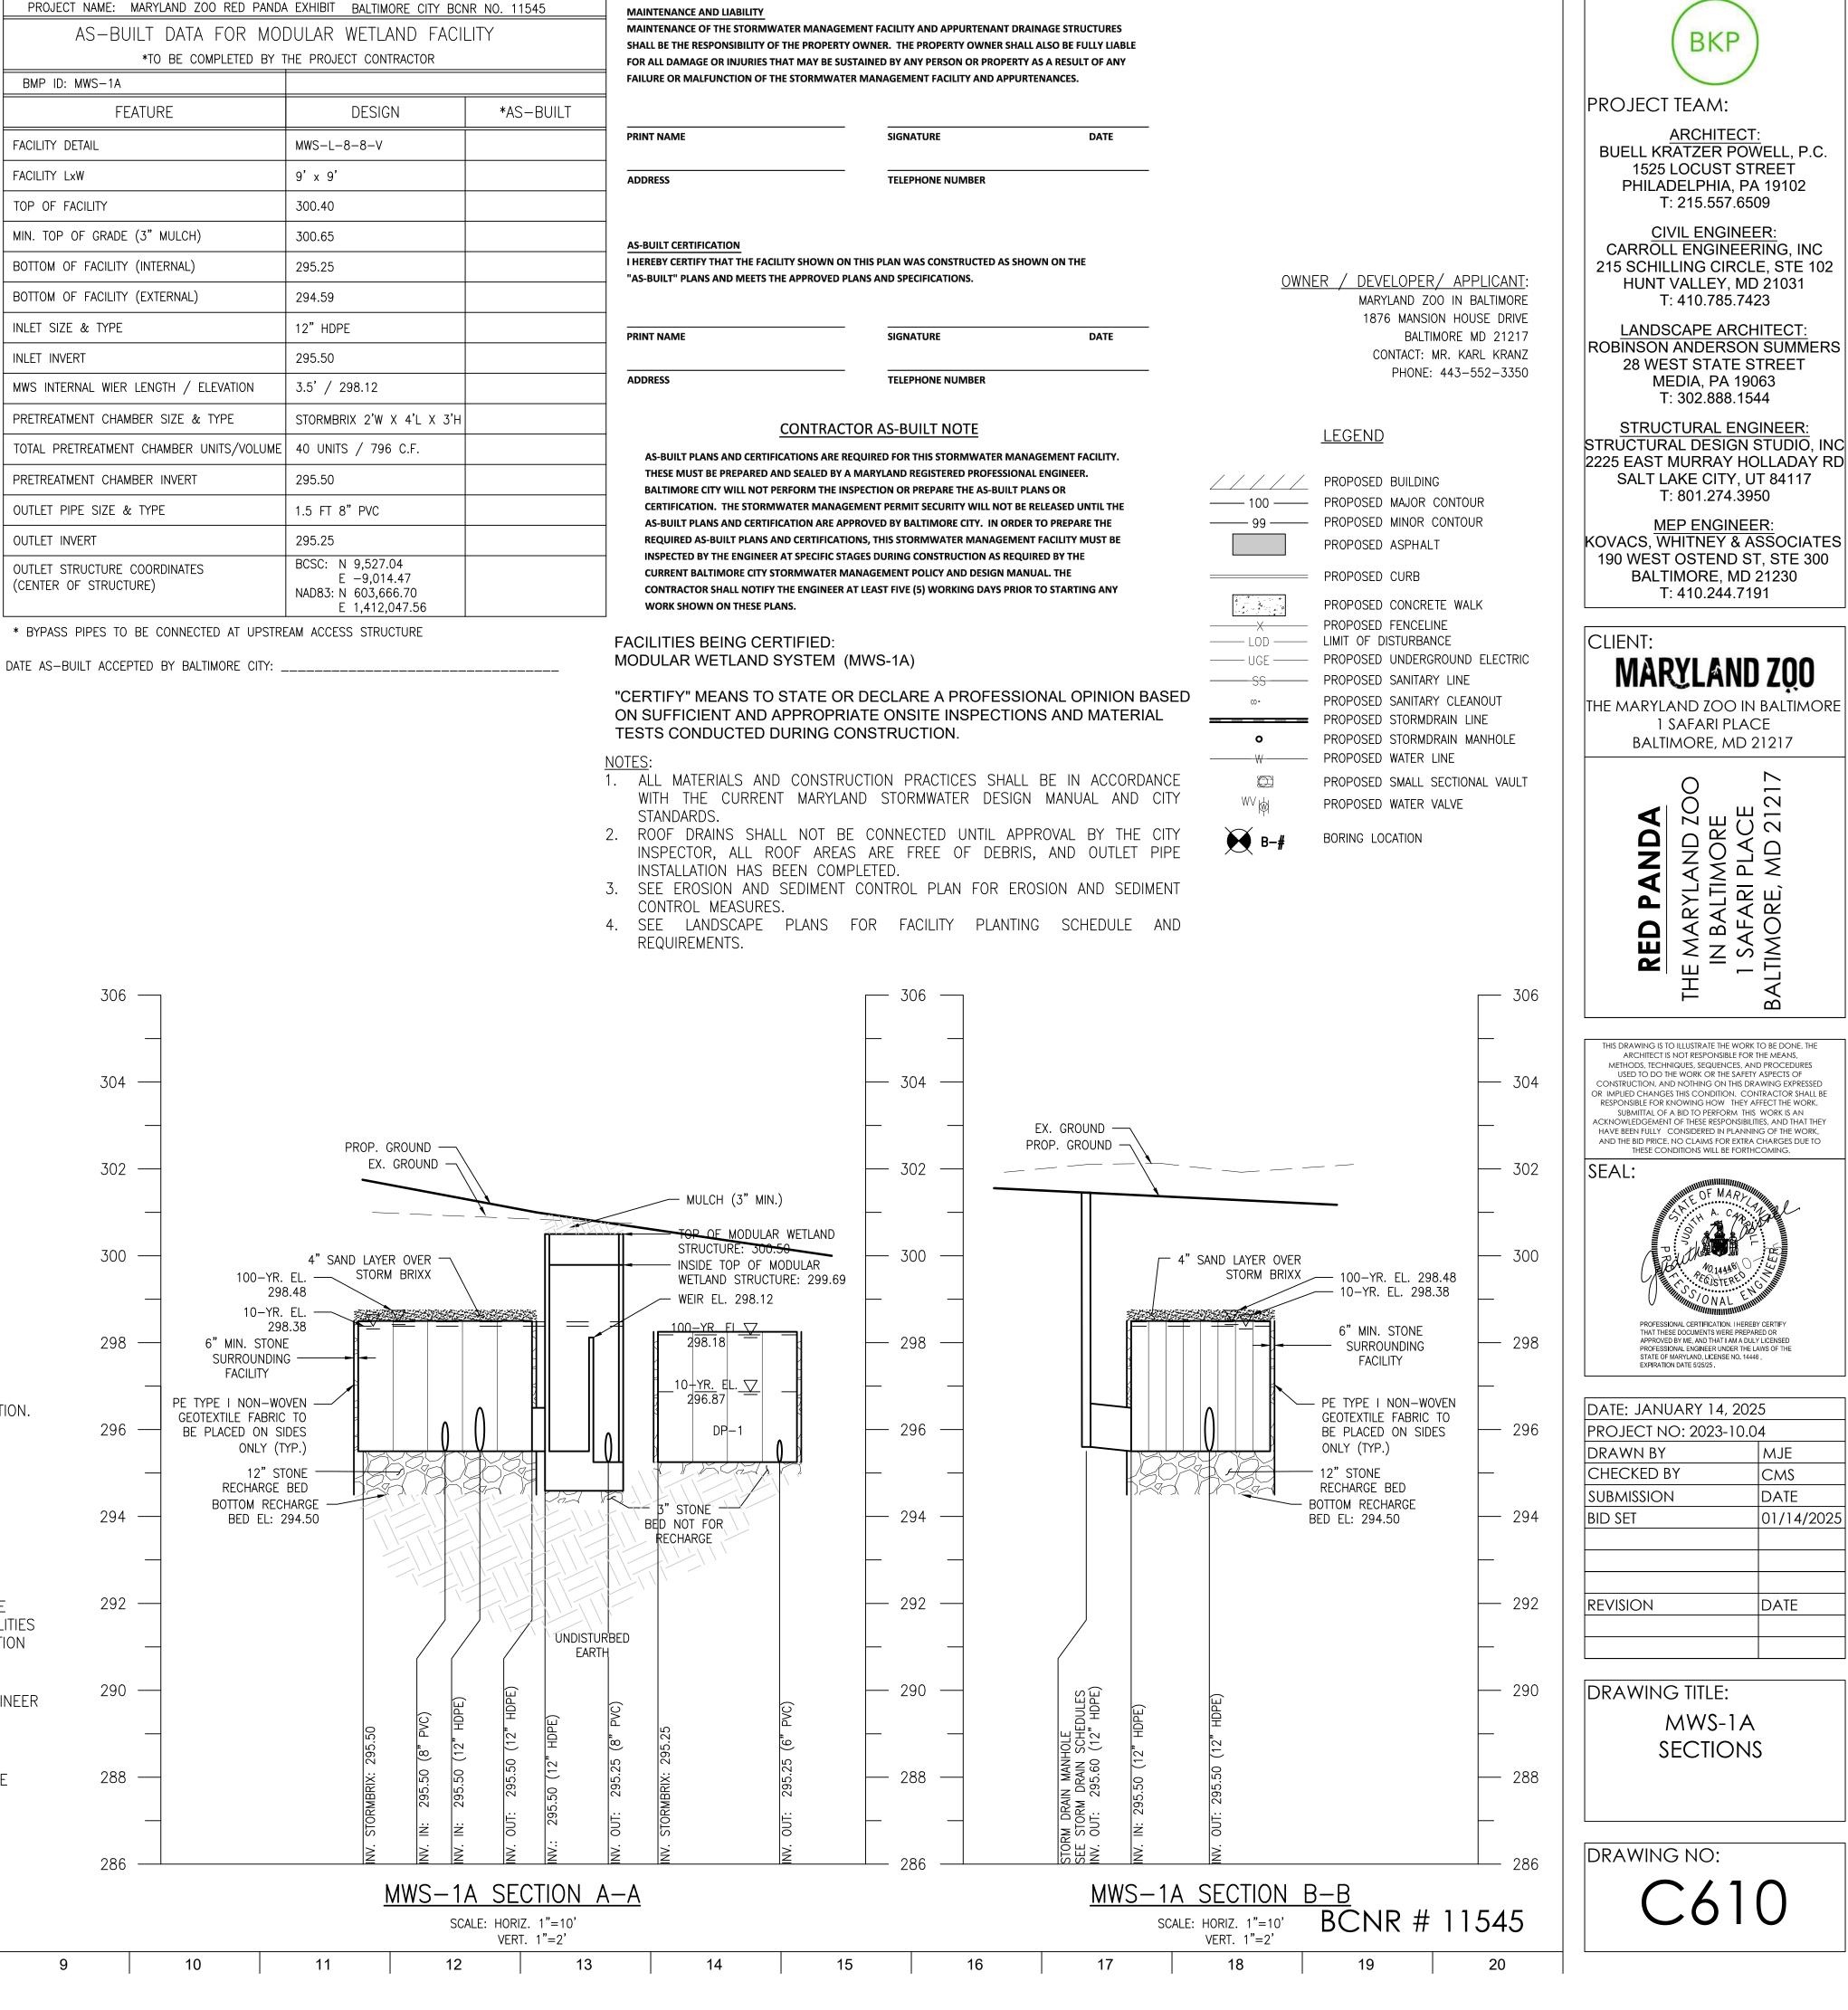


E SWM SYSTEM. ALL ACCEPTED BY THE
IN DESIGN. THE
ED SWM PLANS AND E USED.
S). REQUIRED INFORMATION.
N AS SHOWN ON THE TO THESE SWM FACILITIES JND THE CONSTRUCTION
GEOTECHNICAL ENGINEER
ORDANCE WITH THE
PODOSED LANDSCADE

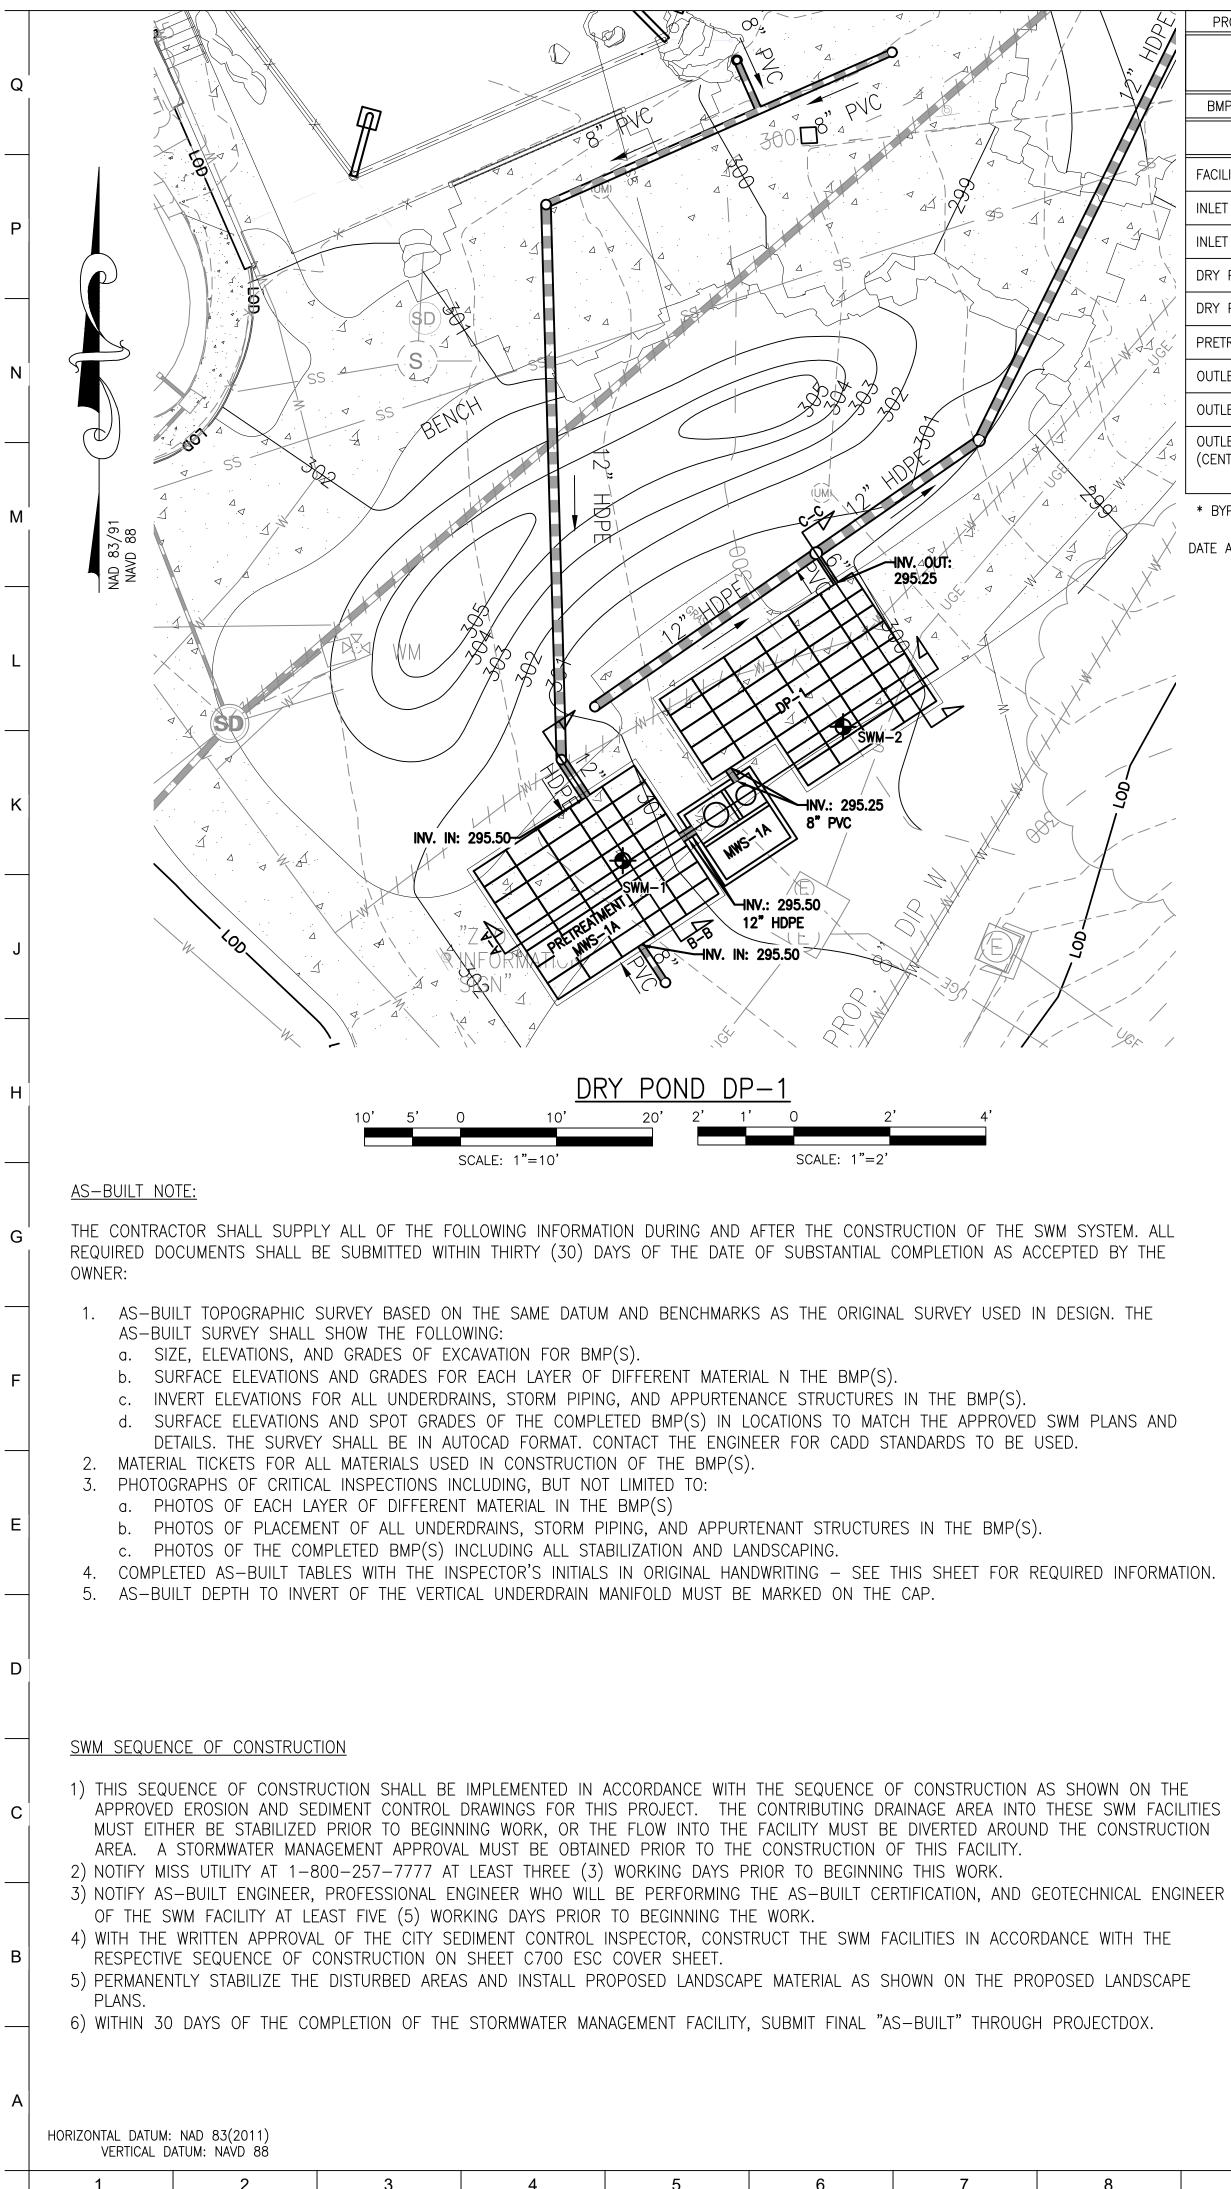



q	PROJECT NAME: MARYLAND ZOO RED P	ANDA EXHIBIT BALTIMORE CITY BCNF	R NO. 11545	MAINTENANCE AND LIABILITY	
		TA FOR DRY POND by the project contractor		MAINTENANCE OF THE STORMWATER SHALL BE THE RESPONSIBILITY OF THE FOR ALL DAMAGE OR INJURIES THAT I	PROPERTY OWNER. THE
¥[	BMP ID: DP-1			FAILURE OR MALFUNCTION OF THE ST	
X	FEATURE	DESIGN	*AS-BUILT	=	
SBY.	FACILITY DETAIL	DP-1		PRINT NAME	SIGNA
-th	INLET SIZE & TYPE	8" PVC		ADDRESS	TELEP
	INLET INVERT	295.25			
	DRY POND CHAMBER SIZE & TYPE	STORMBRIX 2'W X 4'L X 3'H		AS-BUILT CERTIFICATION	
	DRY POND CHAMBER UNITS/VOLUME	42 UNITS / 958 C.F.		I HEREBY CERTIFY THAT THE FACILITY S	
AA GE	PRETREATMENT CHAMBER INVERT	295.25			
	OUTLET PIPE SIZE & TYPE	6" PVC		PRINT NAME	SIGNA
· · ·	OUTLET INVERT	295.25			
	OUTLET STRUCTURE COORDINATES (CENTER OF STRUCTURE)	BCSC: N 9,549.49 E -9,005.21 NAD83: N 603,689.19 E 1,412,056.72		ADDRESS	TELEP
/					

- STANDARDS
- INSTALLATION HAS BEEN COMPLETED.
- CONTROL MEASURES.
- REQUIREMENTS.

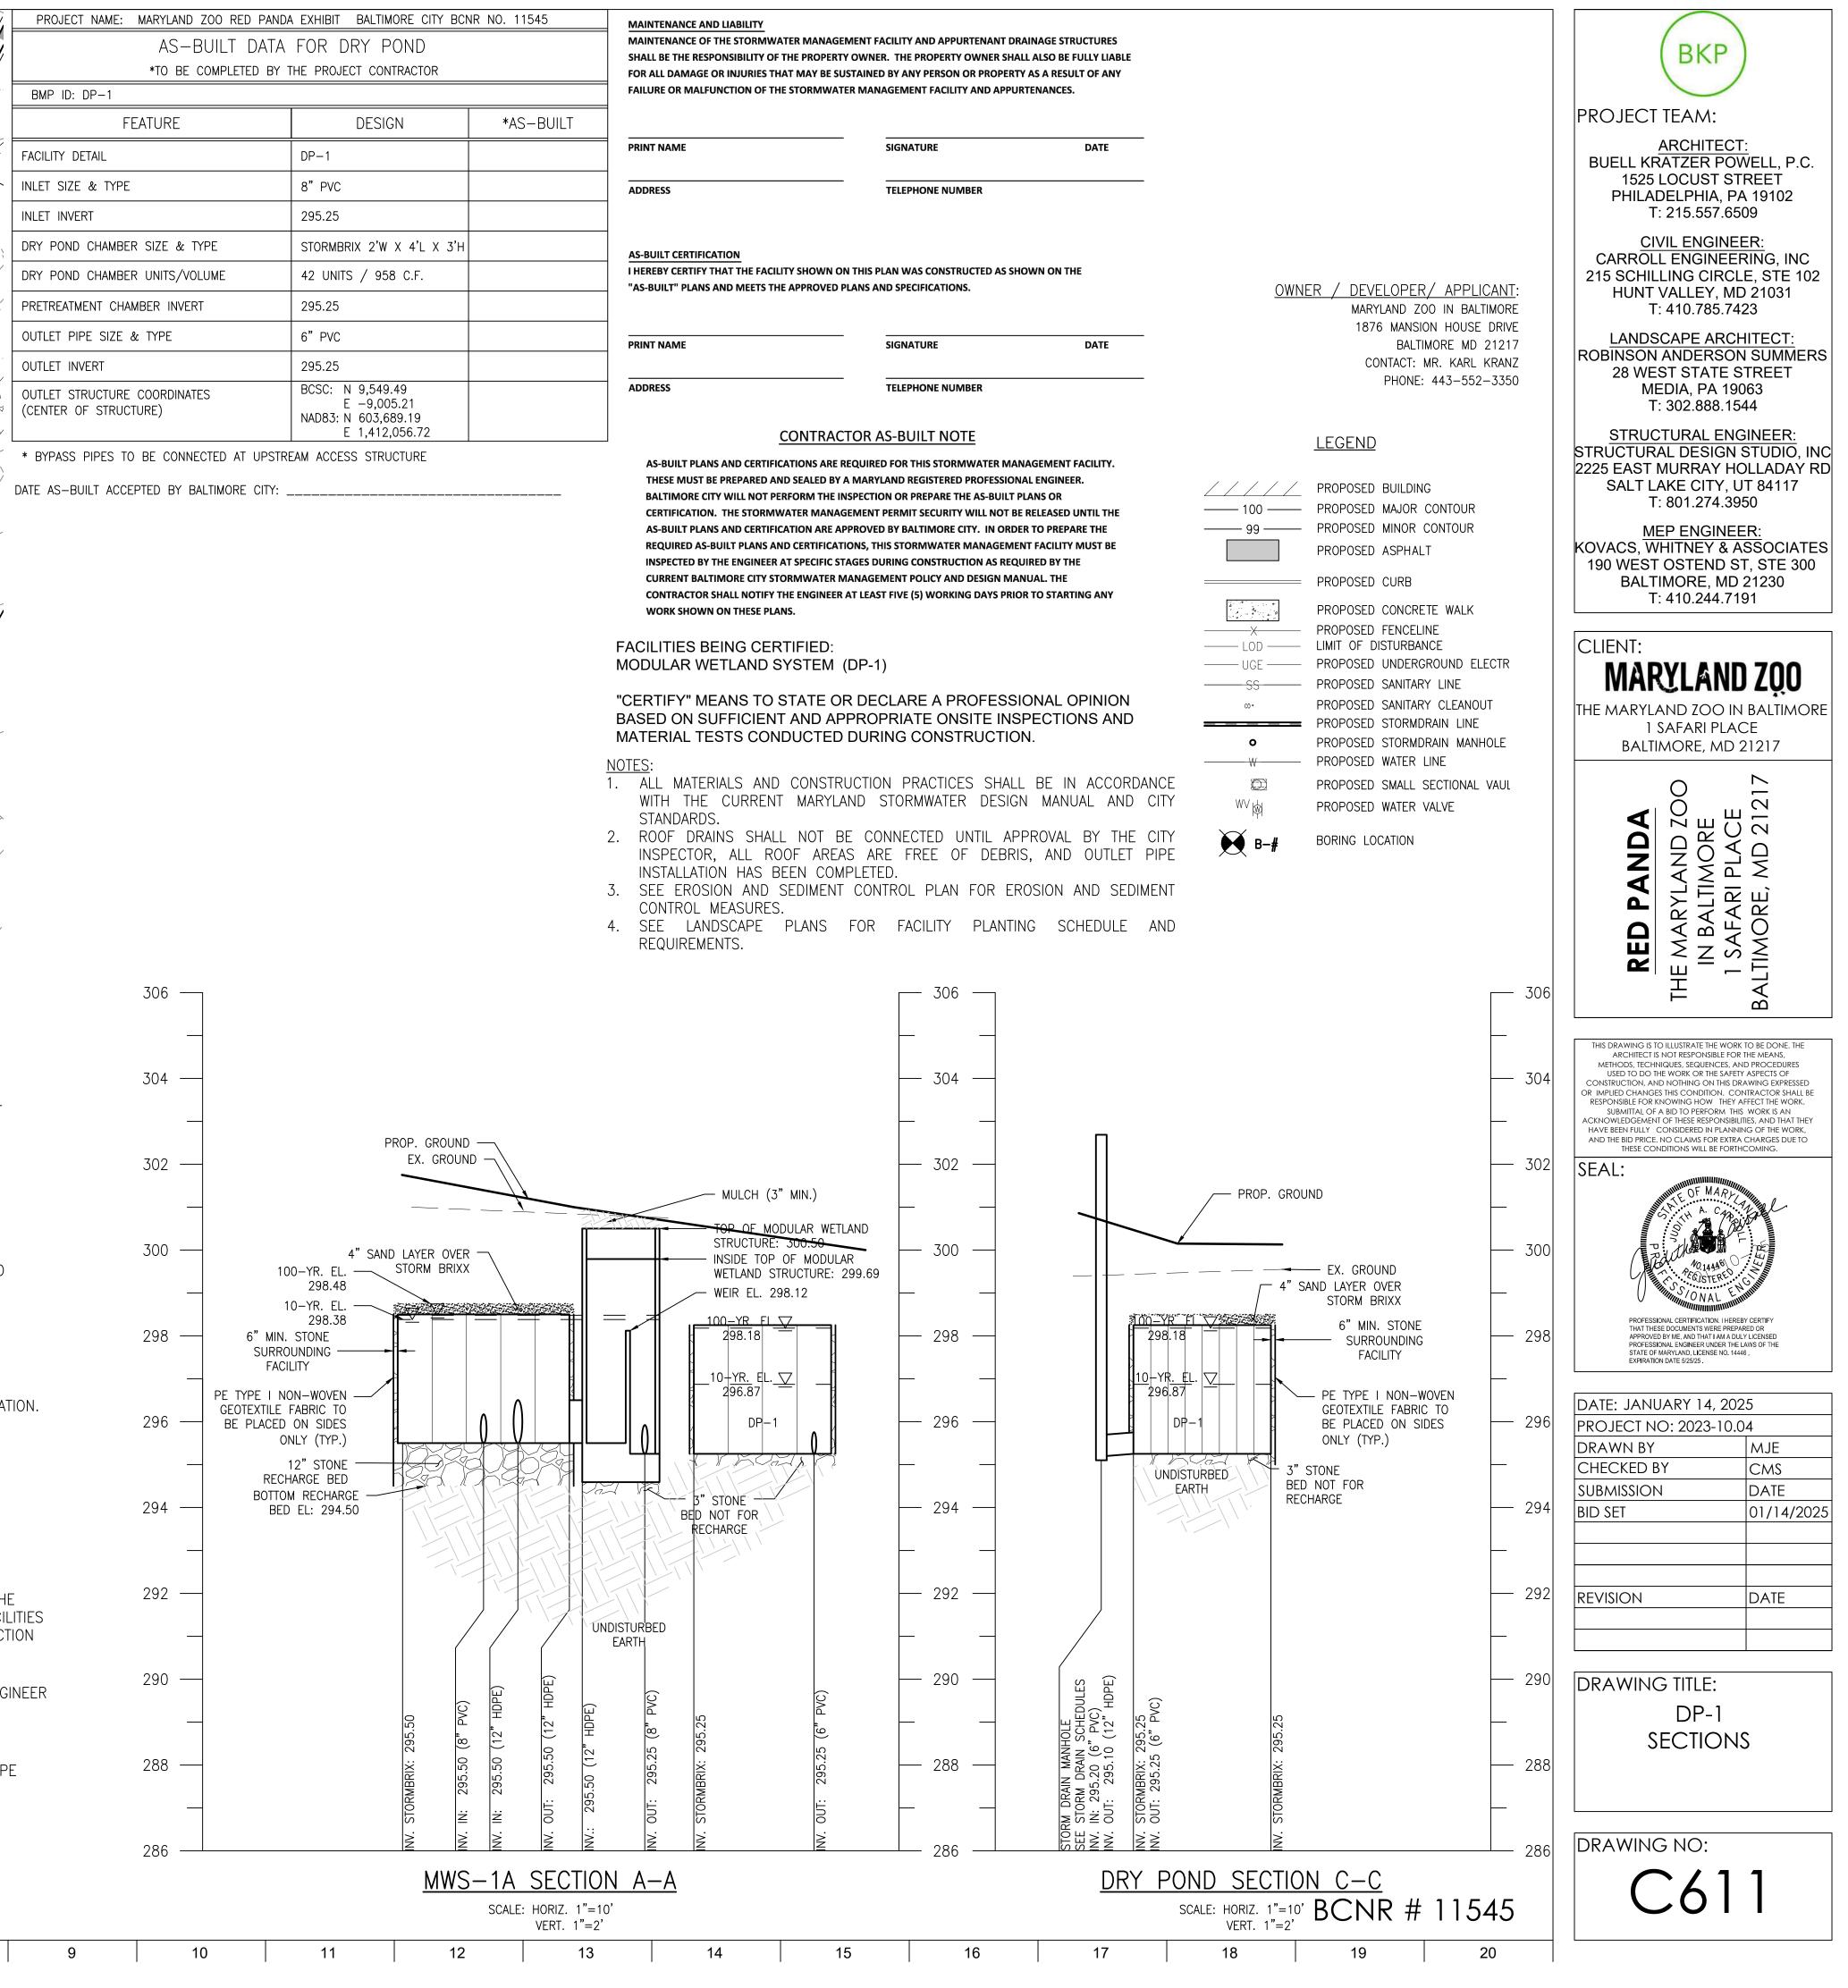

	qop
881	
907	

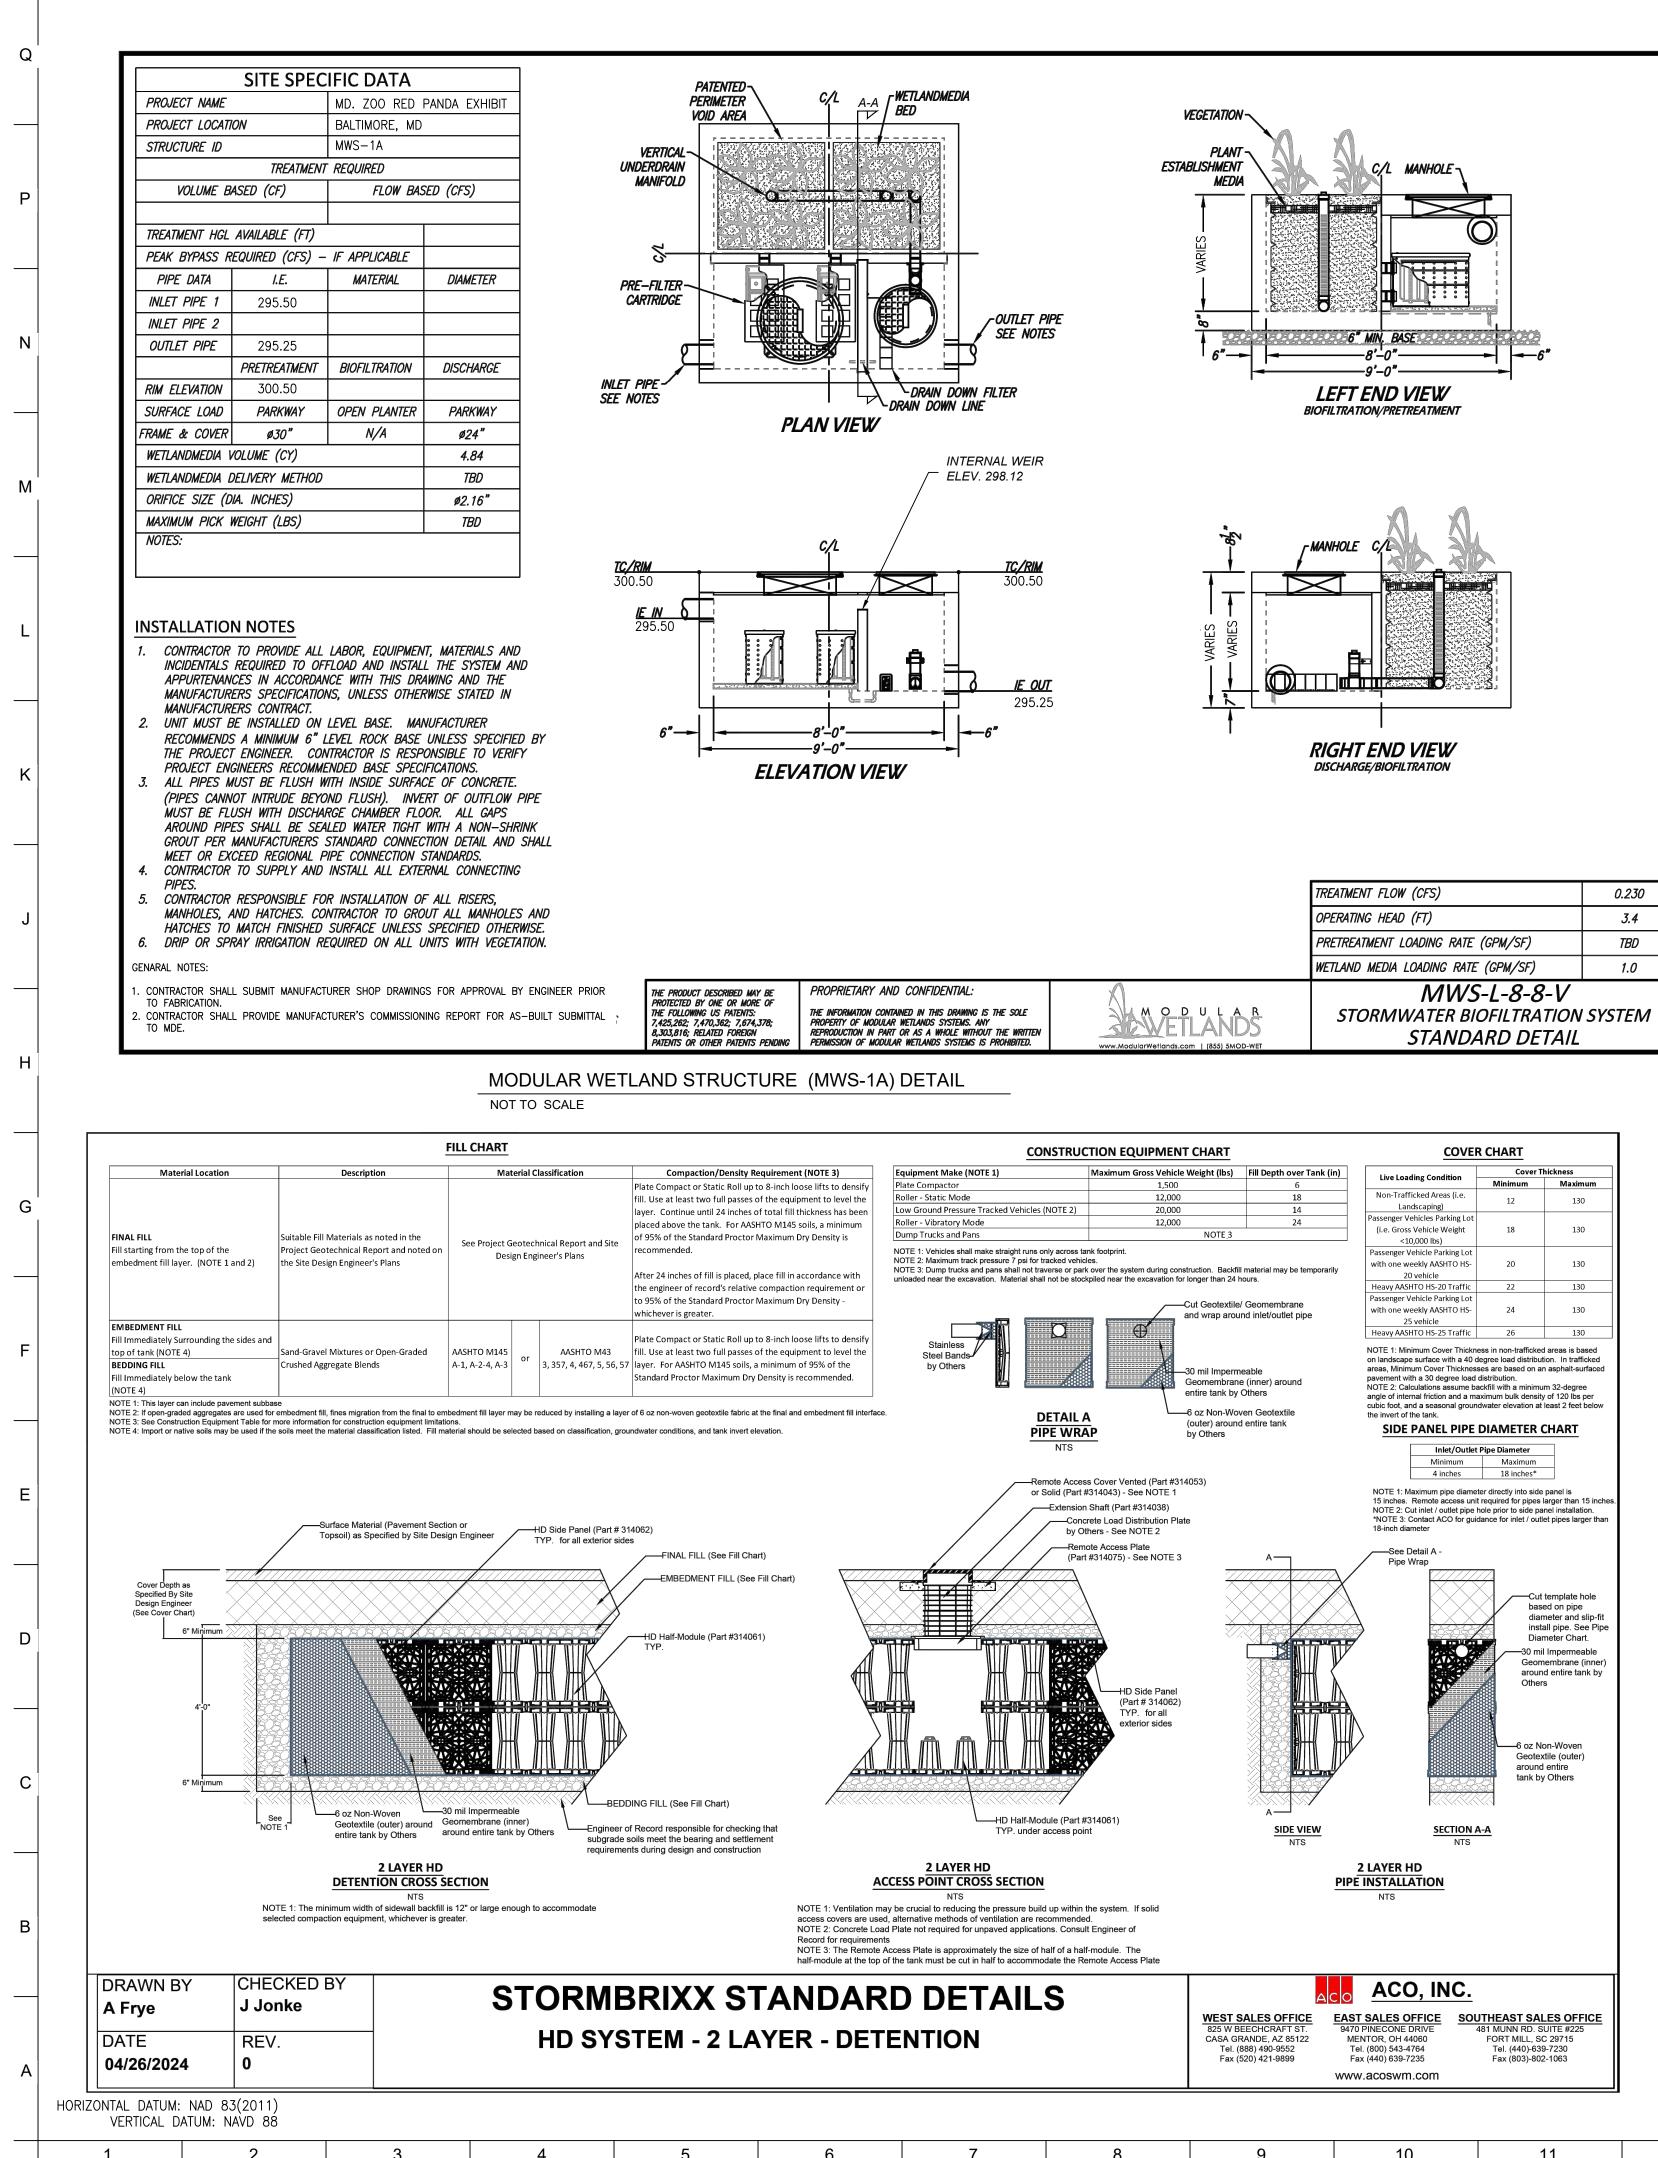

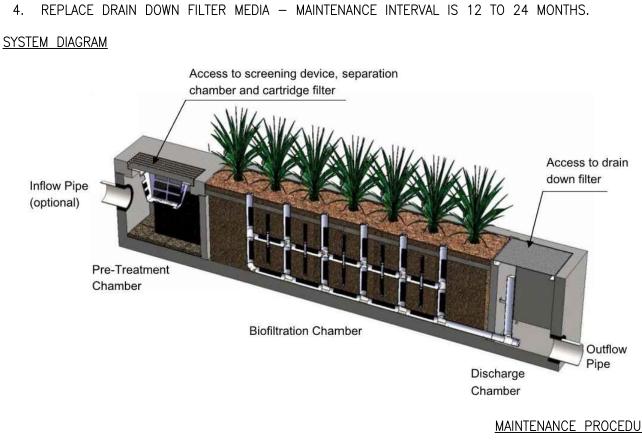

### SCREENING DEVICE

- MAINTENANCE CAN BE PERFORMED WITHOUT ENTRY.

INSPECTION AND MAINTENANCE SCHEDULE - MODULAR WETLAND SYSTEM

- TRUCK WILL NOT DAMAGE THE SCREENING DEVICE.
- OR MANHOLE COVER WHEN COMPLETED.


### SEPARATION CHAMBER

- PERFORM MAINTENANCE PROCEDURES OF SCREENING DEVICE LISTED ABOVE BEFORE MAINTAINING THE SEPARATION CHAMBER. WITH A PRESSURE WASHER, SPRAY DOWN POLLUTANTS ACCUMULATED ON WALLS AND CARTRIDGE FILTERS.
- CARTRIDGE FILTERS
- PERFORM MAINTENANCE PROCEDURES ON SCREENING DEVICE AND SEPARATION CHAMBER BEFORE MAINTAINING CARTRIDGE FILTERS. ENTER SEPARATION CHAMBER.
- UNSCREW THE TWO BOLTS HOLDING THE LID ON EACH CARTRIDGE FILTER AND REMOVE LID.
- REMOVE EACH OF 4 TO 8 MEDIA CAGES HOLDING THE MEDIA IN PLACE. SPRAY DOWN THE CARTRIDGE FILTER TO REMOVE ANY ACCUMULATED POLLUTANTS.
- VACUUM OUT OLD MEDIA AND ACCUMULATED POLLUTANTS.
- PURCHASE 8. REPLACE THE LID AND TIGHTEN DOWN BOLTS. REPLACE SCREENING DEVICE, GRATE OR MANHOLE COVER WHEN COMPLETED.
- DRAIN DOWN FILTER 1. REMOVE HATCH OF MANHOLE COVER OVER DISCHARGE CHAMBER AND ENTER CHAMBER.
- PI ACF 3. EXIT CHAMBER AND REPLACE HATCH OR MANHOLE COVER.

- AVAILABLE TO THE GOVERNING MUNICIPALITY FOR INSPECTION UPON REQUEST AT ANY TIME.
- ENTRY INTO CHAMBERS MAY REQUIRE CONFINED SPACE TRAINING BASED ON STATE AND LOCAL REGULATIONS.
- NO FERTILIZER SHALL BE USED IN THE BIOFILTRATION CHAMBER.
- SPECIES. SOME PLANTS MAY REQUIRE IRRIGATION.

### MEDIA MATERIAL SPECIFICATION FOR MODULAR WETLANDS:

MEDIA SHALL CONSIST OF CERAMIC MATERIAL PRODUCED BY EXPANDING AND VITRIFYING SELECT MATERIAL IN A ROTARY KILN. MEDIA MUST BE PRODUCED TO MEET THE REQUIREMENTS OF ASTM C330, ASTM C331, AND AASHTO M195. AGGREGATES MUST HAVE A MINIMUM 24-HOUR WATER ABSORPTION OF 10.5% MASS. MEDIA SHALL NOT CONTAIN ANY ORGANIC MATERIAL. FLOW THROUGH MEDIA SHALL BE HORIZONTAL FROM THE OUTER PERIMETER OF THE CHAMBER TOWARD THE CENTRALIZED AND VERTICALLY EXTENDING UNDERDRAIN. THE RETENTION TIME IN THE MEDIA SHALL BE AT LEAST 3 MINUTES. DOWNWARD FLOW FILTERS ARE NOT ACCEPTABLE ALTERNATIVES. THE THICKNESS OF THE MEDIA SHALL BE AT LEAST 19" FROM INFLUENT END TO EFFLUENT END. THE LOADING RATE ON THE MEDIA SHALL NOT EXCEED 1.1 GALLONS PER MINUTE PER SQUARE FOOT SURFACE. AREA. MEDIA MUST BE CONTAINED WITHIN STRUCTURE THAT SPACES THE SURFACE OF THE MEDIA AT LEAST 2" FROM ALL VERTICALLY EXTENDING WALLS OF THE CONCRETE STRUCTURE. MEDIA MUST BE CONTAINED WITHIN STRUCTURE THAT SPACES THE SURFACE OF THE MEDIA AT LEAST 2" FROM ALL VERTICALLY EXTENDING WALLS OF THE CONCRETE. STRUCTURE. MEDIA SHALL BE PROPRIETARY MEDIA FROM MODULAR WETLAND SYSTEM MANUFACTURER OR APPROVED EQUAL.

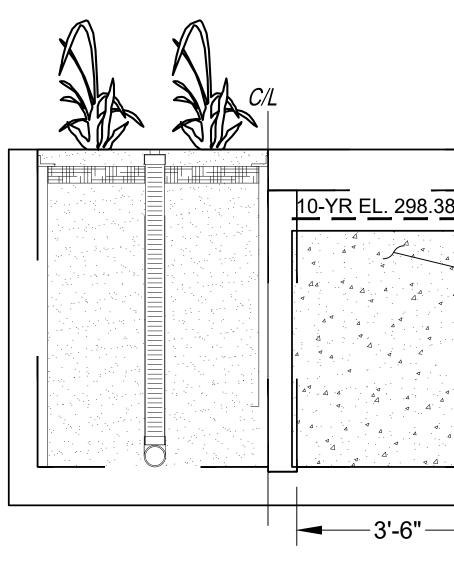

# MODULAR WETLAND SE

16

12 10 11 13 14 15

REMOVE TRASH FROM SCREENING DEVICE - MAINTENANCE INTERVAL IS 6 TO 12 MONTHS. REMOVE SEDIMENT FROM SEPARATION CHAMBER - MAINTENANCE INTERVAL IS 12 TO 24 MONTHS. REPLACE CARTRIDGE FILTER MEDIA - MAINTENANCE INTERVAL IS 12 TO 24 MONTHS.

> <u>OWNER / DEVELOPER/ APPLICANT</u>: MARYLAND ZOO IN BALTIMORE 1876 MANSION HOUSE DRIVE BALTIMORE MD 21217 CONTACT: MR. KARL KRANZ PHONE: 443-552-3350

MAINTENANCE PROCEDURES

1. REMOVE GRATE OR MANHOLE COVER TO GAIN ACCESS TO THE SCREENING DEVICE IN THE PRE-TREATMENT CHAMBER. VAULT TYPE UNITS DO NOT HAVE SCREENING DEVICE. REMOVE ALL POLLUTANTS COLLECTED BY THE SCREENING DEVICE. REMOVAL CAN BE DONE MANUALLY OR WITH THE USE OF A VACUUM TRUCK. THE HOSE OF THE VACUUM 3. SCREENING DEVICE CAN EASILY BE REMOVED FROM THE PRE-TREATMENT CHAMBER TO GAIN ACCESS TO SEPARATION CHAMBER AND MEDIA FILTERS BELOW. REPLACE GRATE

VACUUM OUT SEPARATION CHAMBER AND REMOVE ALL ACCUMULATED POLLUTANTS. REPLACE SCREENING DEVICE, GRATE OR MANHOLE COVER WHEN COMPLETED.

REINSTALL MEDIA CAGES AND FILL WITH NEW MEDIA FROM MANUFACTURER OR OUTSIDE SUPPLIER. MANUFACTURER WILL PROVIDE SPECIFICATION OF MEDIA AND SOURCES TO

2. UNLOCK AND LIFT DRAIN DOWN FILTER HOUSING AND REMOVE OLD MEDIA BLOCK. REPLACE WITH NEW MEDIA BLOCK. LOWER DRAIN DOWN FILTER HOUSING AND LOCK INTO

## MAINTENANCE NOTES

1. FOLLOWING MAINTENANCE AND/OR INSPECTION, IT IS RECOMMENDED THE MAINTENANCE OPERATOR PREPARE A MAINTENANCE/INSPECTION RECORD. THE RECORD SHOULD INCLUDE ANY MAINTENANCE ACTIVITIES PERFORMED, AMOUNT AND DESCRIPTION OF DEBRIS COLLECTED, AND CONDITION OF THE SYSTEM AND ITS VARIOUS FILTER MECHANISMS. 2. THE OWNER SHOULD KEEP MAINTENANCE/INSPECTION RECORD(S) FOR A MINIMUM OF FIVE YEARS FROM THE DATE OF MAINTENANCE. THESE RECORDS SHOULD BE MADE TRANSPORT ALL DEBRIS, TRASH, ORGANICS AND SEDIMENTS TO AN APPROVED FACILITY FOR DISPOSAL IN ACCORDANCE WITH LOCAL AND STATE REQUIREMENTS.

6. IRRIGATION SHOULD BE PROVIDED AS RECOMMENDED BY THE MANUFACTURER AND/OR LANDSCAPE ARCHITECT. THE AMOUNT OF IRRIGATION REQUIRED IS DEPENDENT ON PLANT

	WEIR TOP 298.12 — BYPASS OVERFLOW WEIR	
	WEIR BOTTOM 295.25	
CTION A-	<u>–A</u>	BCNR # 1

T: 302.888.1544 STRUCTURAL ENGINEER: STRUCTURAL DESIGN STUDIO, INC 2225 EAST MURRAY HOLLADAY RD SALT LAKE CITY, UT 84117 T: 801.274.3950 MEP ENGINEER: KOVACS, WHITNEY & ASSOCIATES 190 WEST OSTEND ST, STE 300 BALTIMORE, MD 21230 T: 410.244.7191 CLIENT: MARYLAND ZQO THE MARYLAND ZOO IN BALTIMORE 1 SAFARI PLACE BALTIMORE, MD 21217  $\sim$  $\bigcirc$  $\sim$ Ο Z U K K ш ARYLAND Z ALTIMORE FARI PLAC DRE, MD 2 Ζ Δ AFA AOR ₹ Å <sup>⊥</sup> Ž Z S × ш 2 ш m HIS DRAWING IS TO ILLUSTRATE THE WORK TO BE DONE. THE ARCHITECT IS NOT RESPONSIBLE FOR THE MEANS. METHODS, TECHNIQUES, SEQUENCES, AND PROCEDURES USED TO DO THE WORK OR THE SAFETY ASPECTS OF CONSTRUCTION, AND NOTHING ON THIS DRAWING EXPRESSED R IMPLIED CHANGES THIS CONDITION. CONTRACTOR SHALL BE RESPONSIBLE FOR KNOWING HOW THEY AFFECT THE WORK SUBMITTAL OF A BID TO PERFORM THIS WORK IS AN ACKNOWLEDGEMENT OF THESE RESPONSIBILITIES, AND THAT THEY HAVE BEEN FULLY CONSIDERED IN PLANNING OF THE WORK AND THE BID PRICE. NO CLAIMS FOR EXTRA CHARGES DUE TO THESE CONDITIONS WILL BE FORTHCOMING SEAL: PROFESSIONAL CERTIFICATION. I HEREBY CERTIF T THESE DOCUMENTS WERE PREPARED O APPROVED BY ME, AND THAT I AM A DULY LICENSI PROFESSIONAL ENGINEER UNDER THE LAWS OF THE STATE OF MARYLAND, LICENSE NO. 14446 , EXPIRATION DATE 5/25/25 . DATE: JANUARY 14, 2025 PROJECT NO: 2023-10.04 DRAWN BY MJE CHECKED BY CMS DATE SUBMISSION BID SET 01/14/2025 DATE REVISION DRAWING TITLE: SWM DETAILS

BKP

ARCHITECT:

BUELL KRATZER POWELL, P.C.

1525 LOCUST STREET

PHILADELPHIA, PA 19102

T: 215.557.6509

CIVIL ENGINEER:

CARROLL ENGINEERING, INC 215 SCHILLING CIRCLE, STE 102

HUNT VALLEY, MD 21031

T: 410.785.7423

LANDSCAPE ARCHITECT:

ROBINSON ANDERSON SUMMERS

28 WEST STATE STREET

MEDIA, PA 19063

PROJECT TEAM:

DRAWING NO:




19

1545

Q	B. TOTAL CU C. TOTAL FILI CUT/ FILL TOTAI	URBED: 0.77 ACRES T: 1,625 CUBIC YAF L: 525 CUBIC YARD _S ARE FOR PERMIT REV	RDS IS /IEW ONLY. CON	TRACTOR	IS RESP	ONSIBLE	FOR			T
P	CALCULATING CU	IT/ FILL QUANTITIES FOR QUANTITIES ACTUALLY EN	ESTIMATION PL	JRPOSES.	ENGINEE	R OFFER	S NO	F	۲P	t SOS
N										
M	INDEX	OF SHEETS								
	<u>SHEET NO.</u>	SHEET DESIGNATION	DESCRIPTION							
	1 2 3 4	C700 C701 C710 C720	ESC COVER ESC PLAN ESC DETAILS ESC NOTES	SHEEI						
L	5 6 7	C721 C722 DA-1	ESC NOTES ESC SECTION DRAINAGE AR		т					
	8 9 10	SWM-1 SWM-2 SWM-3	EXISTING COI IART EXHIBIT BMP EXHIBIT							
к	11 12 13	SWM-4 SWM-5 C100	PROPOSED C EXISTING CON EXISTING CON	NDITIONS NDITIONS	SITE PHO PLAN	DTOS EXH	IIBIT			
	14 15 16 17	C101 C110 C111 C120	EXISTING CON BORING PLAN BORING LOGS DEMOLITION I	5	UIILIIY F	'LAN				
	18 19 20	C200 C210 C300	PROPOSED C PROPOSED G DETAIL REFER	ONDITIONS RADING P	LAN					
J	21 22 23	C310 C311 C400	SITE DETAILS SITE DETAILS PROP UTILITII	ES PLAN						
	24 25 26 27	C410 C411 C412 C420	UTILITY PROF UTILITY PROF UTILITY PROF UTILITY DETAI	ILES ILES						
н	27 28 29 30	C420 C421 C500 C510	UTILITY DETAI STORM DRAIN STORM DRAIN	LS I KEY PLA						
	31 32 33	C520 C521 C522	STORM DRAIN STORM DRAIN STORM DRAIN	N DETAILS N DETAILS N DETAILS						
	34 35 36	C523 C524 C530	STORM DRAIN STORM DRAIN STORM DRAIN	I DETAILS I PROFILE						
G	37 38 39 40	C531 C532 C600 C610	STORM DRAIN STORM DRAIN STORMWATER MWS-1A SEC	N PROFILE MANAGEN	S	۸N				
	41 42 43	C611 C620 C800	DP-1 SECTIONS SWM DETAILS	NS	& PROF	ILES				
F										
E										
						LIZATION				
D				*STABILIZ	ZATION P		S ON AL		CTS MUSI	BE IN COMPI
				FOLLOWI	NG INITIA	L SOIL [	)ISTURB/			JRBANCE, PER
				A. DI	) THREE ICHES, F	(3) CAL	endar i R slope	DAYS AS	TO THE	SURFACE OF A ES STEEPER T
C				В.	) SEVEN	(7) CAL	ENDAR I	DAYS AS ACTIVE (		other disture
				<u>CONSTRU</u> WHERE N				NCE IS I	PROVIDED	CONTRACTOR
В				CONDITIC SEDIMEN	N THAT T SPILLE	MINIMIZE D, DROP	S TRACH PED, OF	KING OF R TRACKE	SEDIMENT D OUTSID	. IMMEDIATELY E THE LOD BY NSTRUCTION EG
	SURVEY CONTROL HORIZONTAL AND VERT WERE DERIVED USING METHODS AND PROCE	TICAL DATUM STATIC GPS		THE LOD	) TO MIN T IS ONL	IMIZE SE _Y ACCEF	DIMENT PTABLE	TRACK O	UT. WASH	ING EQUIPMEN ADEN WATER I
A	THE NATIONAL GEODETIC OPUS PROGRAM. CC USED: DL2039	CS SURVEYS DR STATIONS LOYQ CORS		NOTE TO			n∪L.			
	DH8807 HORIZONTAL DATUM: NA VERTICAL DATU									CTLY ENFORCEI WILL NOT BE A
$\rightarrow$	1	2	3	4		5		6		7

# MARYLAND ZOO RED PANDA EXHIBIT ION AND SEDIMENT CONTROL 1 SAFARI PLACE BALTIMORE, MARYLAND SEQUENCE OF CONSTRUCTION BCNR # 11545

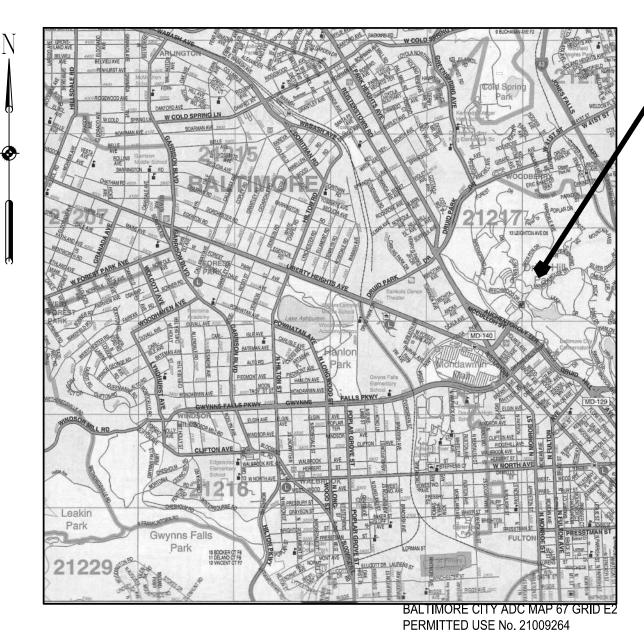

VICINITY MAP SCALE: 1"=2000'

LIANCE WITH THE REQUIREMENTS

MANENT OR TEMPORARY

ALL PERIMETER DIKES, SWALES, HAN 3 HORIZONTAL TO 1

BED OR GRADED AREAS ON THE

SHALL MAINTAIN THE SITE IN A REMOVE STONE AND/OR VACUUMING, SCRAPING, QUIPMENT PRIOR TO LEAVING T AND SUFACES TO REMOVE IS DIRECTED TO AN APPROVED

D. FAILURE TO MAINTAIN ACCEPTABLE'

8

DAILY STABILIZATION NOTE:

CONTRACTOR SHALL ONLY DISTURB THAT AREA WHICH CAN BE COMPLETED AND STABILIZED BY THE END OF EACH WORKING DAY. STABILIZATION SHALL BE AS FOLLOWS: 1. FOR AREAS TO BE PAVED, THE APPLICATION OF BASE STONE.

2. FOR AREAS TO BE VEGETATIVELY STABILIZED;

11

2.a. PERMANENT SEED AND SOIL STABILIZATION MATTING OR SOD FOR STEEP SLOPES, CHANNELS OR SWALES.

2.b. PERMANENT SEED AND MULCH FOR ALL OTHER AREAS.

ANY AREAS WHICH CAN NOT BE STABILIZED BY THE END OF EACH WORKING DAY MUST HAVE SILT FENCE INSTALLED ON THE DOWNSLOPE SIDE.

MAINTENANCE NOTE:

10

CONTRACTOR SHALL INSPECT AND MAINTAIN ALL SEDIMENT CONTROL MEASURES AND DEVICES AFTER EVERY STORM EVENT. MAINTENANCE SHALL INCLUDE, BUT NOT LIMITED TO THE REMOVAL OF ALL ACCUMULATED SEDIMENT. GEOTEXTILE FABRIC SHALL BE REPLACED AS NEEDED TO ENSURE PROPER FUNCTION.

## SEDIMENT CONTROL NOTE:

SEDIMENT CONTROLS ARE OFFSET FROM THE LIMIT OF DISTURBANCE (LOD) FOR VISUAL CLARITY. ALL SEDIMENT CONTROLS WILL BE CONSTRUCTED AT THE LOD.

13

14

15

12

OWNER / DEVELOPER/ APPLICANT: MARYLAND ZOO IN BALTIMORE 1876 MANSION HOUSE DRIVE BALTIMORE MD 21217 CONTACT: MR. KARL KRANZ PHONE: 443-552-3350

SITE

9.

12.

15.

PROVIDE ALL PROPER PERMITS PRIOR TO THE START OF CONSTRUCTION.

THE CONTRACTOR MUST SUBMIT A WRITTEN NOTIFICATION SWM/ESC INSPECTION SECTION AT LEAST 72 HOURS PRIOR TO THE START OF CONSTRUCTION TO THE DEPARTMENT OF PUBLIC WORKS, OFFICE OF RESEARCH AND ENVIRONMENTAL PROTECTION: 3001 DRUID PARK DRIVE, ROOM 228, BALTIMORE, MD 21215; PHONE: 410-396-0732: EMAIL DPW.ESCINSPECTIONS@BALTIMORECITY.GOV. THE NOTIFICATION MUST INCLUDE:

- A. REQUEST FOR A PRE-CONSTRUCTION MEETING
- B. WHEN CONTRACTOR INTENDS TO BEGIN CONSTRUCTION, C. WHEN CONTRACTOR INTENDS TO INSTALL STORMWATER MANAGEMENT FACILITIES.
- D. SOURCE OF BORROW MATERIAL
- E. LOCATION OF DISPOSAL AREA WITH AN ACTIVE PERMIT,
- F. CONTRACTOR'S TENTATIVE CLOSING DATE.

CONDUCT ON-SITE PRE-CONSTRUCTION MEETING WITH ALL PARTIES, INCLUDING BUT NOT LIMITED TO THE BALTIMORE CITY SEDIMENT CONTROL INSPECTOR, OWNER'S REPRESENTATIVES. CONTRACTOR'S REPRESENTATIVES AND ARCHITECT TO DISCUSS ISSUES INCLUDING, BUT NOT LIMITED TO WAYS AND MEANS AND LIMITS OF RESPONSIBILITIES AND WORK, AND TO INSPECT THE SITE FOR ANY UNFORESEEN CONDITIONS

UPON WRITTEN APPROVAL OF THE BALTIMORE CITY ESC INSPECTOR, CLEAR AND GRUB THE AREA FOR THE INSTALLATION OF PERIMETER SEDIMENT CONTROL DEVICES ONLY. UPON WRITTEN APPROVAL OF THE BALTIMORE CITY ESC INSPECTOR, INSTALL REMAINING SEDIMENT CONTROL DEVICES SEDIMENT CONTROL DEVICES AND BEGIN CONSTRUCTION. CONTRACTOR SHALL INSTALL DEWATERING CONTROLS DURING ALL TRENCHING AND EXCAVATION AT THE DISCRETION OF THE EROSION AND SEDIMENT CONTROL INSPECTOR. PERFORM SITE DEMOLITION AND SITE GRADING TO FACILITATE THE INSTALLATION OF THE PROPOSED SITE FEATURES, THE CONTRACTOR SHALL REMOVE FROM ANY MATERIAL FROM THE SITE THAT EXCEEDS THE ALLOWABLE STOCKPILE AREA LIMIT BY THE END OF

EACH WORKDAY BEGIN CONSTRUCTION OF THE PROPOSED BUILDING AND ANIMAL EXHIBITS. PERFORM SITE GRADING, AND STABILIZE ALL AREAS DISTURBED BY THIS PROCESS. BEGIN UTILITY CONSTRUCTION INCLUDING, BUT NOT LIMITED TO, STORM DRAIN

STRUCTURES, STORM WATER MANAGEMENT FACILITIES, AND ALL STORM DRAIN, SANITARY SEWER, AND WATER PIPING. DO NOT INSTALL STORM WATER FILTRATION MEDIA IN THE MODULAR WETLAND AT THIS TIME. SEE APPROVED STORM WATER MANAGEMENT SHEETS FOR THE STORM WATER SEQUENCE OF CONSTRUCTION. STABILIZE ALL AREAS DISTURBED BY THIS PROCESS

BEGIN CONSTRUCTION OF HARDSCAPED AREAS INCLUDING, BUT NOT LIMITED TO, ASPHALT PAVING, CONCRETE PAVING, FENCE INSTALLATION, AND ITEMS ASSOCIATED WITH THE ANIMAL EXHIBITS. PERMANENTLY STABILIZE ALL AREAS DISTURBED BY THIS PROCESS.

AFTER ALL STORM DRAIN AND STORM WATER MANAGEMENT DEVICES HAVE BEEN INSTALLED AND HAVE BEEN PROPERLY CONNECTED, FLUSH THE STORM DRAIN NETWORK. INSTALL THE FILTRATION MEDIA IN THE MODULAR WETLAND. AND ACTIVATE THE STORM DRAIN SYSTEM. CONTRACTOR MUST CAPTURE ALL SEDIMENT FROM THE STORM DRAIN NETWORK FLUSH

13. <u>NOTIFY</u> AS-BUILT ENGINEER, PROFESSIONAL ENGINEER WHO WILL BE PERFORMING THE AS-BUILT CERTIFICATION, AND GEOTECHNICAL ENGINEER OF THE SWM FACILITY AT LEAST FIVE (5) WORKING DAYS PRIOR TO BEGINNING THE WORK. 14. PERFORM FINE GRADING AND PERMANENTLY STABILIZE THE AREAS DISTURBED BY THIS

PROCESS. ONCE THE SITE HAS BEEN PERMANENTLY STABILIZED AND WITH WRITTEN PERMISSION FROM THE BALTIMORE CITY SEDIMENT CONTROL INSPECTOR, REMOVE ESC MEASURES AND IMMEDIATELY STABILIZE ANY DISTURBANCE FROM REMOVAL 16. AS REQUIRED, WITH INSPECTOR'S WRITTEN APPROVAL, CONTRACTOR TO FILE NOTICE OF TERMINATION (NOT) TO MDE AND CLOSE ANY APPLICABLE PERMITS.



BKP

DRAWING TITLE: EROSION AND SEDIMENT CONTROL COVER SHEET

DRAWING NO:




BCNR # 11545

19

20

18

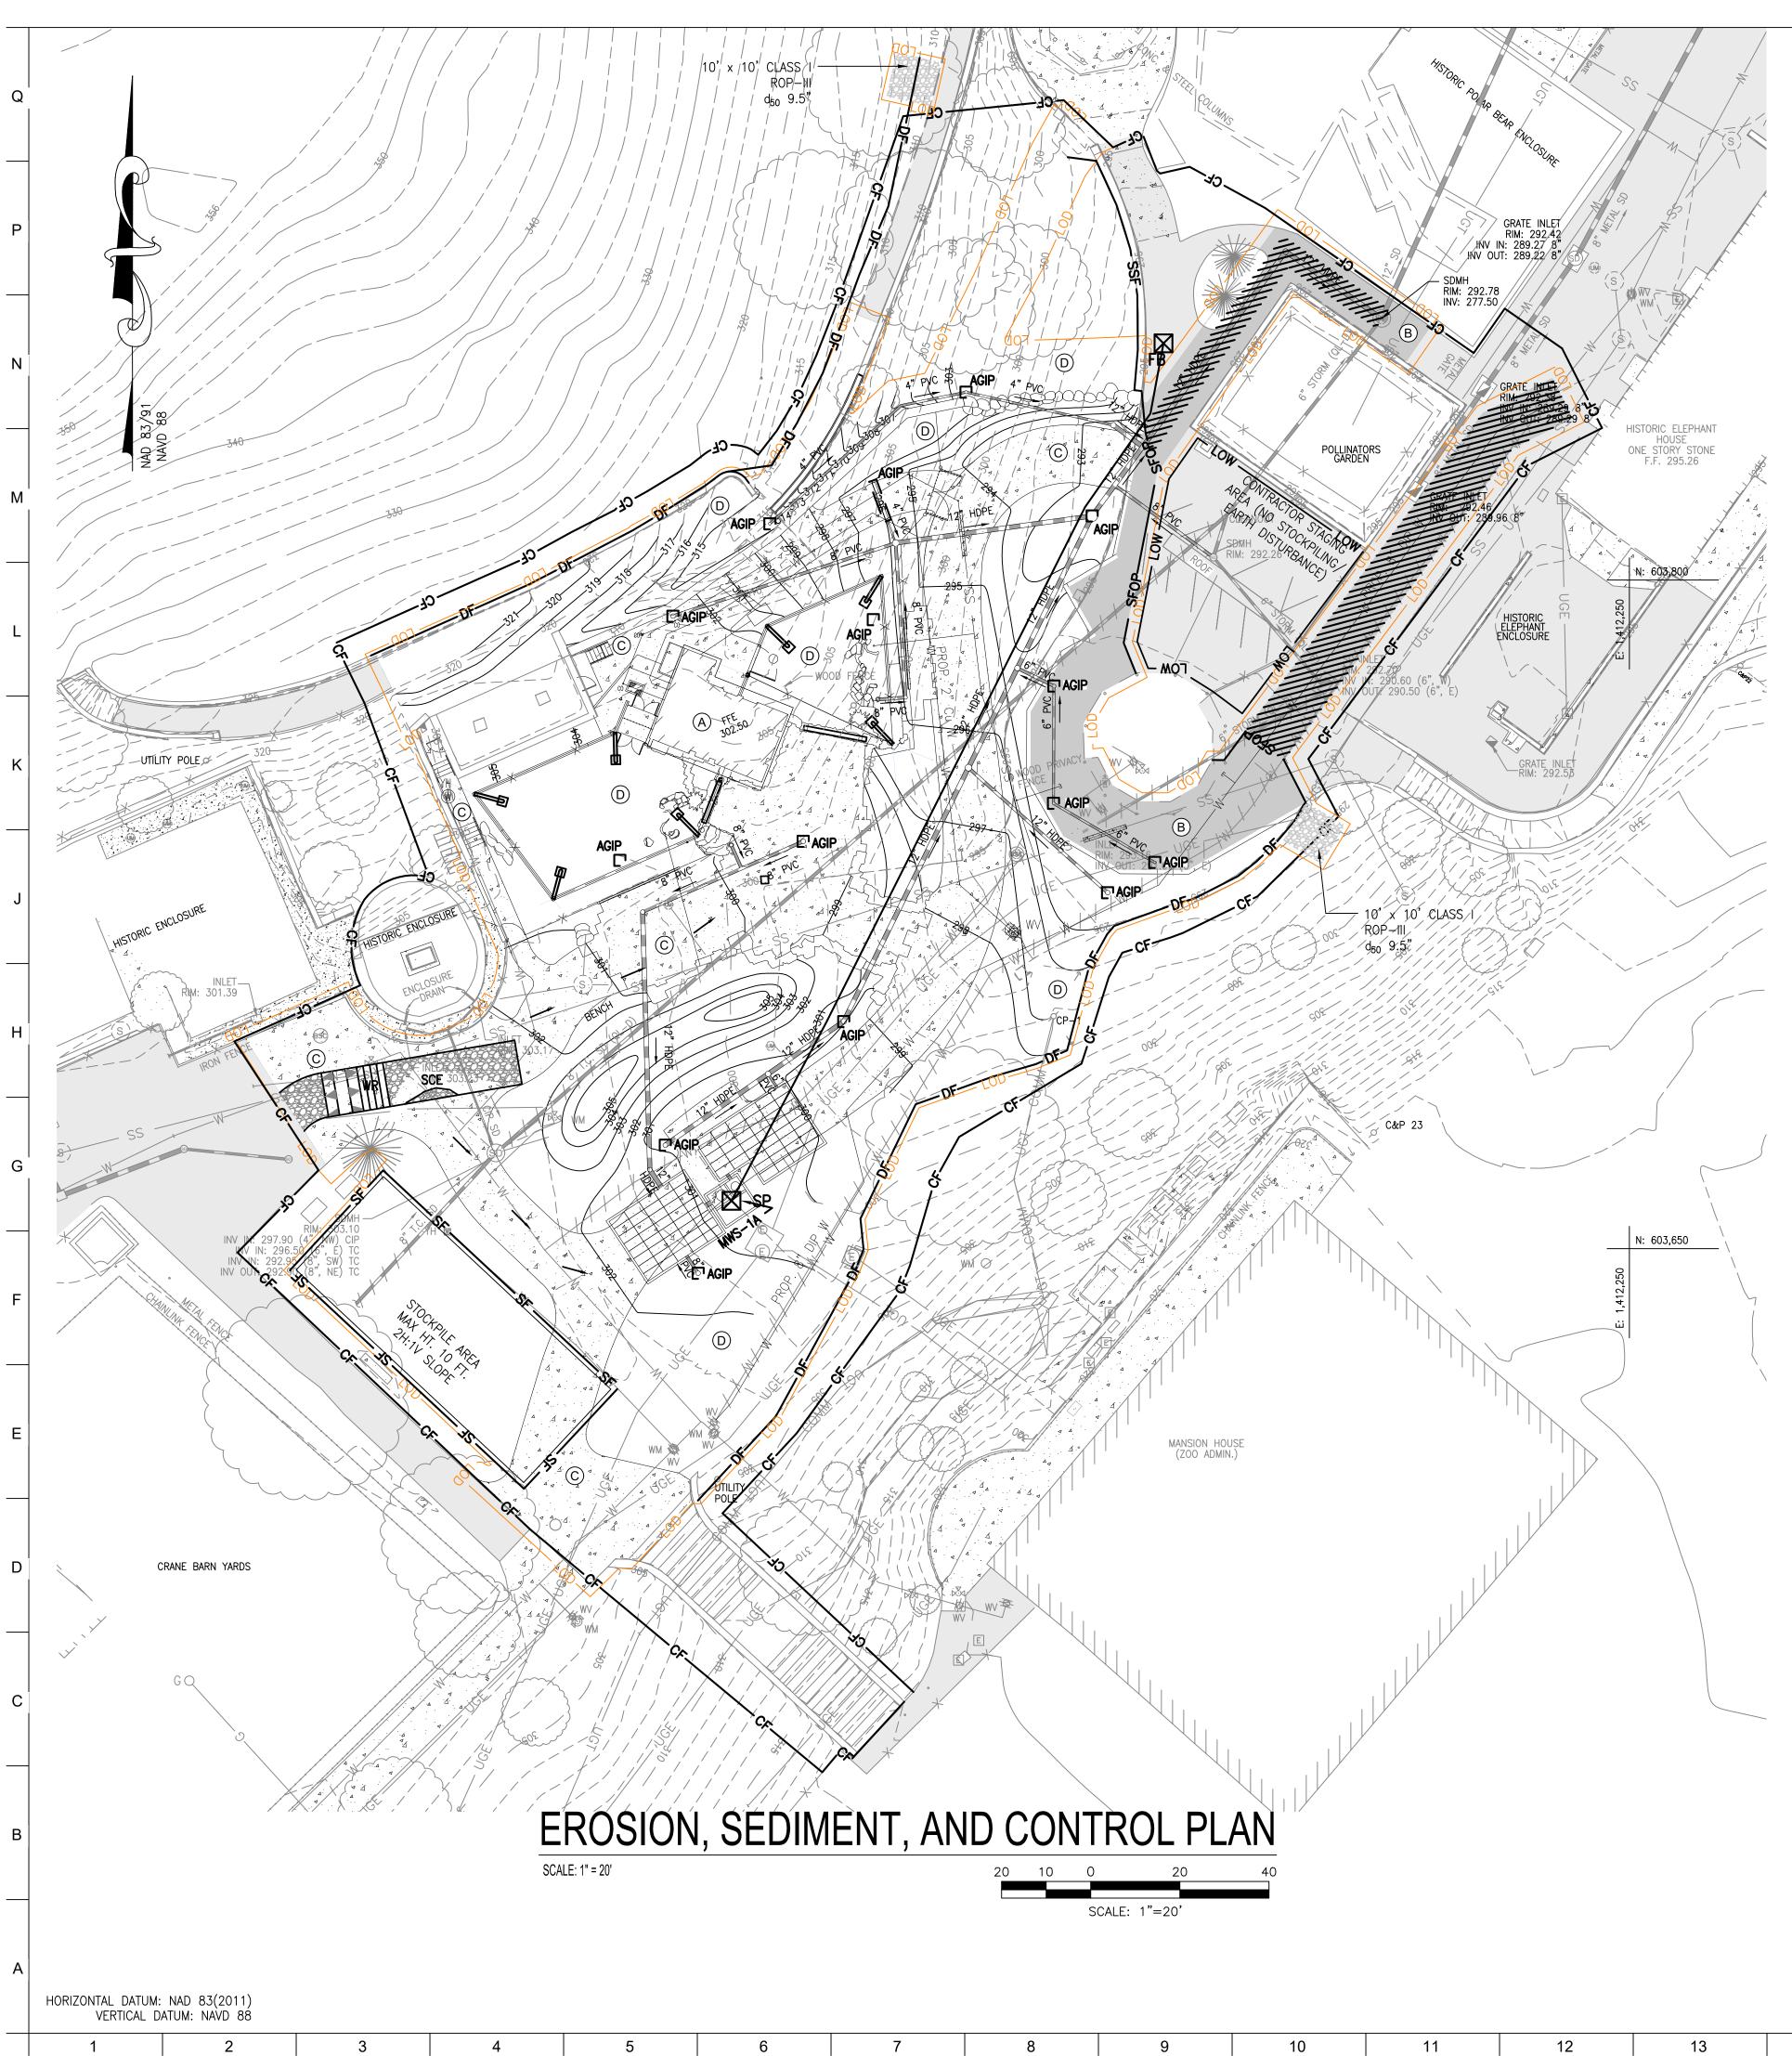

	<u>LEGEND</u>
100	PROPOSED BUIL PROPOSED MAJO PROPOSED MINO PROPOSED ASPI
	PROPOSED CUR
	PROPOSED CON PROPOSED FENC LIMIT OF DISTUR PROPOSED UND PROPOSED SANI PROPOSED SANI PROPOSED STOP
0	PROPOSED STOP
W	PROPOSED WATE
СЭ WV Wu	PROPOSED SMAI
	PROPOSED SUPI
SFOP	SILT FENCE ON
SF	SILT FENCE
——— DF ———	DIVERSION FENC
CF	TEMPROARY CON
	AT GRADE INLET
	SAME DAY STAB
SPX FB	SUMP PIT / FIL
LOW	LIMIT OF WORK

# STABILIZED CONS

# <u>GENERAL NOTES</u>:

- FIELD RUN TOPOGRAPHIC SU
  EXISTING UNDERGROUND UTILITIES SHOWN FOR REFERENCE ONLY.
  OF SAID INFORMATION BEYOND TH "STANDARD GUIDELINE FOR THE O CONTRACTOR SHALL MAKE HIMSE THESE PLANS. PRIOR TO ANY VERIFY, TO HIS OWN SATISFACTION DETERMINE WHETHER THOSE UTI WITH EXTREME CAUTION. THE GI SUPPORT AND PROTECT ALL DES UTILITY BE DAMAGED BY THE CON SATISFACTION, AT THE CONTRACTO
- SATISFACTION, AT THE CONTRACTO
  LIVE UNDERGROUND UTILITIES MAY WITH APPLICABLE FEDERAL, STATE
  INFORMATION SHOWN ON THIS DR LOCATIONS OF PROPOSED CONSTR CONTRACTOR TO PROVIDE ALL CO

# <u>NOTE:</u>

- 1. LIMIT OF DISTURBANCE OFFSET
- 2. TOTAL LIMIT OF DISTURANCE: 33, \*\*PROJECT WILL REQUIRE MDE
- 3. ANY SILT FENCE OR SILT FENCE WORKING DAY. ANY SEDIMENT IN

	<u>ST</u>
AREA	SQ.FT.
A BUILDINGS	2,265
B ROADWAYS	3,365
C CURBS & SIDEWALKS	11,210
D PERVIOUS AREAS	16,695
E SEDIMENT CONTROLS	
AREAS ARE TO BE VEGETA THE BALTIMORE CITY STAN	

SITE AREA	743.98
LOD	0.77
CUT	1,625
FILL	525
	-

10	11	12	13	

15

16

17

18

19

						BK	(P)
							)
						PROJECT TEAN	
	NTOUR NTOUR					ARCHI BUELL KRATZER 1525 LOCUS PHILADELPH	R POWELL, P.C. ST STREET IIA, PA 19102
B						T: 215.5 CIVIL EN	
	WALK					CARROLL ENG	
	E FUND ELECTRIC			OWNER / DEVELOPER/ APPLICANT MARYLAND ZOO IN BALTIMORE 1876 MANSION HOUSE DRIVE		HUNT VALLE T: 410.7	EY, MD 21031 85.7423
RMDRA	CLEANOUT IN LINE IN MANHOLE			BALTIMORE MD 21217 CONTACT: MR. KARL KRANZ PHONE: 443–552–3350	2	LANDSCAPE ROBINSON ANDE 28 WEST ST/ MEDIA, F T: 302.8	RSON SUMMERS ATE STREET PA 19063
LL SEC ER VAL	CTIONAL VAULT .VE .T FENCE						SIGN STUDIO, INC AY HOLLADAY RD ITY, UT 84117
	CTION FENCE FECTION				ł	MEP EN KOVACS, WHITNE 190 WEST OSTE BALTIMORE T: 410.2	Y & ASSOCIATES ND ST, STE 300 E, MD 21230
BILIZATI	ON						
_ter e	PAG					CLIENT: MARYLA THE MARYLAND ZO	AND ZOO
ISTRUC	TION				-	1 SAFAR BALTIMORE	
ES DES THE D COLLE ELF F/ EXCAV ION, TI ILTIES GIVING SIGNAT ONTRA TOR'S IAY EX	SIGNATED ON THE OWNER AND ENGI ESIGNATION INDICA ECTION AND DEPIC AMILIAR WITH THOS ATION, IN THE AB HE EXISTENCE, DE ARE LIVE. ANY EA OF INFORMATION TED OR UNDESIGN CTOR, THE CONTR EXPENSE.	PLANS ARE BAS INEER DISCLAIM ATED. THE QUA CTION OF EXISTIN SE STANDARDS F SENCE OF QUAL EPTH, SIZE, MATE ARTHWORK IN LO ON THE PLANS ATED EXISTING U ACTOR SHALL RI	ANY RESPONSIBILITY LITY LEVEL DESIGNA IG SUBSURFACE UTI PRIOR TO ANY RELIA ITY LEVEL A OR B ERIAL, AND LOCATION CATIONS WHERE UT WILL NOT RELIEVE JTILITIES AND APPUF EPAIR THE DAMAGE	D24 . AVAILABLE INFORMATION AND ARE FOR THE ACCURACY OR COMPLETENESS FED IS IN ACCORDANCE WITH ASCE LITY DATA" (CI/ASCE 38–02). THE NCE ON THE INFORMATION SHOWN ON DESIGNATION, THE CONTRACTOR SHALL I OF ALL UNDERGROUND UTILITIES, AND LITIES ARE POSSIBLE SHALL BE DONE THE CONTRACTOR OF HIS OBLIGATION TO RTENANCES. SHOULD ANY EXISTING CAUSED TO THE UTILITY OWNER'S		D PAND	IN BALIIMURE 1 SAFARI PLACE BALTIMORE, MD 2121
STRUCT CONSTE	ION WITH RESPEC RUCTION SURVEY	T TO EXISTING S STAKEOUT REQU CLARITY. ESC CO	SITE IMPROVEMENTS. RED AND TO CONFI	CONTRACTOR IN ESTABLISHING THE IT IS THE RESPONSIBILITY OF THE RM ALL INFORMATION SHOWN HEREON. CED ON THE LIMITS OF DISTURBANCE.		THIS DRAWING IS TO ILLUSTRATE ARCHITECT IS NOT RESPON METHODS, TECHNIQUES, SEQL USED TO DO THE WORK OR CONSTRUCTION, AND NOTHING OR IMPLIED CHANGES THIS COND RESPONSIBLE FOR KNOWING HO SUBMITTAL OF A BID TO PER ACKNOWLEDGEMENT OF THESE RE HAVE BEEN FULLY CONSIDERED AND THE BID PRICE. NO CLAIMS THESE CONDITIONS WIL	NSIBLE FOR THE MEANS, JENCES, AND PROCEDURES THE SAFETY ASPECTS OF ON THIS DRAWING EXPRESSED JITION. CONTRACTOR SHALL BE DW THEY AFFECT THE WORK. FRORM THIS WORK IS AN ESPONSIBILITIES, AND THAT THEY IN PLANNING OF THE WORK, FOR EXTRA CHARGES DUE TO
)e apf	PROVÁL.					SEAL:	
				EINSTALLED AT THE END OF EACH IMMEDIATELY CLEANED AND SWEPT.		PR	MARL PL
<u>STABI</u>	LIZATION SCHEDU	LE				ALL SSIO	14440 STERED
Г.	TYPE OF STAE		sequence 6			PROFESSIONAL CERTIFIC THAT THESE DOCUMENTS APPROVED BY ME, AND TH	
-		·	7 — —				R UNDER THE LAWS OF THE
-		·	9			DATE: JANUARY 1	4, 2025
	CONC./BITUMINOUS P		7,8			PROJECT NO: 202 DRAWN BY	3-10.04 MJE
0	CONCRETE CURBS/W	ALKS (permanent)	9			CHECKED BY	CMS
5	TEMPORARY SEED	·	<u>7,8</u>			SUBMISSION BID SET	DATE 01/14/2025
	SEEDING/STONE	E (temporary)	<u>4,5</u>				
	TO SATISFY THE 3/7 DA ID SEDIMENT CONTRO		PER			REVISION	DATE
				1		drawing titl EROSIC	e: DN AND
	SITE DATA		SF			SEDI <i>I</i> CONTRO	
	AC	33,535	SF				
	СҮ						
	CY						
				BCNR # 11545		C7	UI