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OWNER / DEVELOPER / APPLICANT: MARYLAND ZOO IN BALTIMORE 1876 MANSION HOUSE DRIVE BALTIMORE MD 21217 CONTACT: MR. KARL KRANZ PHONE: 443-552-3350 <u>LEGEND</u> PROPOSED BUILDING ------ 100 ------ PROPOSED MAJOR CONTOUR PROPOSED ASPHALT PROPOSED CURB PROPOSED CONCRETE WALK ----- LOD ----- LIMIT OF DISTURBANCE UGE PROPOSED UNDERGROUND ELECTRIC PROPOSED SANITARY CLEANOUT PROPOSED STORMDRAIN LINE PROPOSED STORMDRAIN MANHOLE PROPOSED SMALL SECTIONAL VAULT O)

PROPOSED WATER VALVE

PROPOSED NOTES:

CONTRACTOR SHALL VERIFY FIELD CONDITIONS PRIOR TO AND DURING CONSTRUCTION/DEMOLITION AND NOTIFY THE OWNER IMMEDIATELY OF ANY DISCREPANCIES BETWEEN ACTUAL FIELD CONDITIONS AND THE APPROVED PLANS.

WVW

- CONTRACTOR SHALL MAINTAIN PEDESTRIAN & VEHICULAR ACCESS TO AND AROUND OVERALL SITE DURING CONSTRUCTION ACTIVITIES. CONTRACTOR SHALL FURNISH VEHICULAR AND PEDESTRIAN TRAFFIC PROTECTION IN ACCORDANCE WITH MUTCD LATEST VERSION AND THE CITY OF BALTIMORE REQUIREMENTS. 3. CONTRACTOR SHALL CONTACT THE OWNER AND DEVELOPER 72 HOURS PRIOR TO COMMENCING
- ANY WORK. 4. ALL UTILITY FRAMES AND COVERS TO REMAIN WITHIN THE PROJECT AREA SHALL BE ADJUSTED BY
- THE CONTRACTOR TO MEET NEW PAVEMENT OR GROUND ELEVATION. THE CONTRACTOR SHALL MAKE, CHECK, AND BE RESPONSIBLE FOR ALL MEASUREMENTS AND DIMENSIONS NECESSARY FOR THE PROPER CONSTRUCTION OF AND THE PREVENTION OF MISFITTINGS IN THE WORK. VERIFY LOCATIONS AND ELEVATIONS OF EXISTING UTILITIES BEFORE STARTING CONSTRUCTION IN EACH AREA.
- 5. CONTRACTOR TO COORDINATE WITH MISS UTILITY, THE CITY OF BALTIMORE, AND A PRIVATE UTILITY LOCATOR COMPANY PRIOR TO COMMENCING ANY WORK. THE CONTRACTOR MUST NOTIFY ALL PUBLIC UTILITY COMPANIES WITH UNDERGROUND FACILITIES IN THE AREA OF PROPOSED EXCAVATION AND HAVE THOSE FACILITIES LOCATED BY THE UTILITY COMPANIES PRIOR TO COMMENCING EXCAVATION.
- 6. LIVE UNDERGROUND UTILITIES EXIST WITHIN THE WORK AREA. CONTRACTOR SHALL USE EXTREME
- CAUTION AND SHALL COMPLY WITH APPLICABLE FEDERAL, STATE AND LOCAL REGULATIONS. CONTRACTOR SHALL TAKE NECESSARY PRECAUTIONS TO PROTECT EXISTING UTILITY STRUCTURES TO REMAIN DURING DEMOLITION AND CONSTRUCTION ACTIVITIES AND TO PREVENT DEBRIS, SEDIMENT, OR WATER FROM ENTERING THE STRUCTURES.
- 8. CONTRACTOR SHALL PROTECT ALL FACILITIES AND UTILITIES TO REMAIN FROM DAMAGE WHETHER SHOWN HEREON OR NOT. 9. ALL EXISTING PAINT MARKINGS ADJACENT TO THE PROJECT AREA WHICH BECOME FADED OR
- OBSCURED DUE TO CONSTRUCTION ACTIVITY SHALL BE REPAINTED OR RESTORED AT NO ADDITIONAL COST TO THE OWNER.
- 10. CONTRACTOR SHALL COORDINATE WITH OWNER AND UTILITY PROVIDER TO MINIMIZE DURATION OF UTILITY OUTAGES. 11. CONTRACTOR IS RESPONSIBLE FOR THE COORDINATION AND PLACEMENT OF ALL UTILITY CONDUITS
- AND ENCASEMENT. CONTRACTOR SHALL PROVIDE CONDUITS AND PULL STRINGS IN ACCORDANCE WITH UTILITY PROVIDER REQUIREMENTS FOR THEIR RESPECTIVE CONDUITS. 12. USE EXTREME CAUTION WHEN WORKING AROUND EXISTING TREES TO REMAIN SO AS NOT TO
- DAMAGE THE TREES OR ROOT SYSTEMS. 13. CONTRACTOR SHALL PROTECT ALL AREAS BEYOND THE LIMITS OF DISTURBANCE AND SHALL RESTORE ANY AND ALL AREAS DISTURBED DURING CONSTRUCTION TO THEIR ORIGINAL OR BETTER CONDITION.
- 14. INFORMATION SHOWN ON THIS DRAWING HAS BEEN PROVIDED AS A GUIDE TO ASSIST THE CONTRACTOR IN ESTABLISHING THE LOCATIONS OF PROPOSED CONSTRUCTION WITH RESPECT TO EXISTING SITE IMPROVEMENTS. IT IS THE RESPONSIBILITY OF THE CONTRACTOR TO PROVIDE ALL CONSTRUCTION SURVEY STAKEOUT REQUIRED AND TO CONFIRM ALL INFORMATION SHOWN HEREON. 15. CONTRACTOR SHALL FURNISH SHORING, SHEATHING, OR OTHERWISE SUPPORT EXCAVATIONS TO PROTECT EXCAVATIONS FROM CAVE-INS UNTIL BACKFILL PLACEMENT IS COMPLETE PER
- SPECIFICATIONS. 16. SEE EXISTING CONDITIONS PLAN FOR SITE BENCHMARKS. CONTRACTOR SHALL BE RESPONSIBLE FOR ESTABLISHING AND MAINTAINING TEMPORARY BENCHMARKS THROUGHOUT THE DURATION OF
- THE PROJECT FOR CONSTRUCTION LAYOUT PURPOSES. 17. REFER TO THE SITE LANDSCAPING PLANS FOR SITE FURNISHING AND PLANTING INFORMATION.

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18. SEE LANDSCAPE PLANS FOR PROPOSED SCORING AND PAVER PATTERNS. 19. REFER TO THE ELECTRICAL PLANS FOR ADDITIONAL ELECTRICAL UTILITY INFORMATION.

> ALL WORK SHALL CONFORM TO CITY OF BALTIMORE DEPARTMENT OF PUBLIC WORKS SPECIFICATIONS FOR MATERIALS, HIGHWAYS, BRIDGES, UTILITIES, AND INCIDENTAL STRUCTURES 2006, AND SUPPLEMENTARY SPECIFICATIONS IN THE CONTRACT DOCUMENTS.

SCALE: 1"=20' BCNR # 11545

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	DELPHIA, PA 1910 : 215.557.6509	2
CARROLI 215 SCHIL HUNT	<u>/IL ENGINEER:</u> L ENGINEERING, LING CIRCLE, STE VALLEY, MD 2103 : 410.785.7423	E 102
ROB <mark>INSON</mark> 28 WES ME	CAPE ARCHITEC ANDERSON SUM ST STATE STREE EDIA, PA 19063 : 302.888.1544	MER
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OVACS, W 190 WEST BALTI	EP ENGINEER: HITNEY & ASSOC OSTEND ST, STE IMORE, MD 21230 : 410.244.7191	
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RED PANDA	THE MARYLAND ZOO IN BALTIMORE 1 SAFARI PLACE BALTIMORE, MD 21217	
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PRO	NO 14446	
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THAT THES APPROVED PROFESSIO	ONAL CERTIFICATION. I HEREBY CERTIFY SE DOCUMENTS WERE PREPARED OR D BY ME, AND THAT I AM A DULY LICENSED	
	ONAL ENGINEER UNDER THE LAWS OF THE MARYLAND, LICENSE NO. 14446 , N DATE 5/25/25 .	
EXPIRATIO	MARYLAND, LICENSE NO. 14446 , N DATE 5/25/25 .	
expiration	MARYLAND, LICENSE NO. 14446 ,	

BKP

ARCHITECT: BUELL KRATZER POWELL, P.C.

1525 LOCUST STREET

PROJECT TEAM:

DATE: JANUART 14, 2025				
PROJECT NO: 2023-10.04				
DRAWN BY	MJE			
CHECKED BY	CMS			
SUBMISSION	DATE			
BID SET	01/14/2025			
REVISION	DATE			

DRAWING TITLE:

storm I	DRAIN
KEY PI	LAN

DRAWING NO:



			STORM DR	AIN SCHEDULE	
	STRUCTURE	RIM	INVERT IN	INVERT OUT	STRUCTURE/GRATE TYPE
ຊ່	I-2	314.00		311.00 (6")	2808AG/0899CGD
	HB-3		303.00 (6")	303.00 (6")	6" PVC 45° BEND
	I-4	302.50	300.00 (6")	295.35 (6")	2808AG/0899CGD
	MH-5	293.19	288.55 (12")	288.45 (12")	1599CGC
	I-6	292.75	290.05 (6")	289.55 (12")	1599CGD
	I-7	292.25	289.39 (12"); 289.39 (12")	289.29 (12")	3099CGD
	EX-8	292.26	291.10 (EX. 6")	289.61 (8")	EXIST. MH.
	I-9	302.00		299.00 (8")	1299CGS
	TD-10	296.00-296.00	295.00 (UPSTREAM END)	294.80 (DOWNSTREAM END) (4")	8'-8" LONG X 8" WIDE w/ LOCKING GRATE
-	MH-11	295.80	293.41 (4"); 293.08 (8"); 293.08 (8")	292.98 (12")	1899CGC
	I-12	296.00		294.00 (8")	SEE LS PLAN
	MH-13	295.85	293.78 (8")	293.68 (8")	1099CGC
	MH-14	295.80	292.58 (12"); 292.58 (8")	292.48 (12")	1899CGC
	I-15	294.11	292.78 (8")		1299CGD
	I-16	293.10		290.60 (6")	0899CGP
_	I-17	293.10	290.34 (6")	290.24 (6")	0899CGP
	I-18	293.10	289.98 (6")	289.88 (8")	1099CGP
	I-19	300.10	294.90 (12")	294.80 (12")	1599CGS
1	MH-20	300.80	295.20 (6"); 296.63 (12")	295.10 (12")	1599CGC
1	I-21	300.75		297.00 (12")	1299CGS
	MH-22	301.25	295.70 (12")	295.60 (12")	1299CGS
	MH-23	300.75	296.60 (8"); 296.60 (8")	296.27 (12")	1299CGC
_	I-24	300.75		297.37 (8")	SEE LS PLAN
	I-25	299.25		297.00 (8")	1299CGP
	I-26	301.50		295.75 (8")	1299CGD
	MH-27	294.50	289.65 (12"); 289.80 (8")	289.55 (12")	1599CGC
	TEE-28		289.20 (12"); 289.36 (8")	289.20 (12")	12"x8" TEE
	TEE-29		284.28 (12")	284.28 (12")	12" HDPE TEE
	EX-30	293.20 (EX)	288.24 (12")		EXIST. MH.
	DP-1	300.10	295.25 (6")		STORMBRIXX STORAGE CHAMBERS



HORIZONTAL DATUM: NAD 83(2011) VERTICAL DATUM: NAVD 88

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NOTES:						
<u></u> .	/ERIFY SIZE, [DEPTH. AND	MATERIAL	OF ALL	EXISTING	PIPE
	CTIONS PRIOR	,				
2. SHOP	DRAWINGS FOF	R STRUCTUI	RES SHALI	L BE SUE	BMITTED PF	RIOR TO
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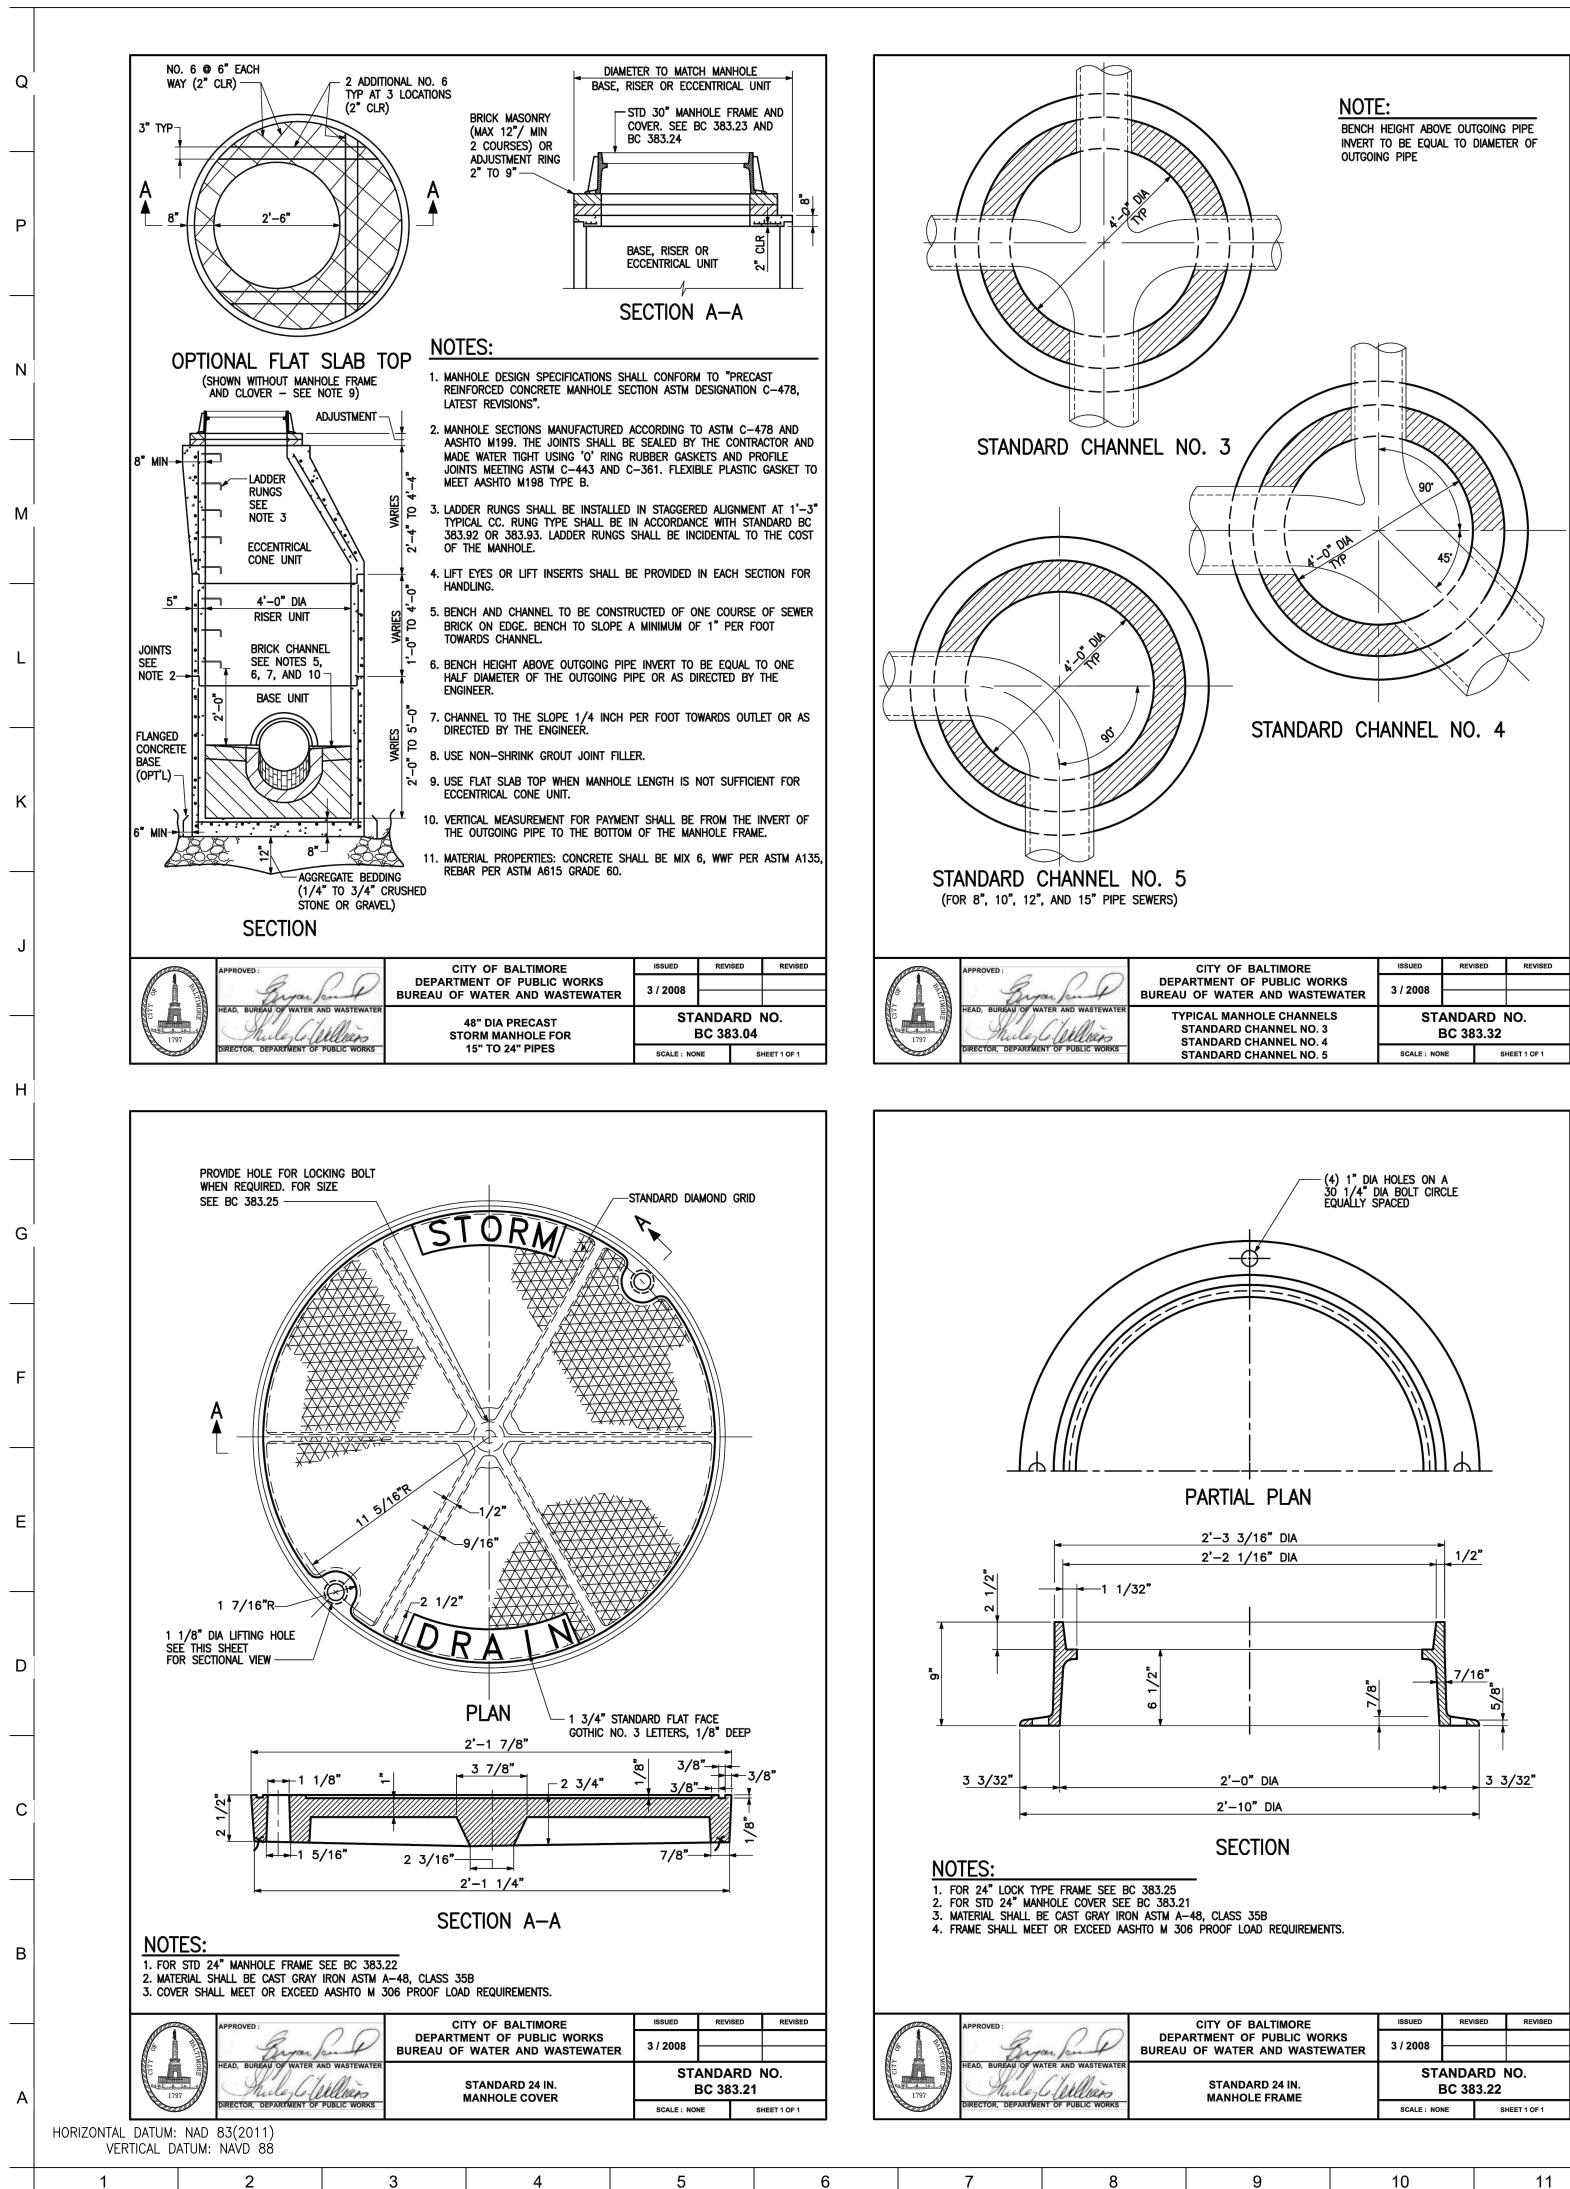
PIPE SCHEDULE					
FROM	TO	LENGTH (FEET)	SIZE (INCHES)	MATERIAL	
MH-05	EX-30	26	12	HDPE	
TEE-29	MH-05	54	12	HDPE	
TEE-28	TEE-29	11	12	HDPE	
I-07	TEE-28	9	12	HDPE	
MH-27	I-07	38	12	HDPE	
MH-14	MH-27	36	12	HDPE	
I-19	MH-14	52	12	HDPE	
MH-20	I-19	21	12	HDPE	
I-21	MH-20	28	12	HDPE	
I-06	TEE-29	8	12	HDPE	
ExMH-08	TEE-28	27	8	PVC	
MH-11	I-07	44	12	HDPE	
I-18	MH-27	9	8	PVC	
I-15	MH-14	40	12	HDPE	
DP-01	MH-20	4	6	PVC	
I-04	I-06	34	4	PVC	
TD-10	MH-11	6	4	PVC	
I-17	I-18	26	6	PVC	
HB-03	I-04	15	6	PVC	
I-16	I-17	26	6	PVC	
I-02	HB-03	40	6	PVC	
I-09	MH-11	53	8	PVC	
MH-13	MH-11	17	8	PVC	
I-12	MH-13	6	8	PVC	
I-26	PreStor	5	8	PVC	
MH-22	PreStor	5	12	HDPE	
MH-23	MH-22	58	12	HDPE	
I-24	MH-23	13	8	PVC	
I-25	MH-26	39	8	PVC	
MWS	DP-1	1	12	HDPE	
PreStor	MWS	2	8	PVC	

<u>NOTES</u>: 1. ALL HDPE PIPE SHALL BE N—12 DUAL WALL WITH WATER TIGHT JOINTS. 2. ALL PVC PIPE SHALL BE SCHDULE 40 WITH SOLVENT WELD JOINTS.

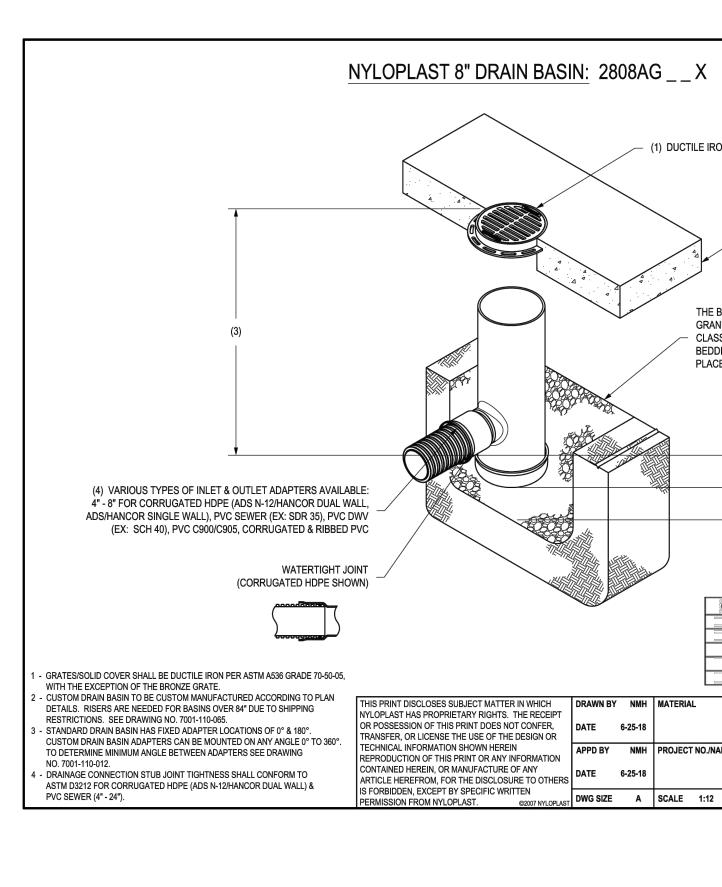
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	(ВКР)
	PROJECT TEAM:
	<u>ARCHITECT:</u> BUELL KRATZER POWELL, P.C. 1525 LOCUST STREET PHILADELPHIA, PA 19102 T: 215.557.6509
-	<u>CIVIL ENGINEER:</u> CARROLL ENGINEERING, INC 215 SCHILLING CIRCLE, STE 102 HUNT VALLEY, MD 21031 T: 410.785.7423
- - - -)	LANDSCAPE ARCHITECT: ROBINSON ANDERSON SUMMERS 28 WEST STATE STREET MEDIA, PA 19063 T: 302.888.1544
	STRUCTURAL ENGINEER: STRUCTURAL DESIGN STUDIO, INC 2225 EAST MURRAY HOLLADAY RD SALT LAKE CITY, UT 84117 T: 801.274.3950
	MEP ENGINEER: KOVACS, WHITNEY & ASSOCIATES 190 WEST OSTEND ST, STE 300 BALTIMORE, MD 21230 T: 410.244.7191
	CLIENT:
	MARYLAND ZOO THE MARYLAND ZOO IN BALTIMORE 1 SAFARI PLACE
	BALTIMORE, MD 21217
	RED PANDA THE MARYLAND ZOO IN BALTIMORE I SAFARI PLACE ALTIMORE, MD 21217
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	SEAL:
	P R ALL MOINTE OF MARL
	PROFESSIONAL CERTIFICATION. I HEREBY CERTIFY
	THAT THESE DOCUMENTS WERE PREPARED OR APPROVED BY ME, AND THAT I AM A DULY LICENSED PROFESSIONAL ENGINEER UNDER THE LAWS OF THE STATE OF MARYLAND, LICENSE NO. 14446, EXPIRATION DATE 5/25/25.
	DATE: JANUARY 14, 2025 PROJECT NO: 2023-10.04
	DRAWN BY MJE CHECKED BY CMS
	SUBMISSIONDATEBID SET01/14/2025
	REVISION DATE
	DRAWING TITLE:
	SCHEDULES
	DRAWING NO:
	C510

OWNER / DEVELOPER/ APPLICANT: MARYLAND ZOO IN BALTIMORE 1876 MANSION HOUSE DRIVE BALTIMORE MD 21217 CONTACT: MR. KARL KRANZ PHONE: 443–552–3350



-	CITY OF BALTIMORE	ISSUED	REVISED	REVISED
yan for P	DEPARTMENT OF PUBLIC WORKS BUREAU OF WATER AND WASTEWATER			
WATER AND WASTEWATER	STANDARD 24 IN. MANHOLE FRAME	STANDARD NO. BC 383.22		
TMENT OF PUBLIC WORKS		SCALE : NONE		HEET 1 OF 1



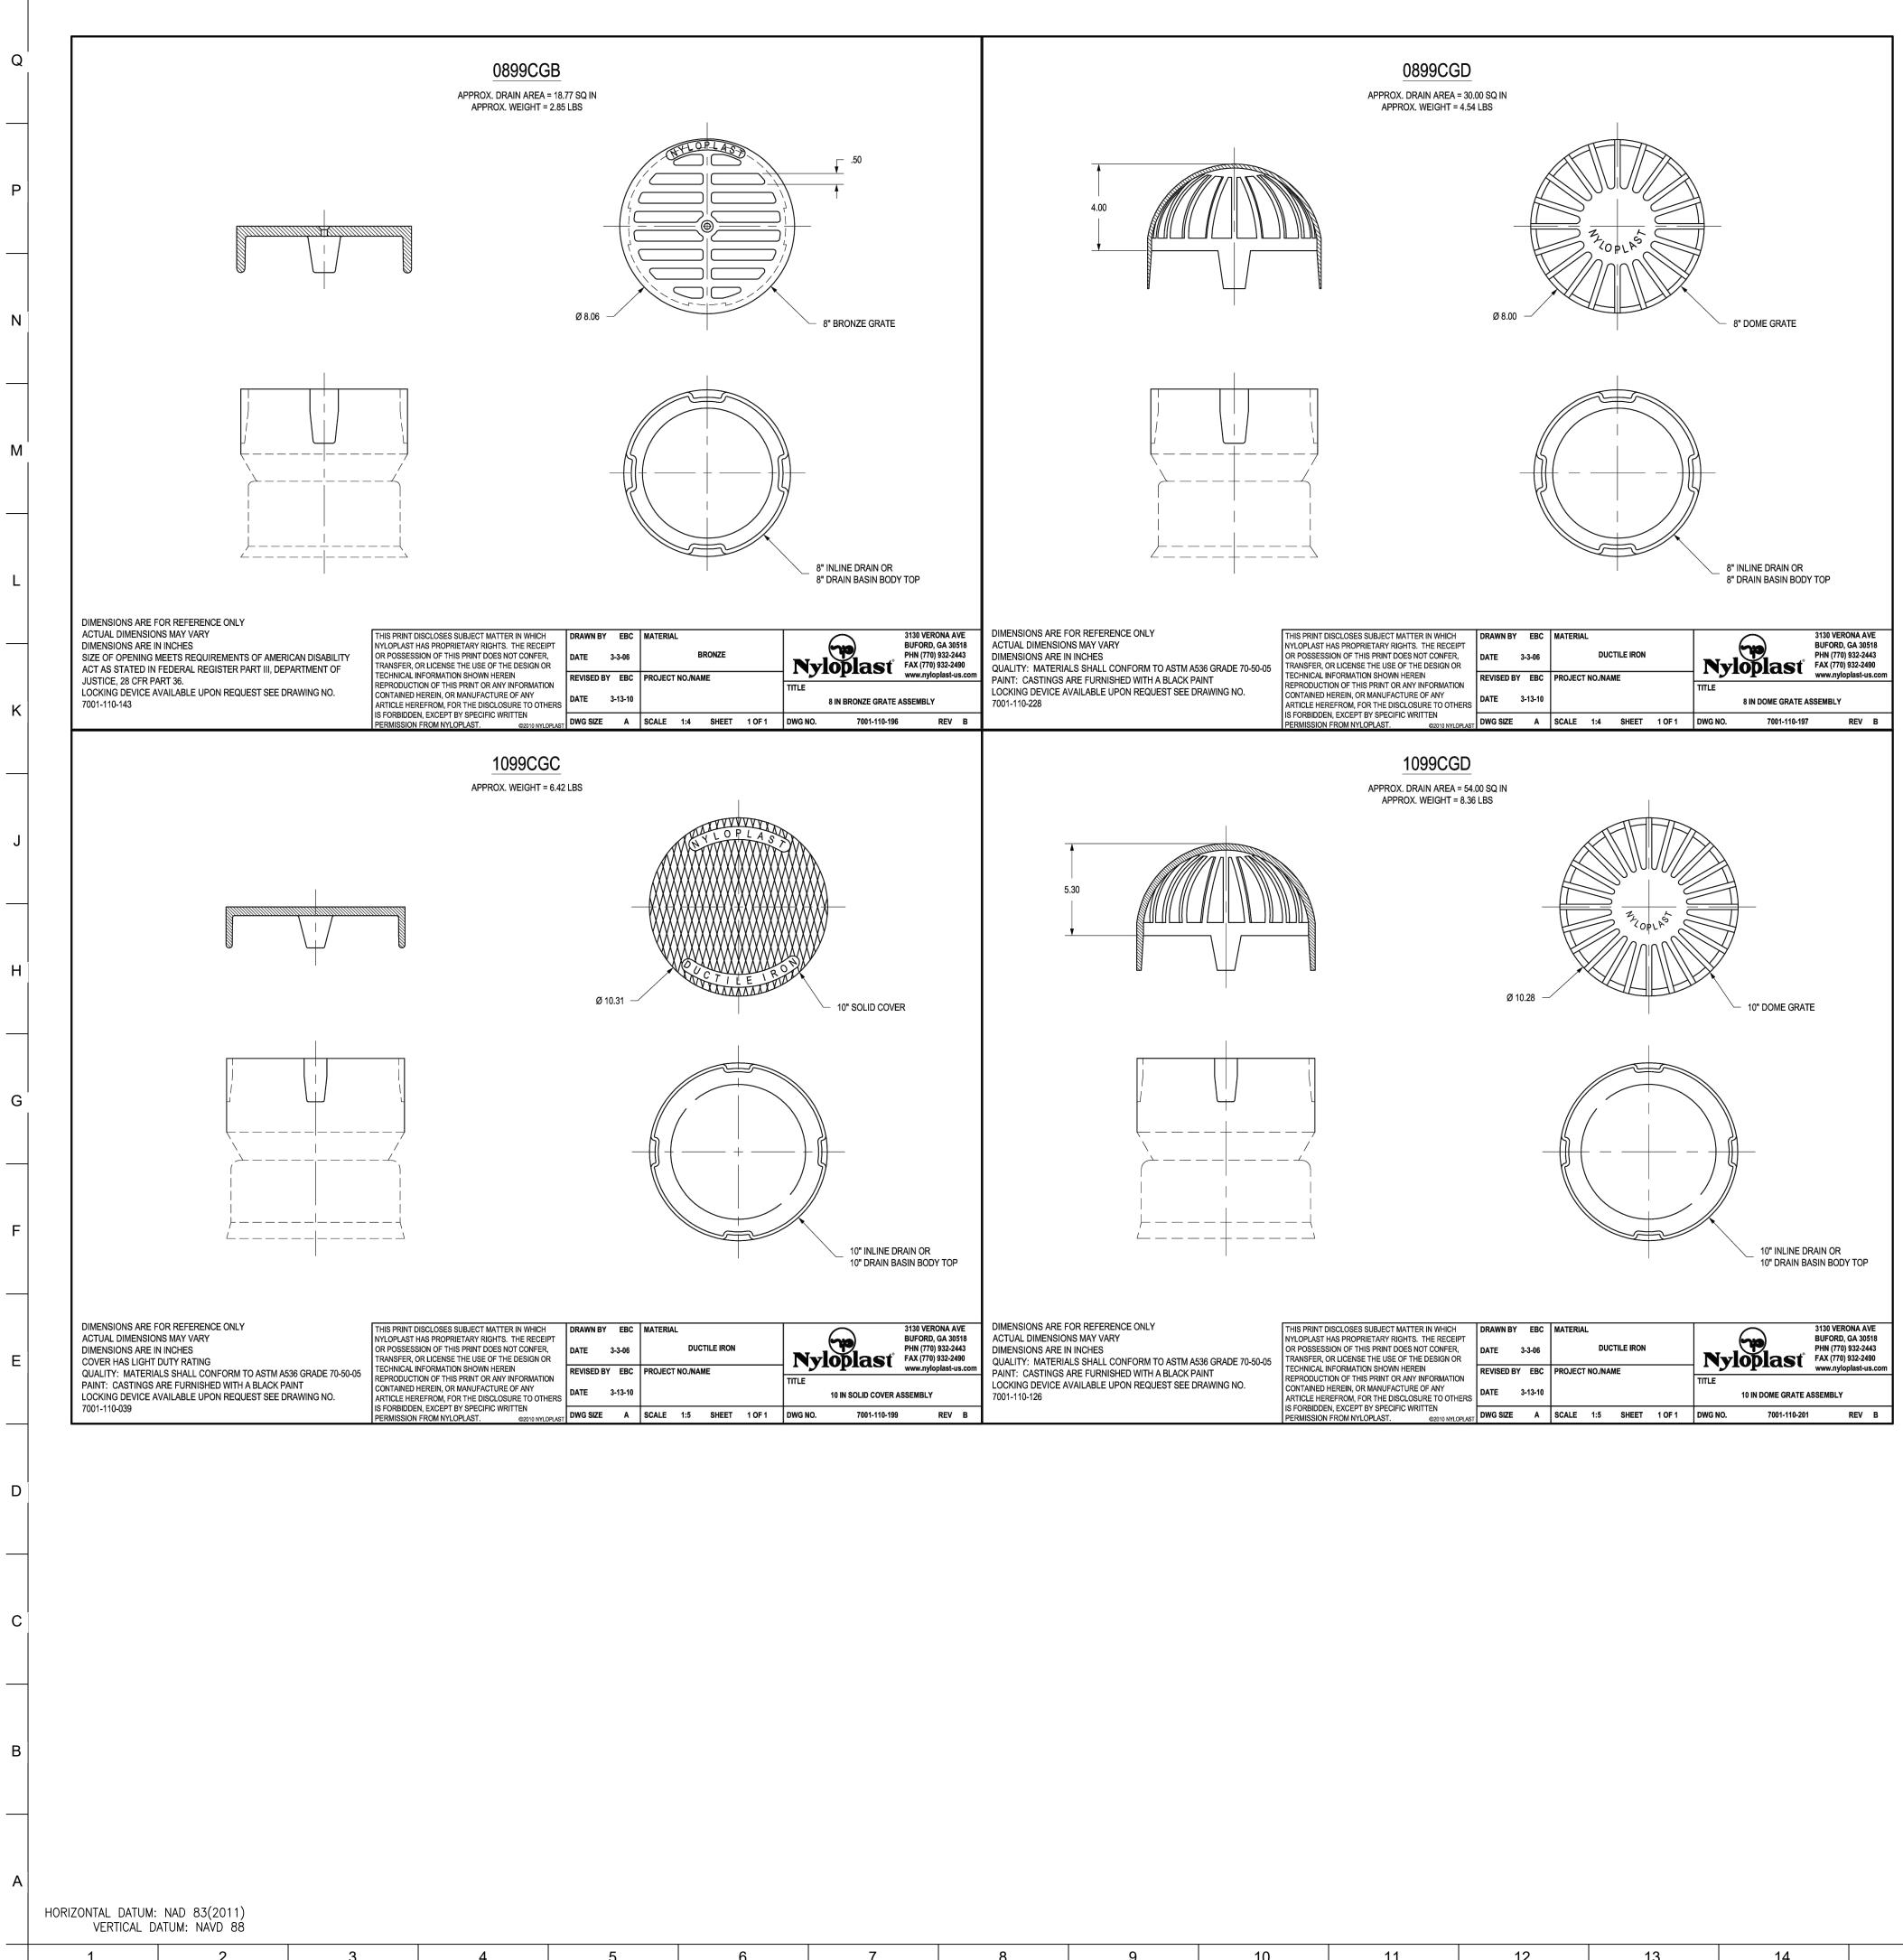
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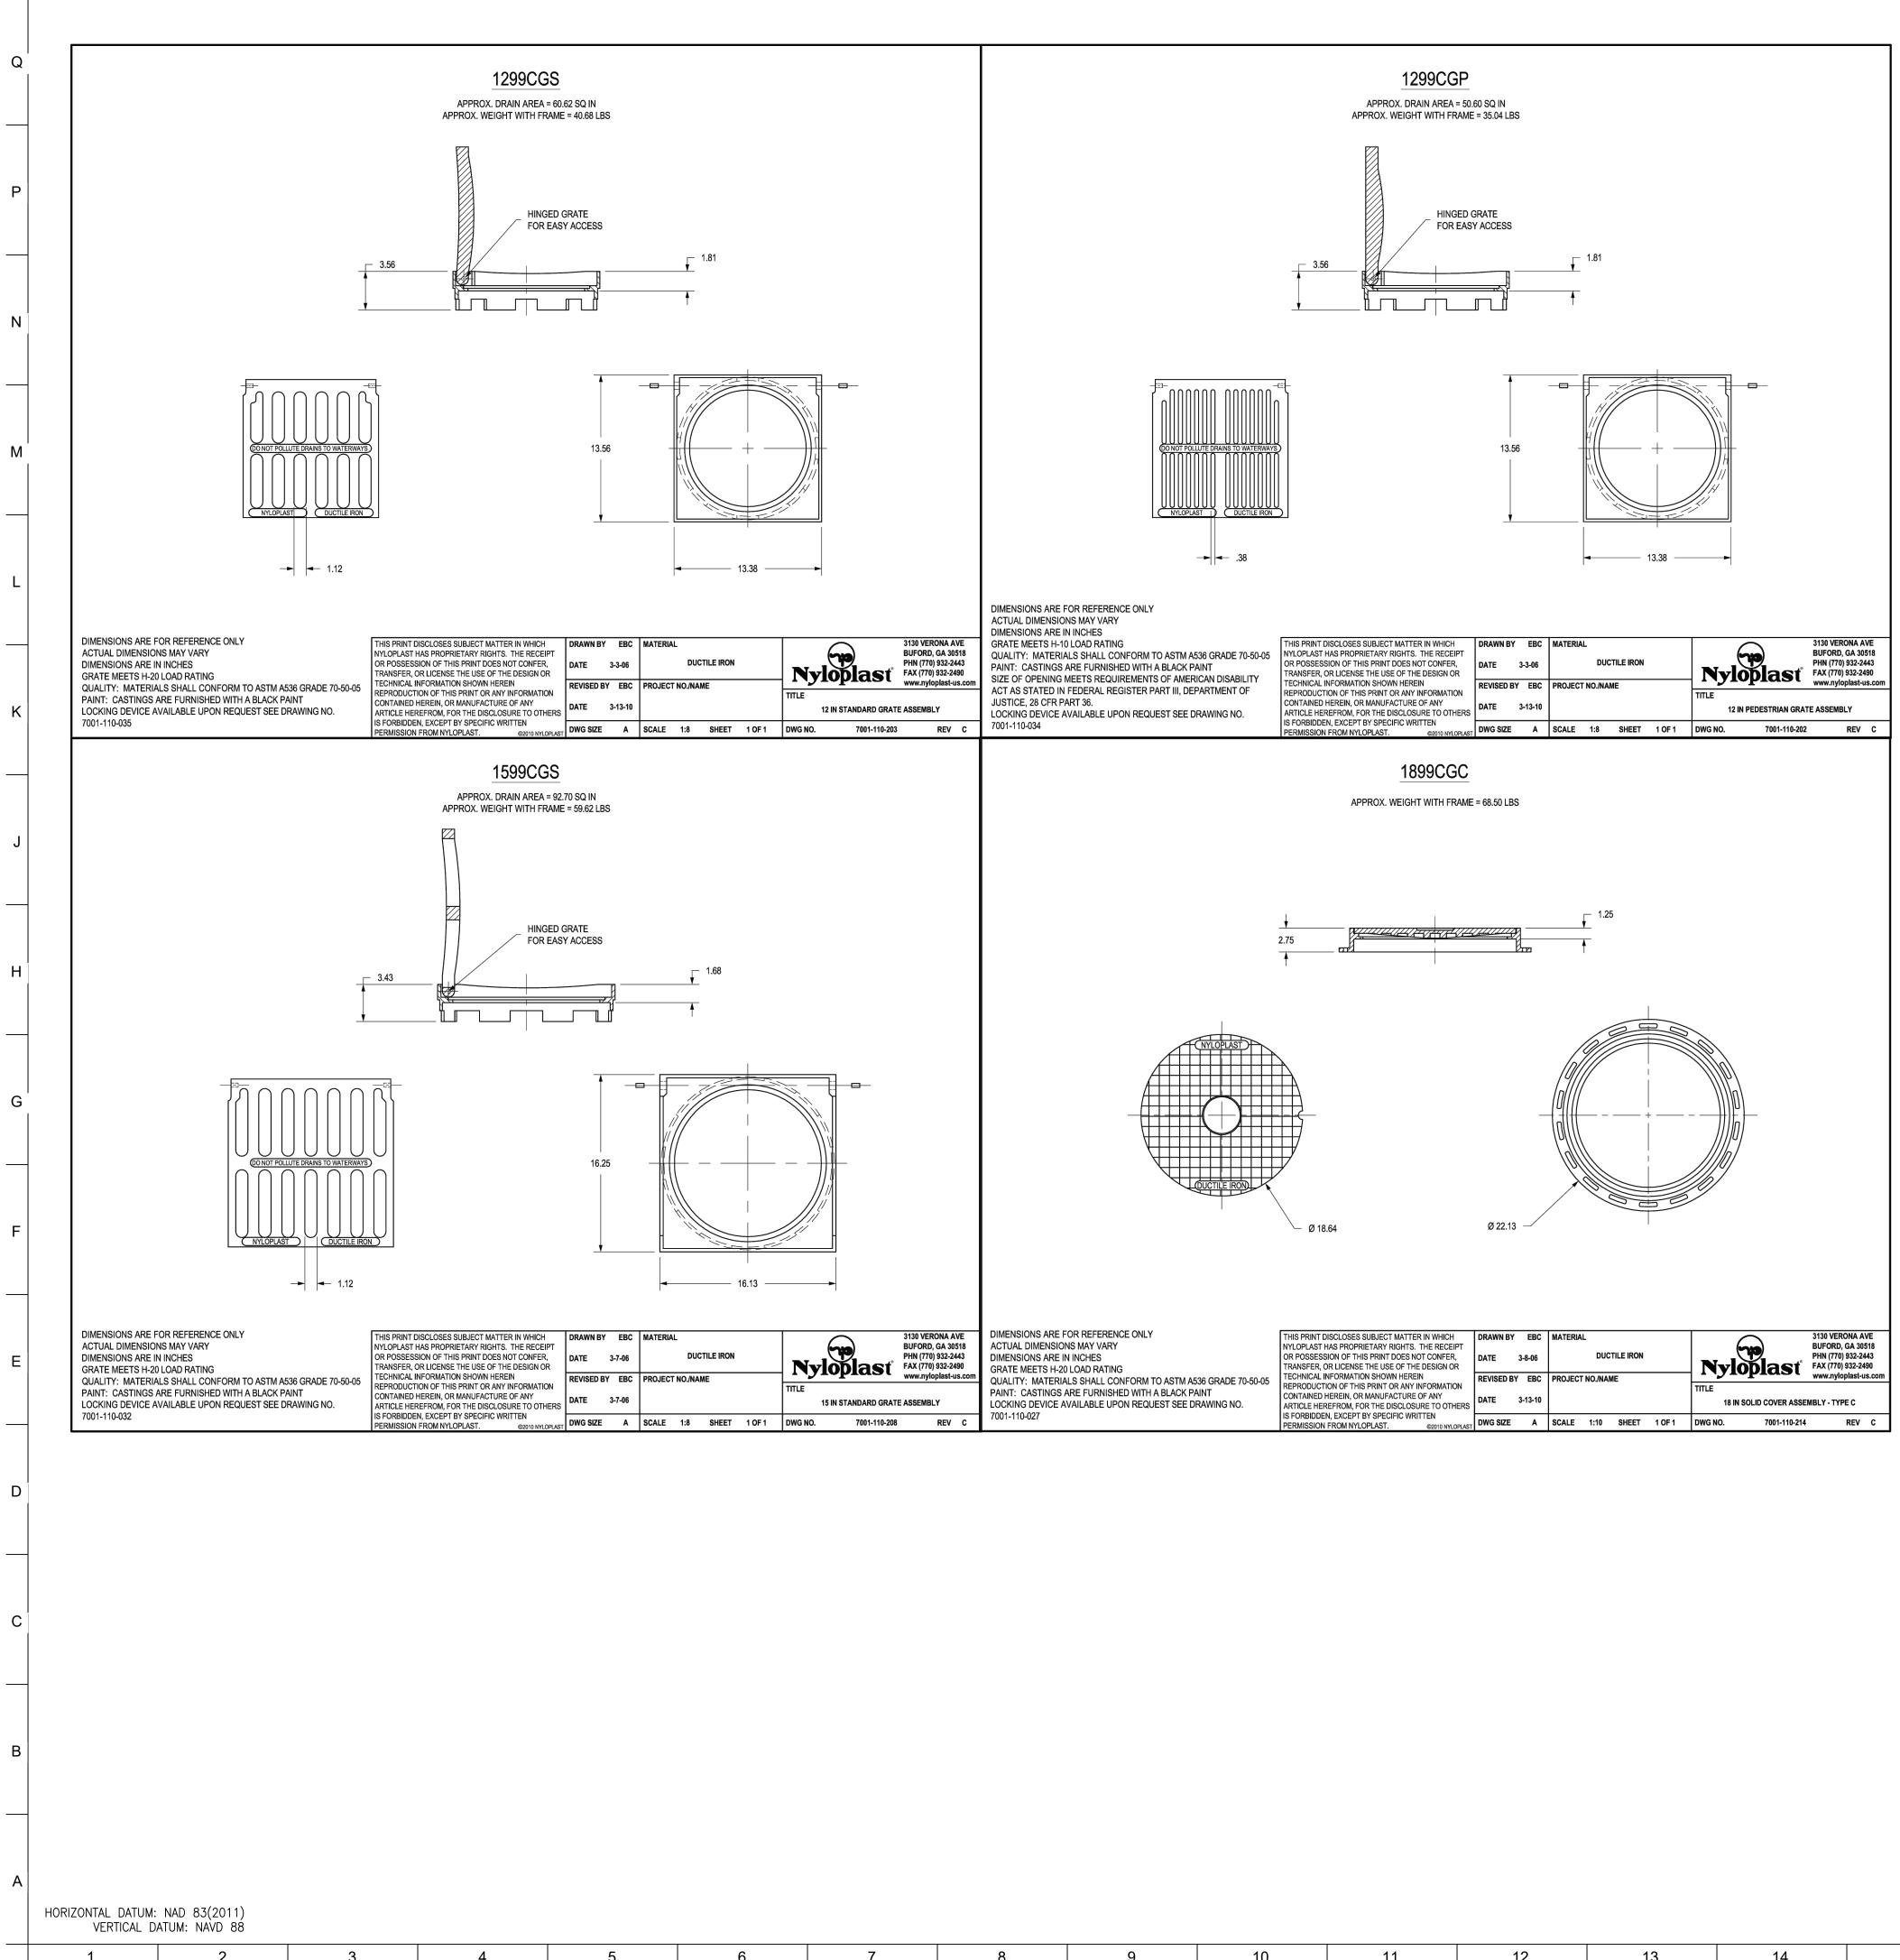
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		BKP
		PROJECT TEAM:
		<u>ARCHITECT:</u> BUELL KRATZER POWELL, P.C. 1525 LOCUST STREET PHILADELPHIA, PA 19102 T: 215.557.6509
<u>OW</u>	<u>NER / DEVELOPER/ APPLICANT</u> : MARYLAND ZOO IN BALTIMORE	<u>CIVIL ENGINEER:</u> CARROLL ENGINEERING, INC 215 SCHILLING CIRCLE, STE 102 HUNT VALLEY, MD 21031 T: 410.785.7423
	1876 MANSION HOUSE DRIVE BALTIMORE MD 21217 CONTACT: MR. KARL KRANZ PHONE: 443–552–3350	LANDSCAPE ARCHITECT: ROBINSON ANDERSON SUMMERS 28 WEST STATE STREET MEDIA, PA 19063 T: 302.888.1544
		<u>STRUCTURAL ENGINEER:</u> STRUCTURAL DESIGN STUDIO, INC 2225 EAST MURRAY HOLLADAY RD SALT LAKE CITY, UT 84117 T: 801.274.3950
		MEP ENGINEER: KOVACS, WHITNEY & ASSOCIATES 190 WEST OSTEND ST, STE 300 BALTIMORE, MD 21230 T: 410.244.7191
		CLIENT:
		THE MARYLAND ZOO IN BALTIMORE 1 SAFARI PLACE BALTIMORE, MD 21217
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		PAND ALTIMO ARI PLA RE, MD
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TILE IRON GRATE		CONSTRUCTION, AND NOTHING ON THIS DRAWING EXPRESSED OR IMPLIED CHANGES THIS CONDITION. CONTRACTOR SHALL BE RESPONSIBLE FOR KNOWING HOW THEY AFFECT THE WORK. SUBMITTAL OF A BID TO PERFORM THIS WORK IS AN ACKNOWLEDGEMENT OF THESE RESPONSIBILITIES, AND THAT THEY HAVE BEEN FULLY CONSIDERED IN PLANNING OF THE WORK, AND THE BID PRICE. NO CLAIMS FOR EXTRA CHARGES DUE TO
CONCRETE WALKWAY OR DECK		SEAL:
THE BACKFILL MATERIAL SHALL BE CRUSHED STONE OR OTHER GRANULAR MATERIAL MEETING THE REQUIREMENTS OF CLASS I, - CLASS II, OR CLASS III MATERIAL AS DEFINED IN ASTM D2321. BEDDING & BACKFILL FOR SURFACE DRAINAGE INLETS SHALL BE PLACED & COMPACTED UNIFORMLY IN ACCORDANCE WITH ASTM D2321.		P P R A C Y
L		PROFESSIONAL CERTIFICATION. I HEREBY CERTIFY THAT THESE DOCUMENTS WERE PREPARED OR APPROVED BY ME, AND THAT I AM A DULY LICENSED PROFESSIONAL ENGINEER UNDER THE LAWS OF THE STATE OF MARYLAND, LICENSE NO. 14446, EXPIRATION DATE 5/25/25.
VARIABLE SUMP DEPTH ACCORDING TO PLANS (6" MIN. BASED ON (6" MIN. BASED ON MANUFACTURING REQ.)		DATE: JANUARY 14, 2025
		PROJECT NO: 2023-10.04 DRAWN BY MJE CHECKED BY CMS
GRATE OPTIONS LOAD RATING PART # STANDARD LIGHT DUTY 0899CGSF		CHECKED BYCMSSUBMISSIONDATEBID SET01/14/2025
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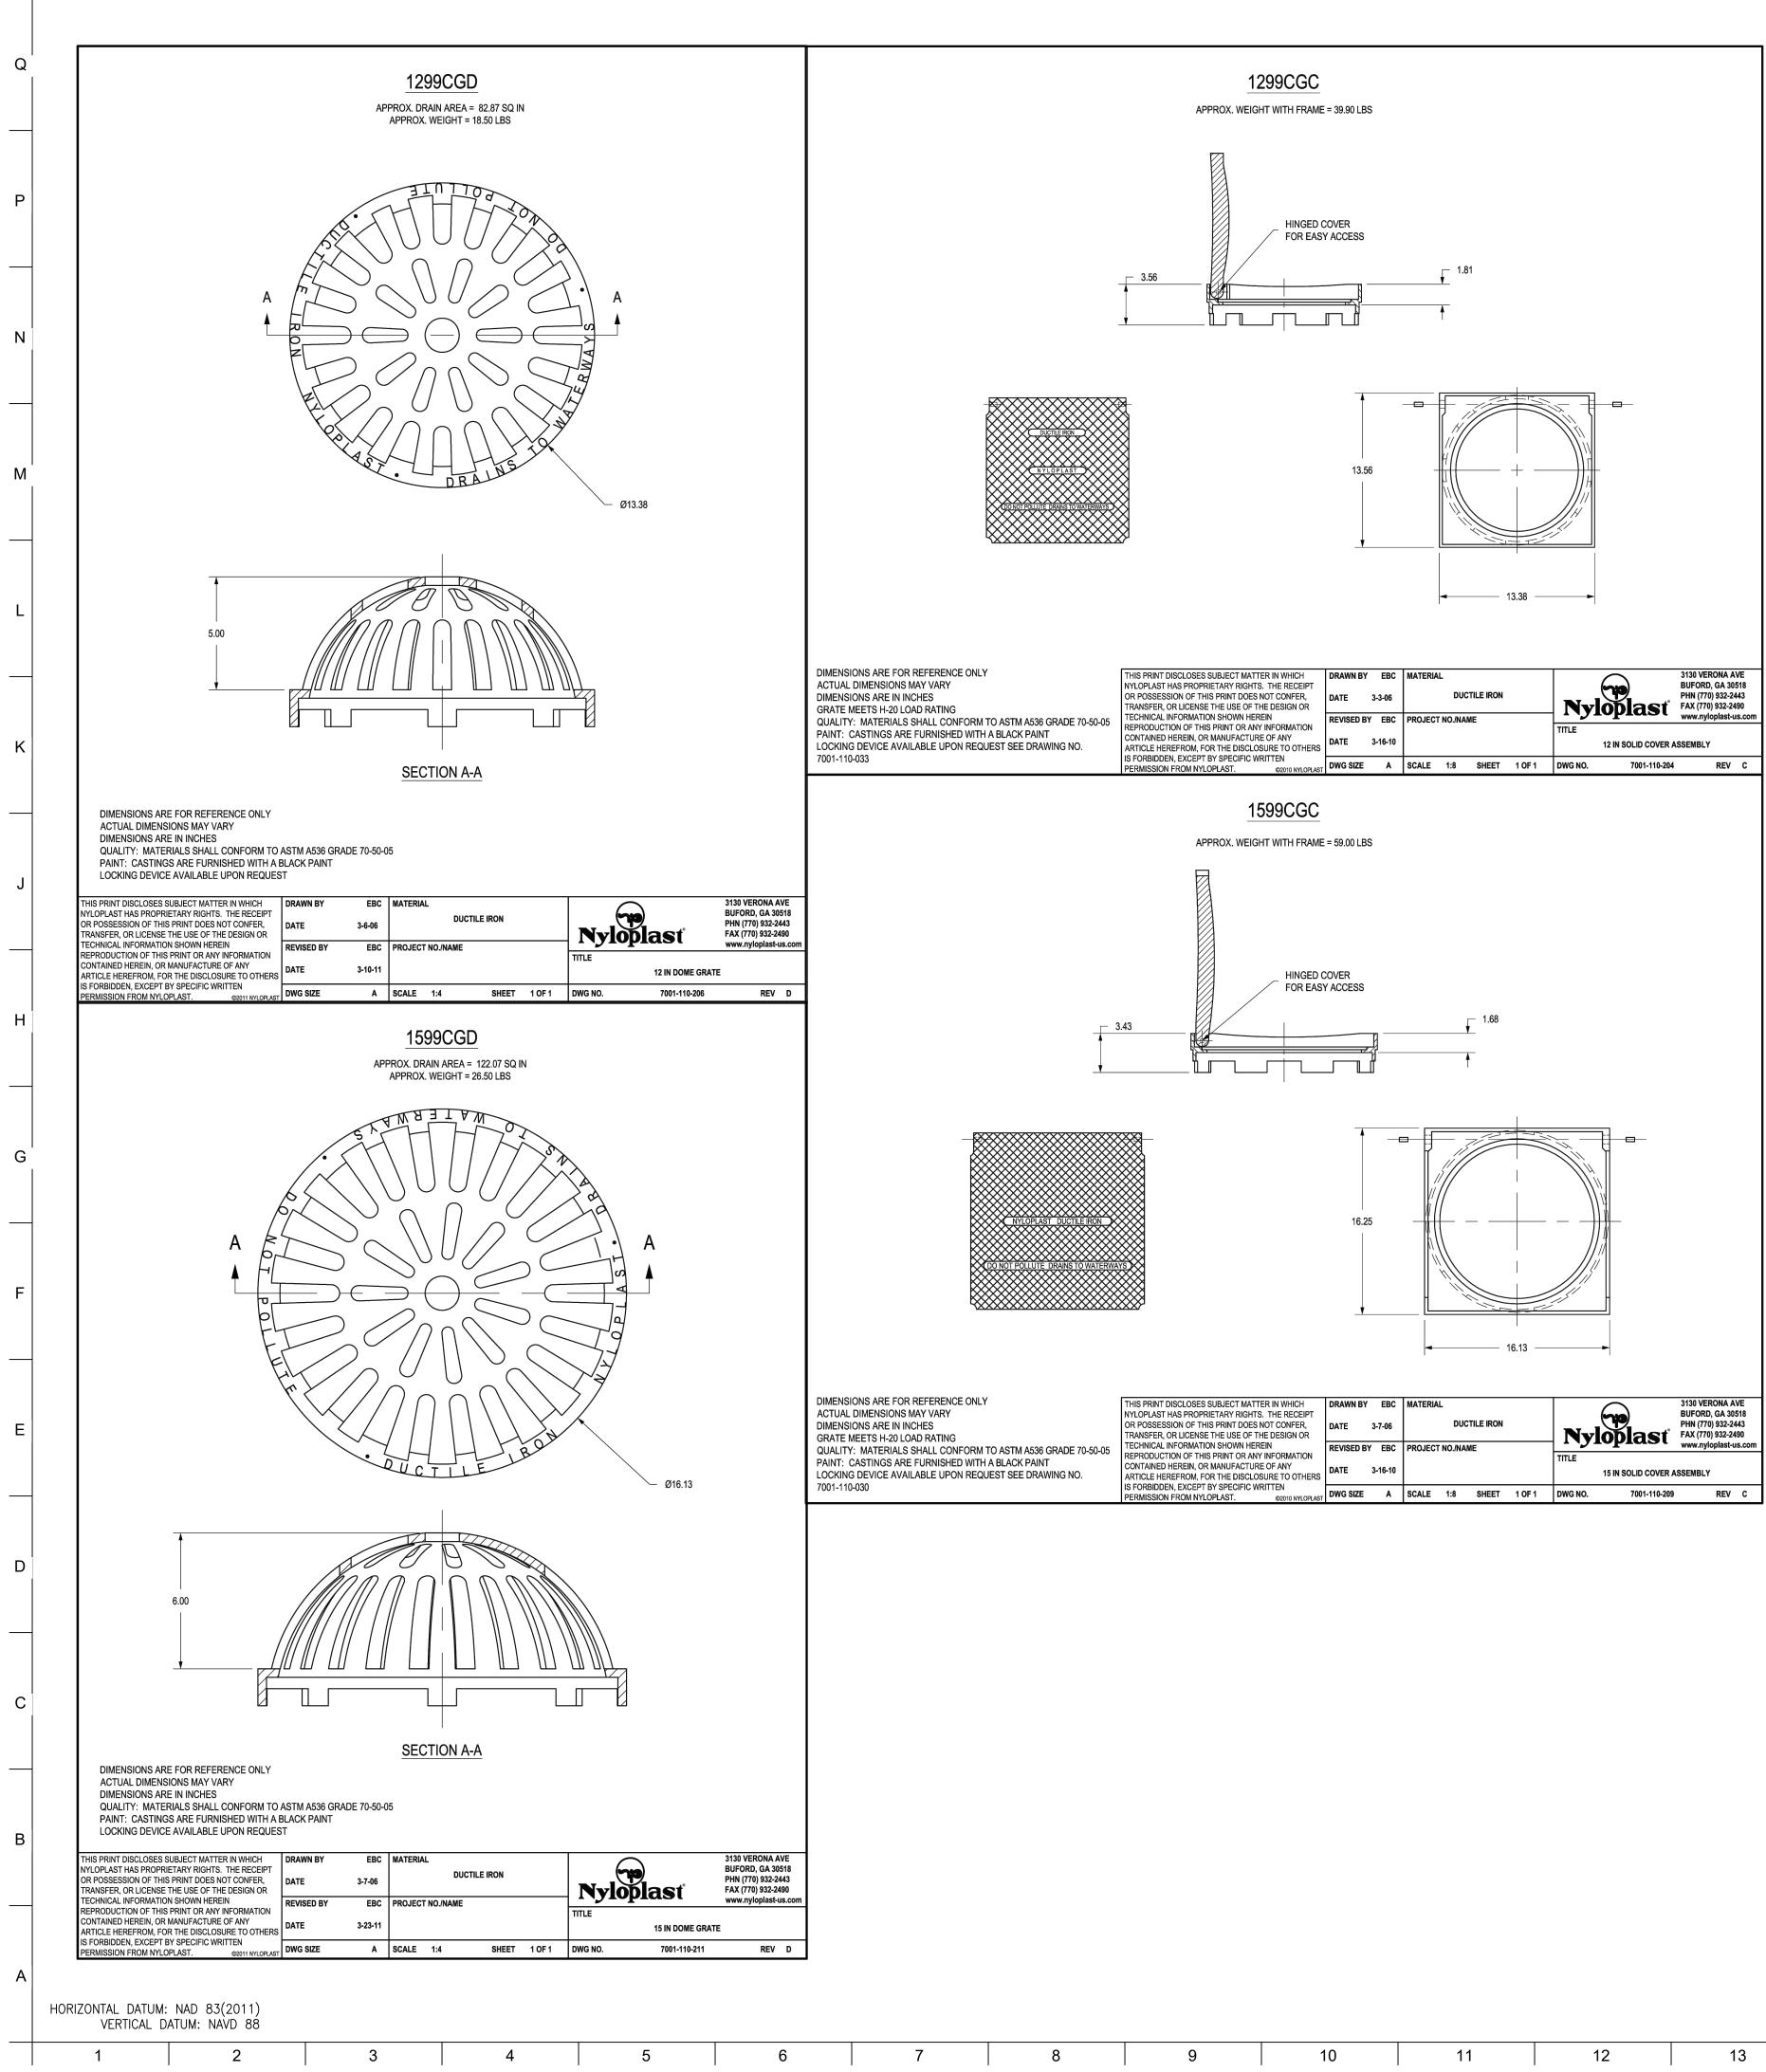
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	ВКР)
F	ROJECT TEAM:	
	ARCHITEC BUELL KRATZER PO	WELL, P.C.
	1525 LOCUST S PHILADELPHIA, F T: 215.557.6	PA 19102
	<u>CIVIL ENGINE</u> CARROLL ENGINEE 215 SCHILLING CIRC HUNT VALLEY, M T: 410.785.74	ERING, INC LE, STE 102 ID 21031
F	LANDSCAPE ARC OBINSON ANDERSO 28 WEST STATE MEDIA, PA 19 T: 302.888.1	N SUMMERS STREET 9063
	STRUCTURAL EN TRUCTURAL DESIGN 225 EAST MURRAY H SALT LAKE CITY, T: 801.274.3	I STUDIO, INC IOLLADAY RD UT 84117
к	MEP ENGINE OVACS, WHITNEY & 7 190 WEST OSTEND S BALTIMORE, ME T: 410.244.7	ASSOCIATES ST, STE 300 0 21230
	CLIENT:	
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	UBMISSION ID SET	DATE 01/14/2025
R	EVISION	DATE
	DRAWING TITLE: STORM DR	AIN
	DETAILS	5
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OWNER / DEVELOPER/ APPLICANT: MARYLAND ZOO IN BALTIMORE 1876 MANSION HOUSE DRIVE BALTIMORE MD 21217 CONTACT: MR. KARL KRANZ PHONE: 443-552-3350



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PROJECT TEAM:	
ARCHITEC	T:
BUELL KRATZER PO 1525 LOCUST S	IREE T
PHILADELPHIA, P T: 215.557.65	
<u>CIVIL ENGINE</u> CARROLL ENGINEE	
215 SCHILLING CIRC HUNT VALLEY, M	LE, STE 102
T: 410.785.74 LANDSCAPE ARC	
ROBINSON ANDERSO 28 WEST STATE S	N SUMMERS
MEDIA, PA 19 T: 302.888.15	063
STRUCTURAL EN STRUCTURAL DESIGN	
2225 EAST MURRAY H SALT LAKE CITY, U	OLLADAY RD
T: 801.274.39	950
MEP ENGINE KOVACS, WHITNEY & A	ASS OCIATES
190 WEST OSTEND S BALTIMORE, MD T: 410.244.7	21230
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CLIENT: MARYLANI	חחק ר
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NO 14446 PEOSTERED	
PROFESSIONAL CERTIFICATION. I HER THAT THESE DOCUMENTS WERE PREF	ARED OR
APPROVED BY ME, AND THAT I AM A D PROFESSIONAL ENGINEER UNDER THI STATE OF MARYLAND, LICENSE NO. 14 EXPIRATION DATE 5/25/25 .	LAWS OF THE
DATE: JANUARY 14, 20	25
PROJECT NO: 2023-10. DRAWN BY	
CHECKED BY	CMS
SUBMISSION BID SET	DATE 01/14/2025
REVISION	DATE
DRAWING TITLE:	
Storm Dr. Details	
DRAWING NO:	
(5)	2
	

OWNER / DEVELOPER/ APPLICANT: MARYLAND ZOO IN BALTIMORE 1876 MANSION HOUSE DRIVE BALTIMORE MD 21217 CONTACT: MR. KARL KRANZ PHONE: 443-552-3350



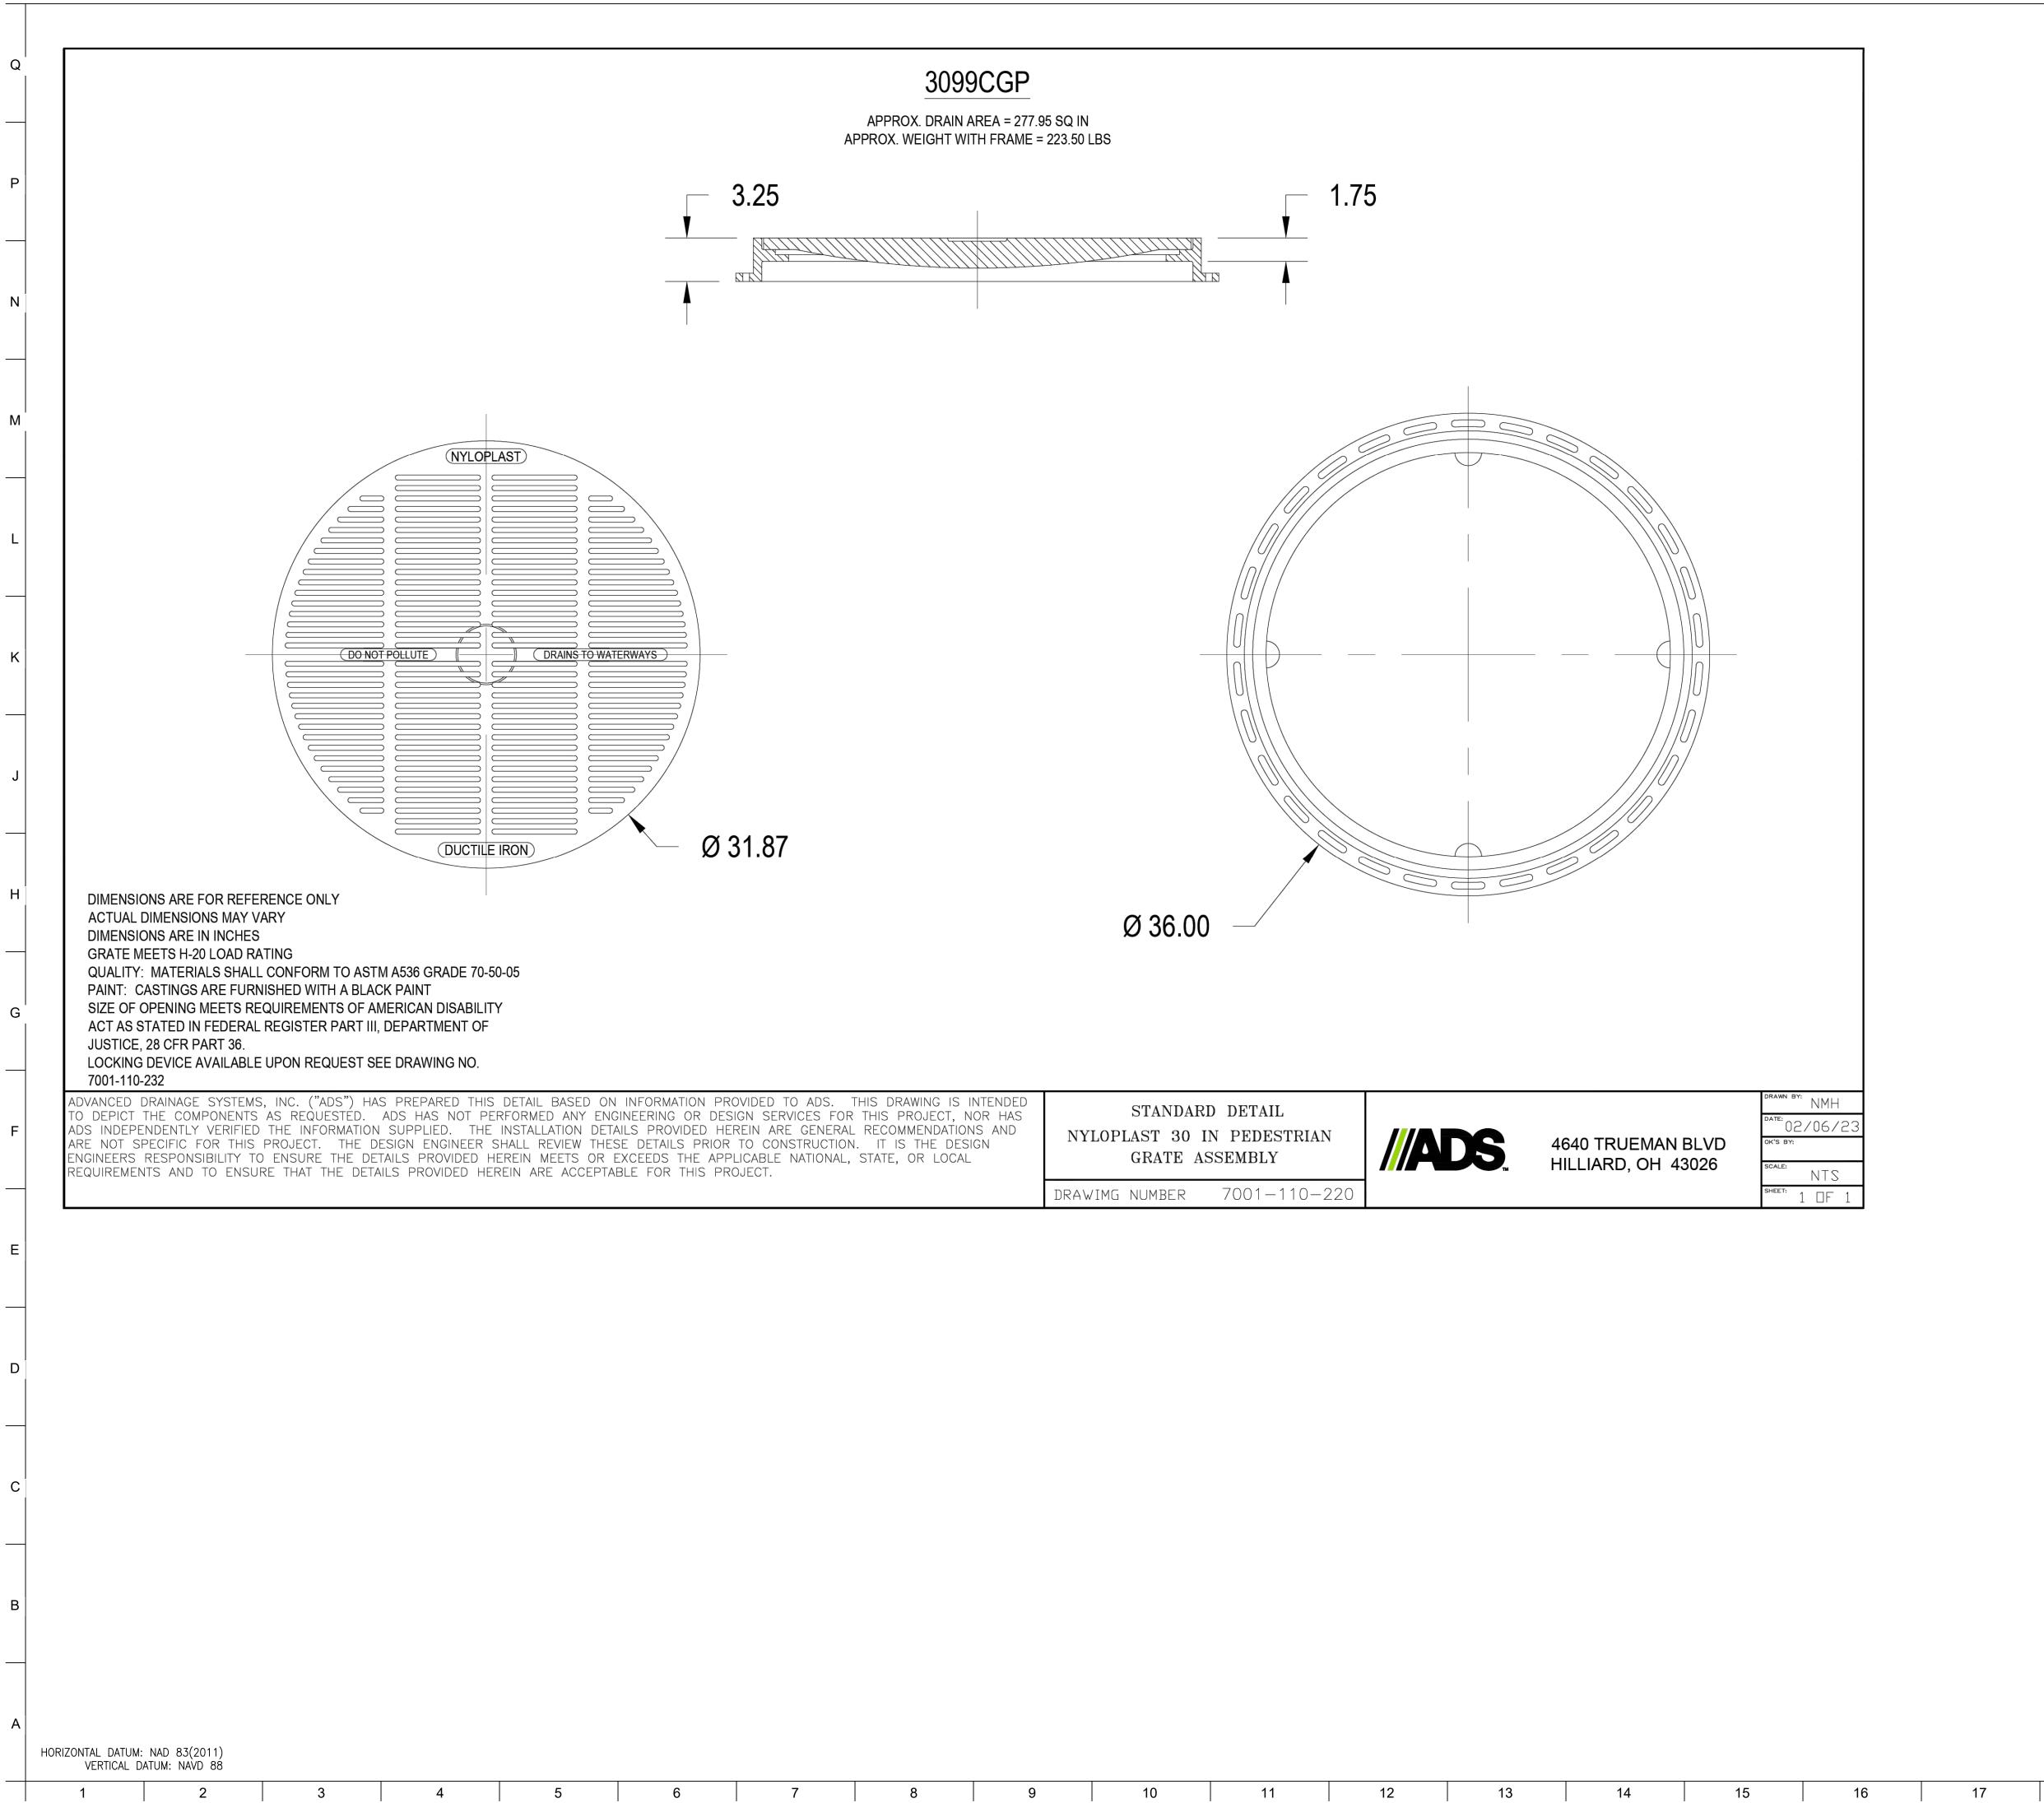
BKP	
PROJECT TEAM:	
ARCHITEC	-
T: 215.557.6	STREET PA 19102
CIVIL ENGIN CARROLL ENGINE 215 SCHILLING CIRC HUNT VALLEY, M T: 410.785.7	ERING, INC CLE, STE 102 MD 21031
LANDSCAPE AR ROBINSON ANDERS 28 WEST STATE MEDIA, PA 1 T: 302.888.7	ON SUMMERS STREET 9063
STRUCTURAL EI STRUCTURAL DESIG 2225 EAST MURRAY SALT LAKE CITY,	N STUDIO, INC HOLLADAY RD UT 84117
T: 801.274.3 <u>MEP ENGIN</u> KOVACS, WHITNEY & 190 WEST OSTEND BALTIMORE, M	<u>EER:</u> ASSOCIATES ST, STE 300
T: 410.244.7	
CLIENT: MARYLAN	ח 700
THE MARYLAND ZOO 1 SAFARI PL BALTIMORE, MI	IN BALTIMORE ACE
Q	217
RED PANDA THE MARYLAND ZOO IN BALTIMORE	PLACE MD 2121
RED PANDA MARYLAND ZO IN BALTIMORE	, MD
DP.	ore, i
	LTIM
	BA
THIS DRAWING IS TO ILLUSTRATE THE W ARCHITECT IS NOT RESPONSIBLE METHODS, TECHNIQUES, SEQUENCESS USED TO DO THE WORK OR THE SA CONSTRUCTION, AND NOTHING ON THI OR IMPLIED CHANGES THIS CONDITION. RESPONSIBLE FOR KNOWING HOW TH SUBMITTAL OF A BID TO PERFORM ACKNOWLEDGEMENT OF THESE RESPONS	FOR THE MEANS, 5, AND PROCEDURES SFETY ASPECTS OF S DRAWING EXPRESSED CONTRACTOR SHALL BE EY AFFECT THE WORK. THIS WORK IS AN SIBILITIES, AND THAT THEY
HAVE BEEN FULLY CONSIDERED IN PLA AND THE BID PRICE. NO CLAIMS FOR EX THESE CONDITIONS WILL BE FO	TRA CHARGES DUE TO
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PROFESSIONAL CERTIFICATION. I + THAT THESE DOCUMENTS WERE P APPROVED BY ME, AND THAT I AM, PROFESSIONAL ENGINEER UNDER STATE OF MARYLAND, LICENSE NO EXPIRATION DATE 5/25/25.	REPARED OR A DULY LICENSED THE LAWS OF THE
DATE: JANUARY 14, 2 PROJECT NO: 2023-10	
DRAWN BY CHECKED BY	MJE CMS
SUBMISSION BID SET	DATE 01/14/2025
REVISION	DATE
DRAWING TITLE: STORM DF DETAIL	
	•
DRAWING NO:	
C52	23

<u>OWNER / DEVELOPER/ APPLICANT</u>: MARYLAND ZOO IN BALTIMORE 1876 MANSION HOUSE DRIVE BALTIMORE MD 21217 CONTACT: MR. KARL KRANZ PHONE: 443-552-3350

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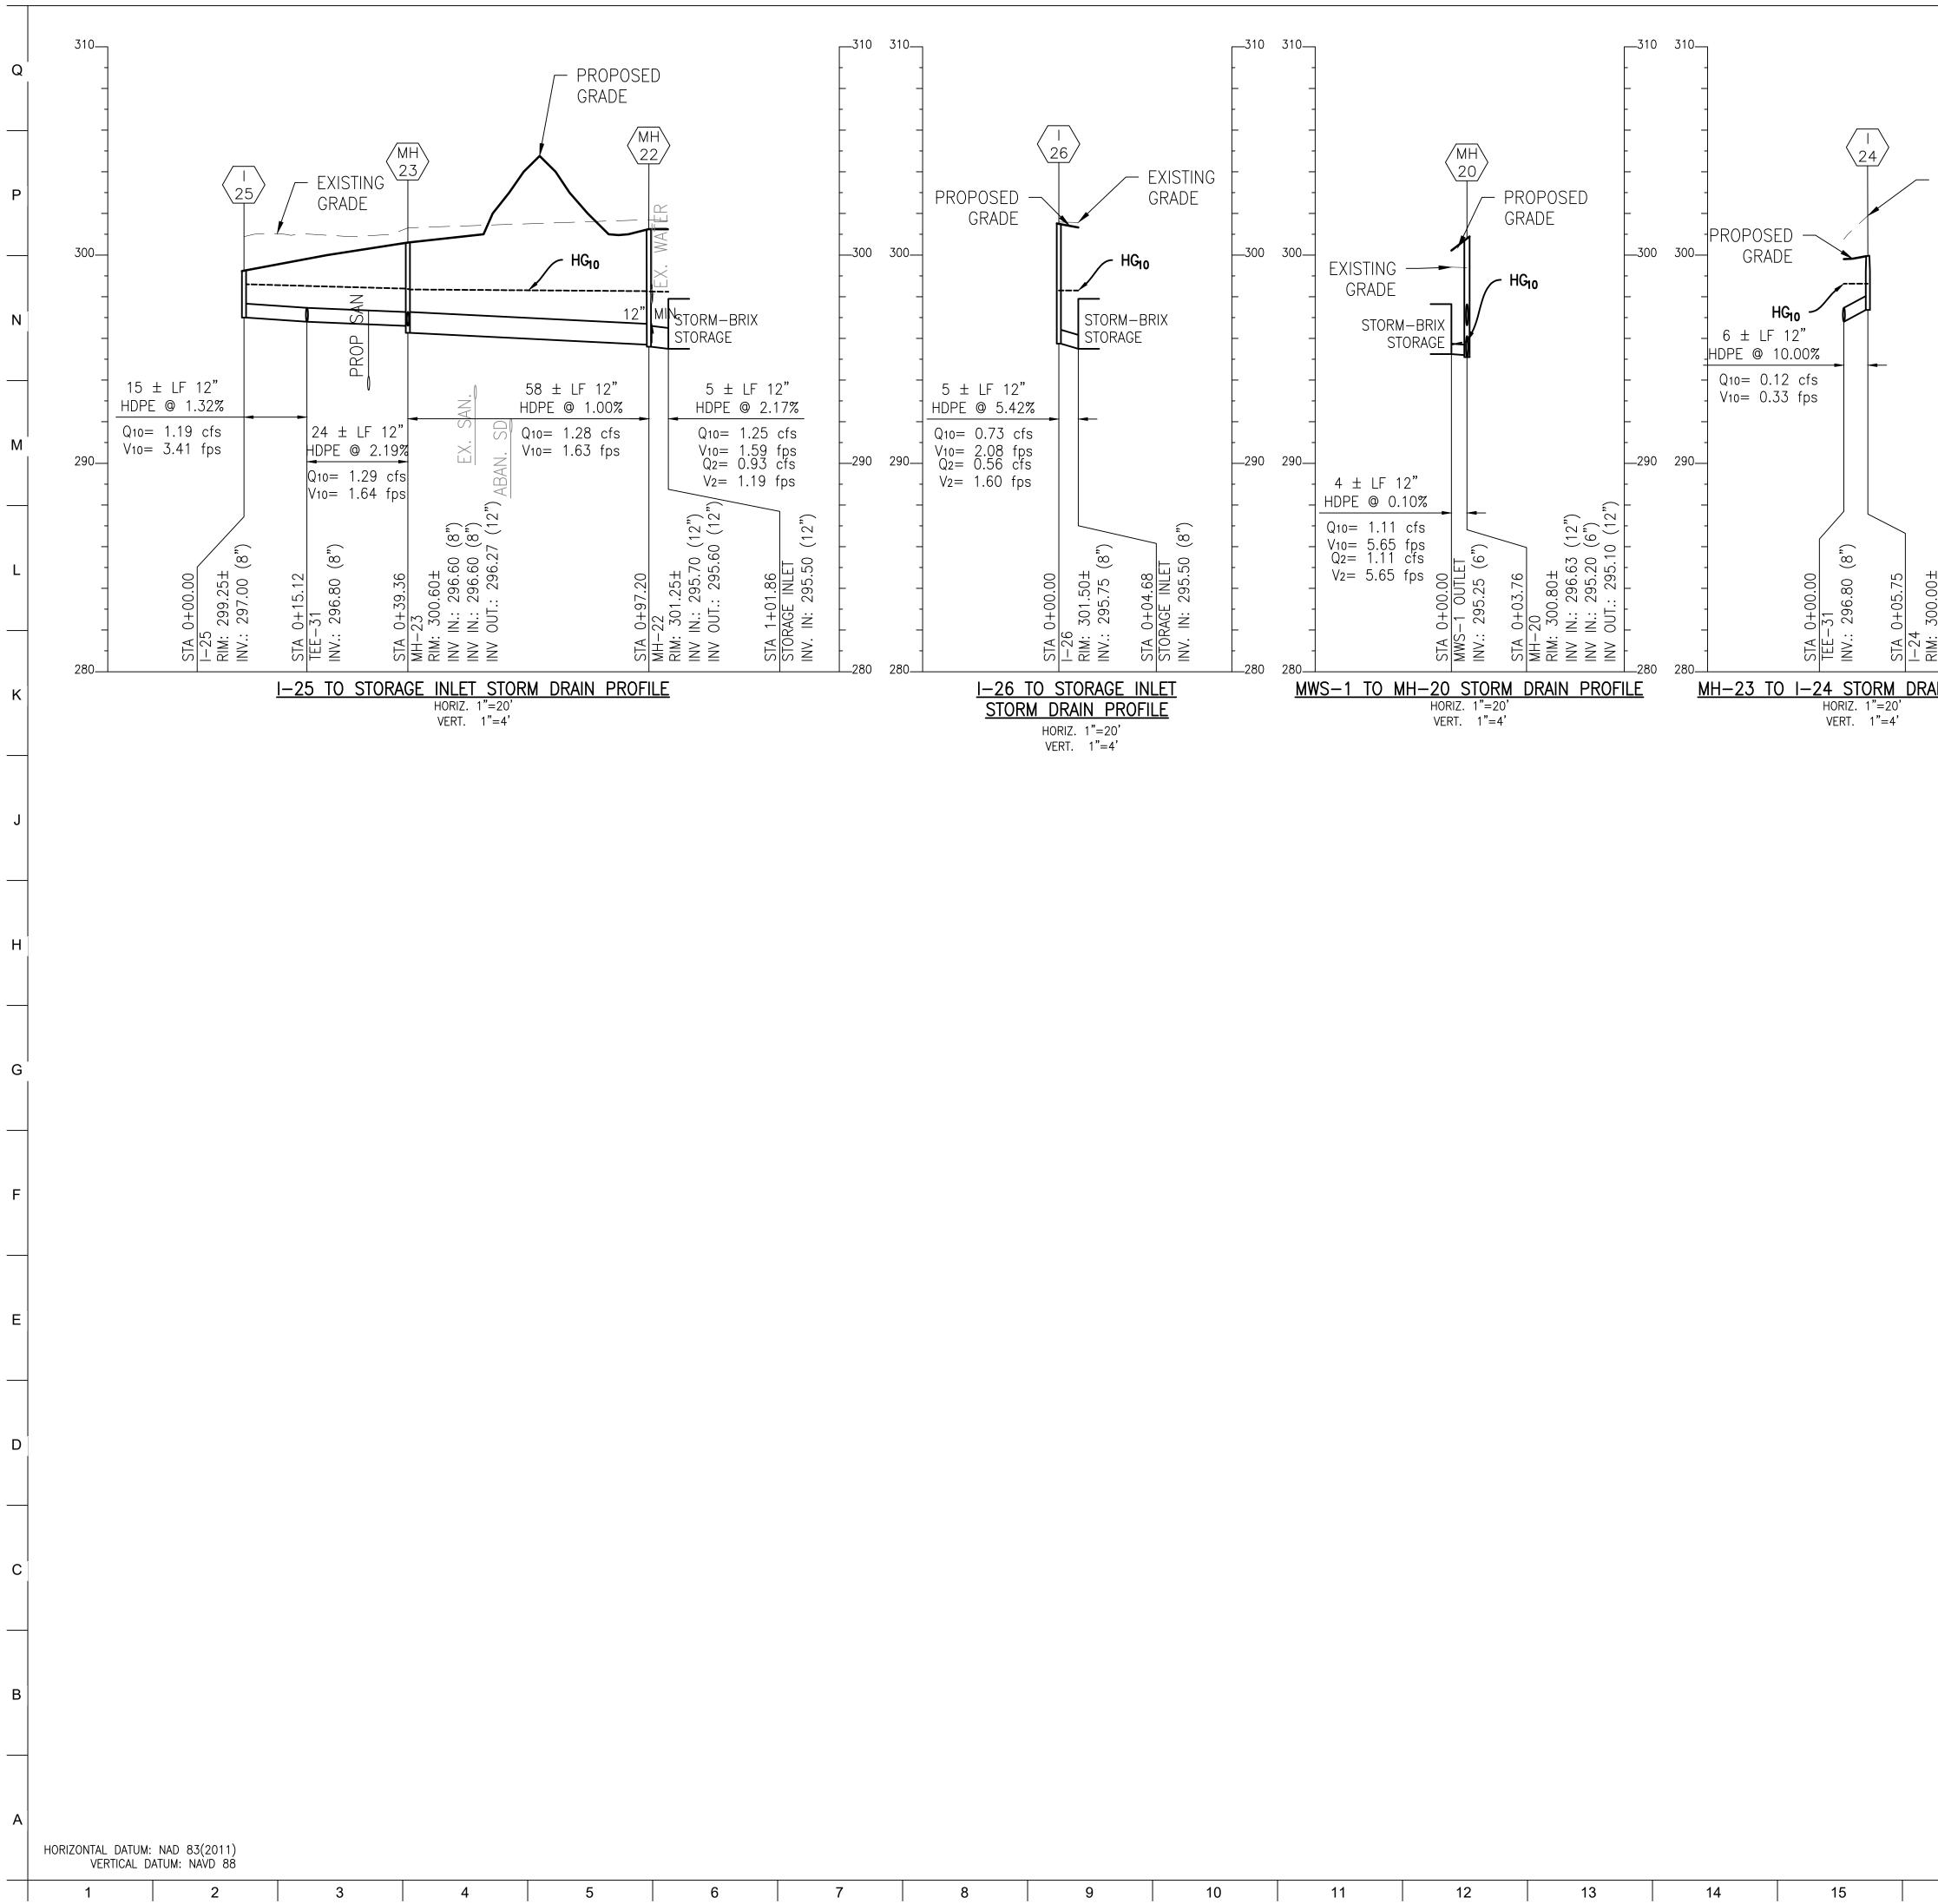


THIS DRAWING IS INTENDED OR THIS PROJECT, NOR HAS AL RECOMMENDATIONS AND ON. IT IS THE DESIGN L, STATE, OR LOCAL	NYLOPLAST 30	D DETAIL IN PEDESTRIAN SSEMBLY	4640 TRUEMAN BLVD HILLIARD, OH 43026	DRAWN BY: NMH DATE: 02/06/23 OK'S BY: SCALE: NTS
	DRAWIMG NUMBER	7001-110-220		SHEET: 1 OF 1

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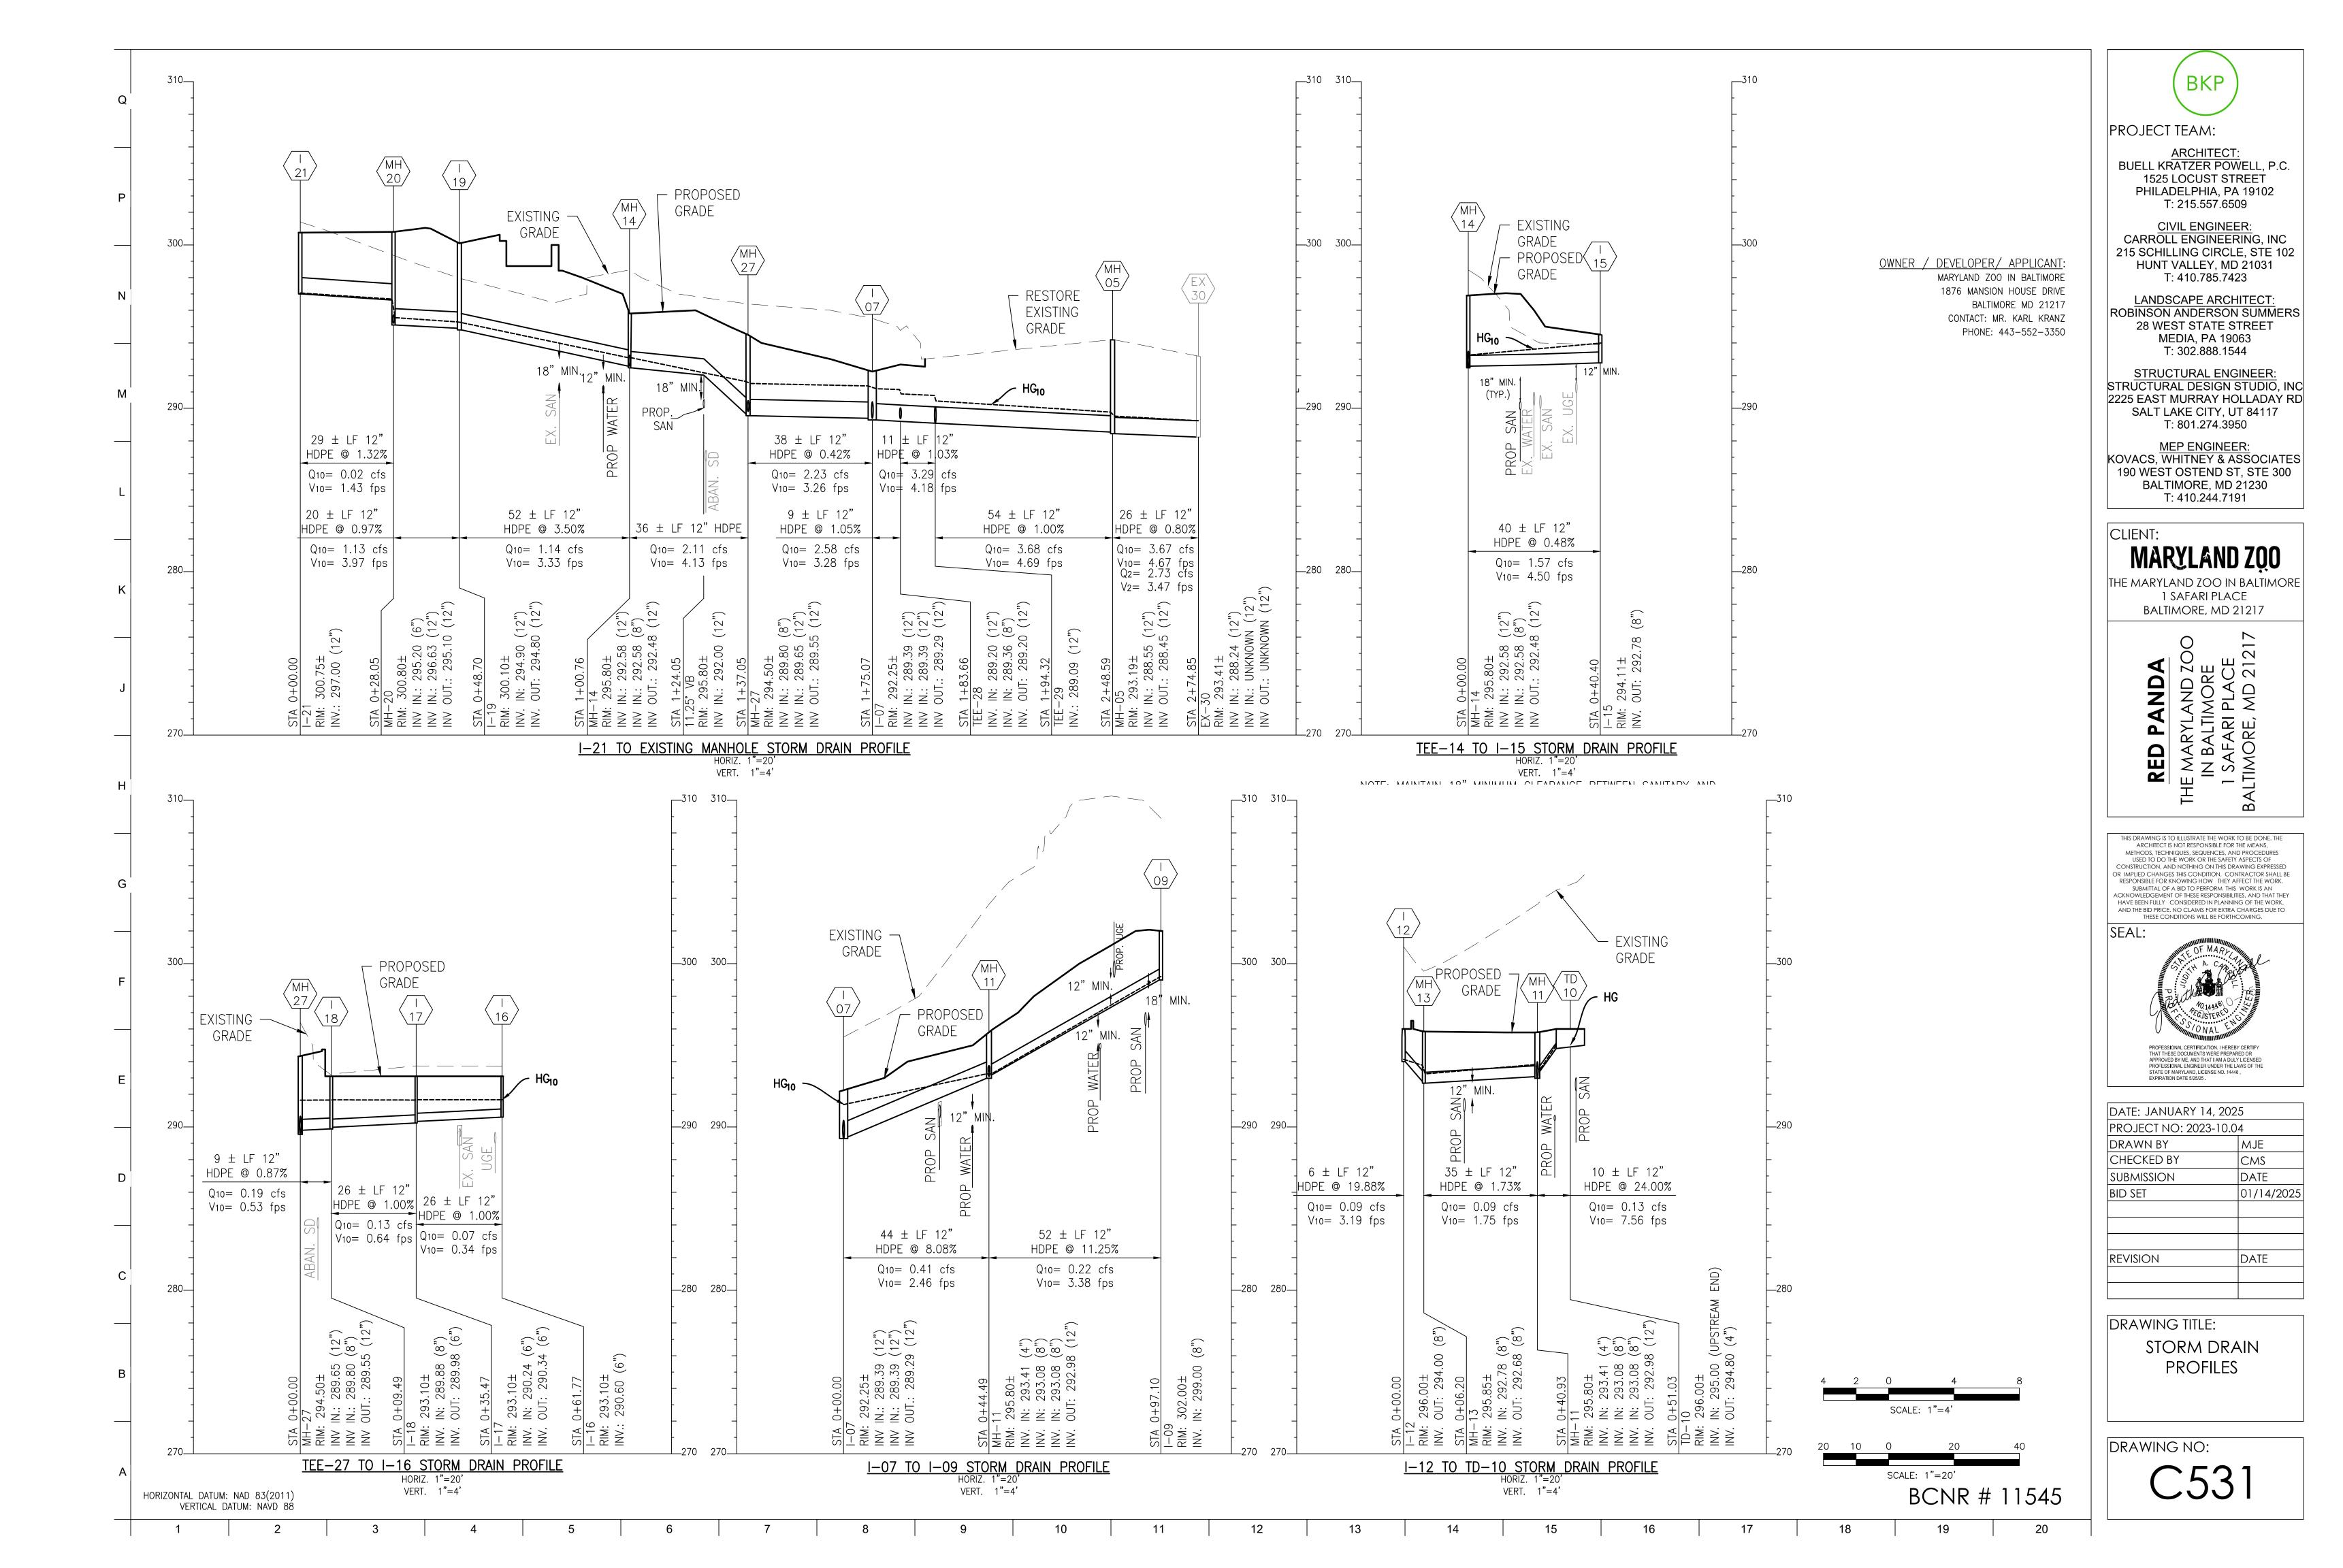
	BKP	
	PROJECT TEAM: <u>ARCHITECT:</u> BUELL KRATZER POWELL, P.C. 1525 LOCUST STREET PHILADELPHIA, PA 19102 T: 215.557.6509	
OWNER / DEVELOPER/ APPLICANT: MARYLAND ZOO IN BALTIMORE 1876 MANSION HOUSE DRIVE	<u>CIVIL ENGINEER:</u> CARROLL ENGINEERING, INC 215 SCHILLING CIRCLE, STE 102 HUNT VALLEY, MD 21031 T: 410.785.7423	
BALTIMORE MD 21217 CONTACT: MR. KARL KRANZ PHONE: 443–552–3350	LANDSCAPE ARCHITECT: ROBINSON ANDERSON SUMMERS 28 WEST STATE STREET MEDIA, PA 19063 T: 302.888.1544	
	STRUCTURAL ENGINEER: STRUCTURAL DESIGN STUDIO, INC 2225 EAST MURRAY HOLLADAY RE SALT LAKE CITY, UT 84117 T: 801.274.3950	
	MEP ENGINEER: KOVACS, WHITNEY & ASSOCIATES 190 WEST OSTEND ST, STE 300 BALTIMORE, MD 21230 T: 410.244.7191	
	CLIENT: MARYLAND ZOO	
	THE MARYLAND ZOO IN BALTIMORE 1 SAFARI PLACE BALTIMORE, MD 21217	_
	PANDA RYLAND ZOO ALTIMORE ARI PLACE RE, MD 21217	
	RED P THE MARY IN BAL I SAFAF BALTIMORF	
	THIS DRAWING IS TO ILLUSTRATE THE WORK TO BE DONE. THE ARCHITECT IS NOT RESPONSIBLE FOR THE MEANS, METHODS, TECHNIQUES, SEQUENCES, AND PROCEDURES USED TO DO THE WORK OR THE SAFETY ASPECTS OF CONSTRUCTION, AND NOTHING ON THIS DRAWING EXPRESSED OR IMPLIED CHANGES THIS CONDITION. CONTRACTOR SHALL BE RESPONSIBLE FOR KNOWING HOW THEY AFFECT THE WORK. SUBMITTAL OF A BID TO PERFORM THIS WORK IS AN ACKNOWLEDGEMENT OF THESE RESPONSIBILITIES, AND THAT THEY HAVE BEEN FULLY CONSIDERED IN PLANNING OF THE WORK, AND THE BID PRICE. NO CLAIMS FOR EXTRA CHARGES DUE TO THESE CONDITIONS WILL BE FORTHCOMING.	
	SEAL:	
	PROFESSIONAL CERTIFICATION. I HEREBY CERTIFY THAT THESE DOCUMENTS WERE PREPARED OR APPROVED BY ME, AND THAT I AM A DULY LICENSED PROFESSIONAL ENGINEER UNDER THE LAWS OF THE STATE OF MARYLAND, LICENSE NO. 14446, EXPIRATION DATE 5/25/25.	
	DATE: JANUARY 14, 2025 PROJECT NO: 2023-10.04	
	DRAWN BY MJE CHECKED BY CMS	_
	SUBMISSION DATE BID SET 01/14/2025	
	REVISION DATE	-
	DRAWING TITLE: STORM DRAIN DETAILS	
BCNR # 11545	C524	
18 19 20		

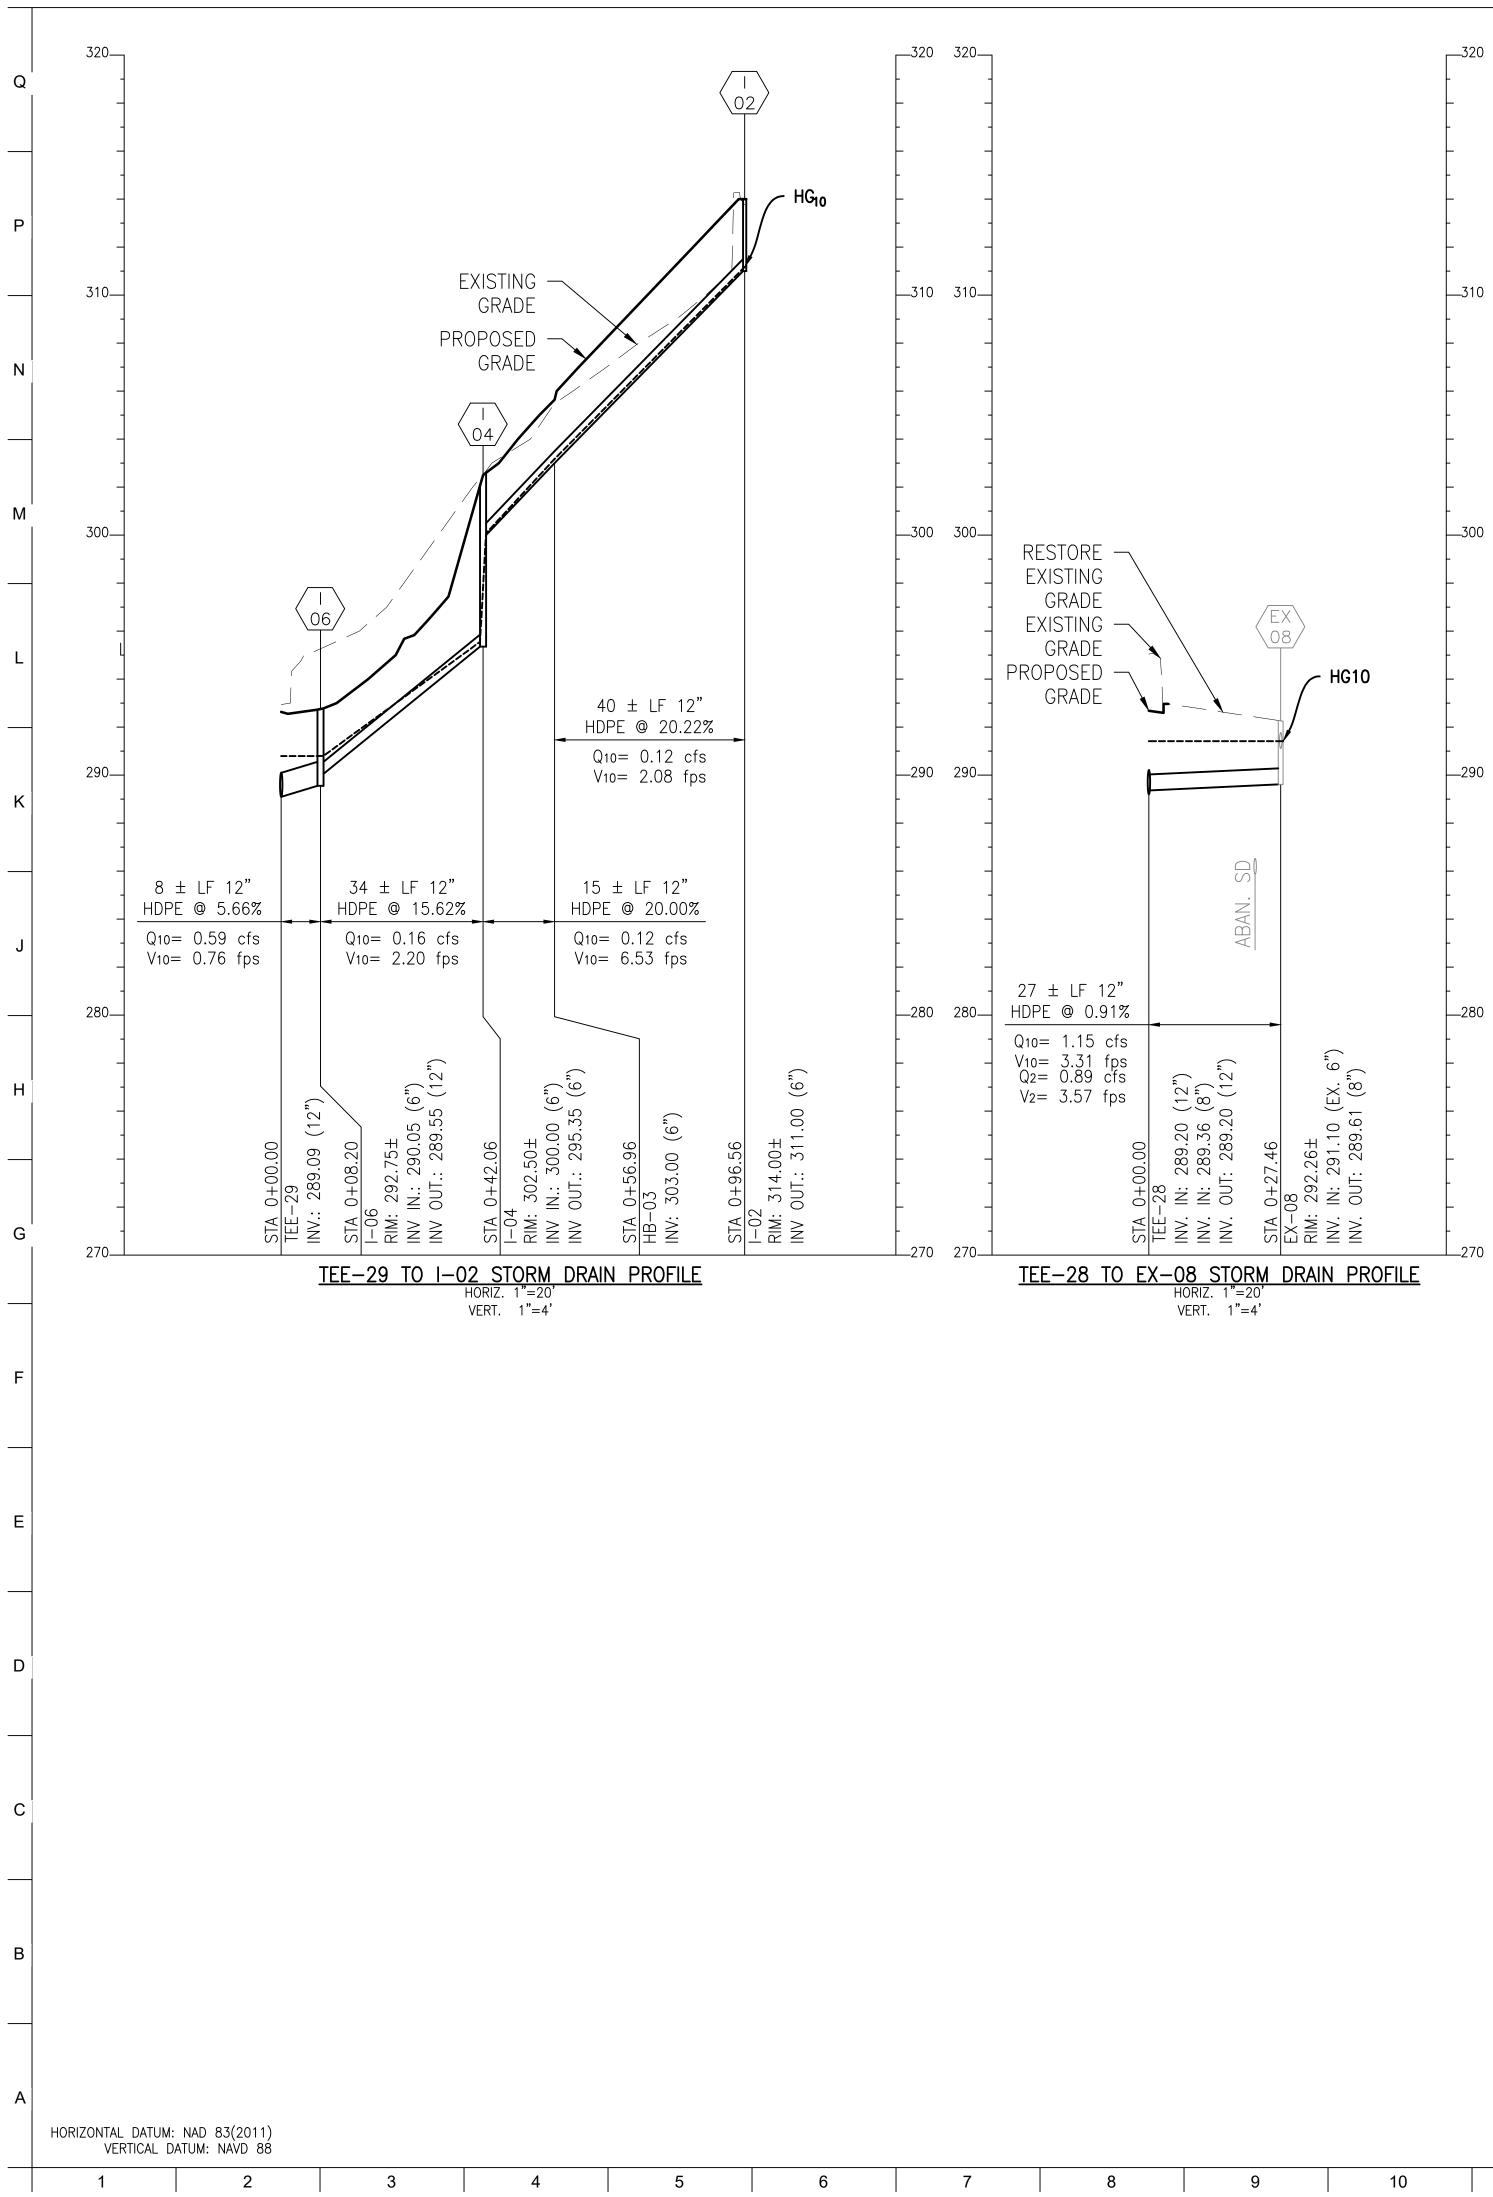
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	-		PROJECT TEAM:
EXISTING GRADE	-		<u>ARCHITECT:</u> BUELL KRATZER POWELL, P.C. 1525 LOCUST STREET PHILADELPHIA, PA 19102 T: 215.557.6509
		<u>OWNER / DEVELOPER/ APPLICANT</u> : MARYLAND ZOO IN BALTIMORE	<u>CIVIL ENGINEER:</u> CARROLL ENGINEERING, INC 215 SCHILLING CIRCLE, STE 102 HUNT VALLEY, MD 21031 T: 410.785.7423
-	-	1876 MANSION HOUSE DRIVE BALTIMORE MD 21217 CONTACT: MR. KARL KRANZ PHONE: 443–552–3350	LANDSCAPE ARCHITECT: ROBINSON ANDERSON SUMMERS 28 WEST STATE STREET MEDIA, PA 19063 T: 302.888.1544
	- - 290		<u>STRUCTURAL ENGINEER:</u> STRUCTURAL DESIGN STUDIO, INC 2225 EAST MURRAY HOLLADAY RD SALT LAKE CITY, UT 84117 T: 801.274.3950
.75 00± 297.37 (8")	-		MEP ENGINEER: KOVACS, WHITNEY & ASSOCIATES 190 WEST OSTEND ST, STE 300 BALTIMORE, MD 21230 T: 410.244.7191
STA 0+05 STA 0+05 I - 24 INV. 0UT: INV. 0UT: I - 24 I - 24 I - 24 I - 27 I - 27 I - 20			CLIENT: MARYLAND ZOO THE MARYLAND ZOO IN BALTIMORE 1 SAFARI PLACE
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			THIS DRAWING IS TO ILLUSTRATE THE WORK TO BE DONE. THE
			ARCHITECT IS NOT RESPONSIBLE FOR THE MEANS, METHODS, TECHNIQUES, SEQUENCES, AND PROCEDURES USED TO DO THE WORK OR THE SAFETY ASPECTS OF CONSTRUCTION, AND NOTHING ON THIS DRAWING EXPRESSED OR IMPLIED CHANGES THIS CONDITION. CONTRACTOR SHALL BE RESPONSIBLE FOR KNOWING HOW THEY AFFECT THE WORK. SUBMITTAL OF A BID TO PERFORM THIS WORK IS AN ACKNOWLEDGEMENT OF THESE RESPONSIBILITIES, AND THAT THEY HAVE BEEN FULLY CONSIDERED IN PLANNING OF THE WORK, AND THE BID PRICE. NO CLAIMS FOR EXTRA CHARGES DUE TO THESE CONDITIONS WILL BE FORTHCOMING. SEAL:
			P Rote S S O N A L ENGLINE
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			DATE: JANUARY 14, 2025 PROJECT NO: 2023-10.04 DRAWN BY MJE CHECKED BY CMS SUBMISSION DATE BID SET 01/14/2025
			REVISION DATE
		4 2 0 4 8	DRAWING TITLE: STORM DRAIN PROFILES
		SCALE: 1"=4'	
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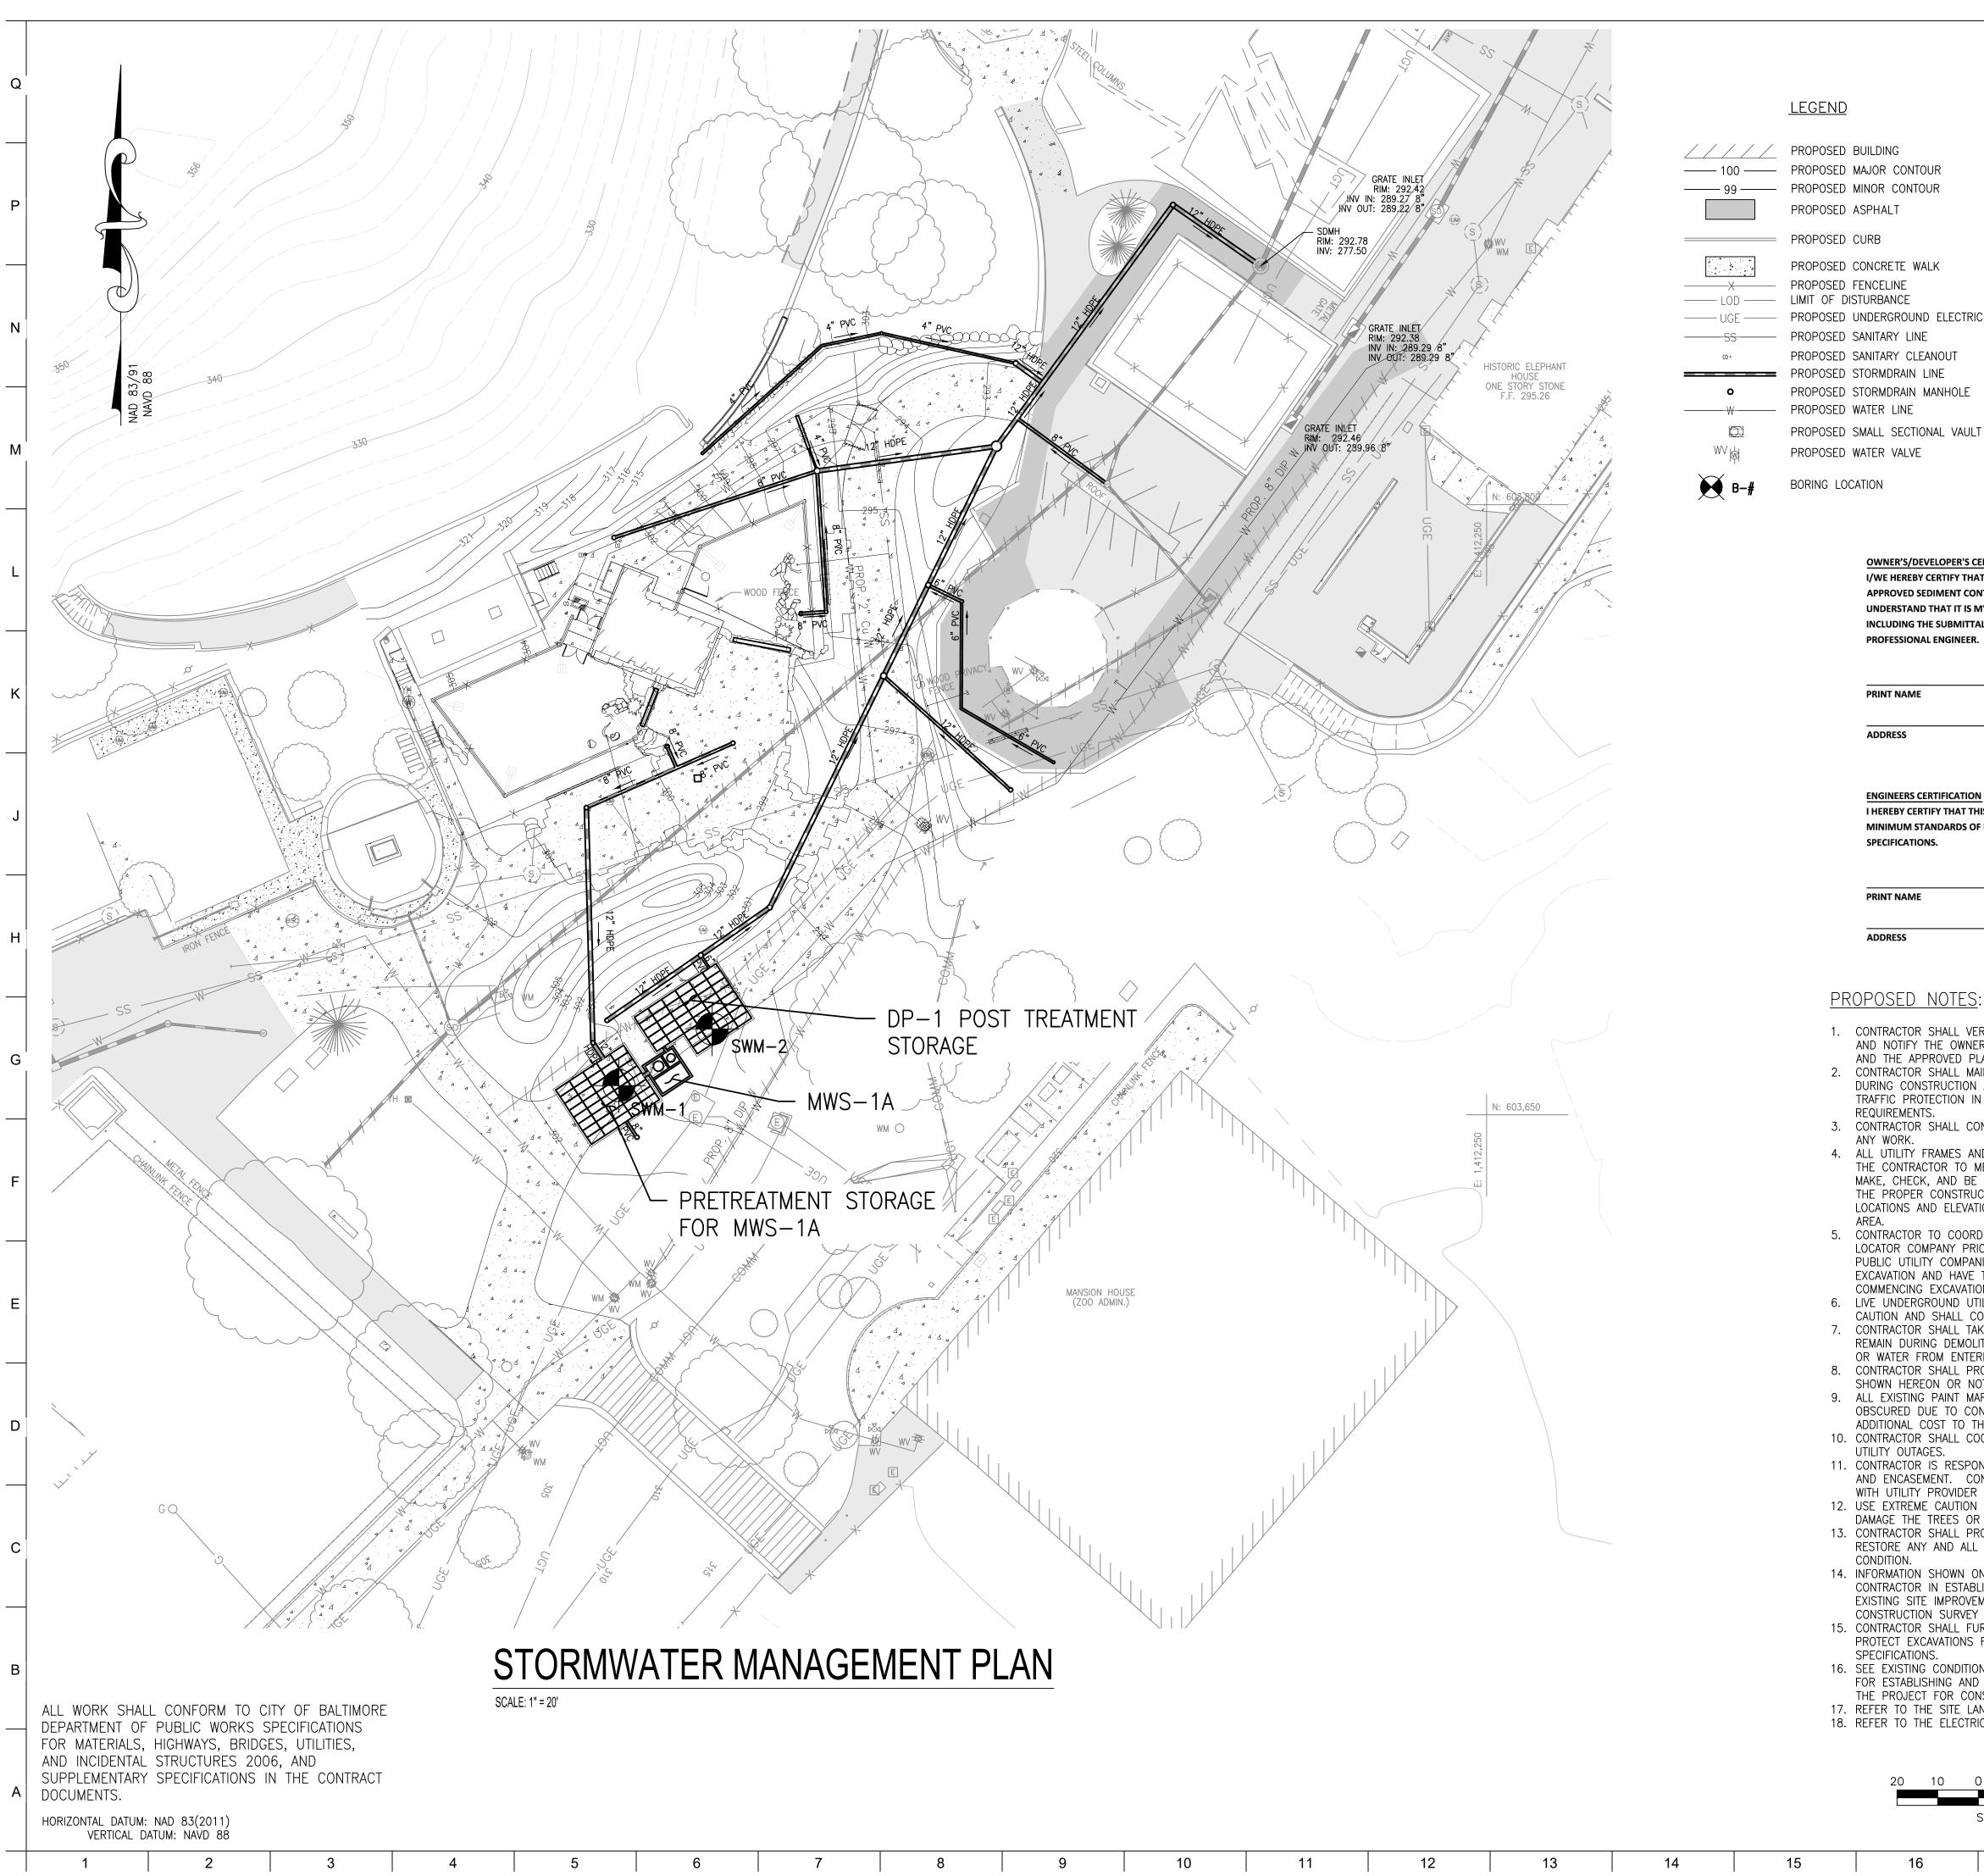




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	PROJECT TEAM:
	ARCHITECT:
	BUELL KRATZER POWELL, P.C. 1525 LOCUST STREET
	PHILADELPHIA, PA 19102 T: 215.557.6509
	<u>CIVIL ENGINEER:</u> CARROLL ENGINEERING, INC
OWNER / DEVELOPER/ APPLICANT:	215 SCHILLING CIRCLE, STE 102 HUNT VALLEY, MD 21031
MARYLAND ZOO IN BALTIMORE 1876 MANSION HOUSE DRIVE	T: 410.785.7423
BALTIMORE MD 21217 CONTACT: MR. KARL KRANZ	LANDSCAPE ARCHITECT: ROBINSON ANDERSON SUMMERS
PHONE: 443-552-3350	28 WEST STATE STREET MEDIA, PA 19063
	T: 302.888.1544 STRUCTURAL ENGINEER:
	STRUCTURAL DESIGN STUDIO, INC 2225 EAST MURRAY HOLLADAY RD
	SALT LAKE CITY, UT 84117 T: 801.274.3950
	MEP ENGINEER:
	KOVACS, WHITNEY & ASSOCIATES 190 WEST OSTEND ST, STE 300
	BALTIMORE, MD 21230 T: 410.244.7191
	CLIENT:
	MARYLAND ZOO
	THE MARYLAND ZOO IN BALTIMORE
	1 SAFARI PLACE BALTIMORE, MD 21217
	RED PANDA E Maryland Z In Baltimore I Safari Place Timore, MD 21
	BAL THE
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	PROFESSIONAL CERTIFICATION. I HEREBY CERTIFY THAT THESE DOCUMENTS WERE PREPARED OR APPROVED BY ME, AND THAT I AM A DULY LICENSED
	PROFESSIONAL ENGINEER UNDER THE LAWS OF THE STATE OF MARYLAND, LICENSE NO. 14446 , EXPIRATION DATE 5/25/25 .
	DATE: JANUARY 14, 2025
	PROJECT NO: 2023-10.04 DRAWN BY MJE
	CHECKED BY CMS
	SUBMISSIONDATEBID SET01/14/2025
	REVISION DATE
	DRAWING TITLE:
	STORM DRAIN PROFILES
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SCALE: 1"=20'	C532
BCNR # 11545	
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PROPOSED STORMDRAIN MANHOLE PROPOSED SMALL SECTIONAL VAULT

SWM CERTIFICATIONS SHEET REVISION DATE: May 18, 2022

OWNER'S/DEVELOPER'S CERTIFICATION

I/WE HEREBY CERTIFY THAT ALL PROPOSED WORK SHOWN IN THESE CONSTRUCTION DRAWING(S) AND APPROVED SEDIMENT CONTROL DRAWING(S) WILL BE ACCOMPLISHED PURSUANT TO THESE PLANS. I/WE ALSO UNDERSTAND THAT IT IS MY/OUR RESPONSIBILITY TO HAVE THE CONSTRUCTION SUPERVISED AND CERTIFIED INCLUDING THE SUBMITTAL OF "AS-BUILT" PLANS WITHIN THIRTY (30) DAYS OF COMPLETION, BY A REGISTERED **PROFESSIONAL ENGINEER**

BLABAT		
NAME		

SIGNATURE

ADDRESS

TELEPHONE NUMBER

ENGINEERS CERTIFICATION

I HEREBY CERTIFY THAT THIS PLAN HAS BEEN PREPARED BY ME OR UNDER MY SUPERVISION AND MEETS THE MINIMUM STANDARDS OF BALTIMORE CITY DEPARTMENT OF PUBLIC WORKS REQUIREMENTS AND SPECIFICATIONS.

PRINT NAME

TELEPHONE NUMBER

DATE

BCNR # 11545

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PROPOSED NOTES:

1. CONTRACTOR SHALL VERIFY FIELD CONDITIONS PRIOR TO AND DURING CONSTRUCTION/DEMOLITION AND NOTIFY THE OWNER IMMEDIATELY OF ANY DISCREPANCIES BETWEEN ACTUAL FIELD CONDITIONS AND THE APPROVED PLANS.

SIGNATURE

2. CONTRACTOR SHALL MAINTAIN PEDESTRIAN & VEHICULAR ACCESS TO AND AROUND OVERALL SITE DURING CONSTRUCTION ACTIVITIES. CONTRACTOR SHALL FURNISH VEHICULAR AND PEDESTRIAN TRAFFIC PROTECTION IN ACCORDANCE WITH MUTCD LATEST VERSION AND THE CITY OF BALTIMORE REQUIREMENTS.

3. CONTRACTOR SHALL CONTACT THE OWNER AND DEVELOPER 72 HOURS PRIOR TO COMMENCING ANY WORK. 4. ALL UTILITY FRAMES AND COVERS TO REMAIN WITHIN THE PROJECT AREA SHALL BE ADJUSTED BY

THE CONTRACTOR TO MEET NEW PAVEMENT OR GROUND ELEVATION. THE CONTRACTOR SHALL MAKE, CHECK, AND BE RESPONSIBLE FOR ALL MEASUREMENTS AND DIMENSIONS NECESSARY FOR THE PROPER CONSTRUCTION OF AND THE PREVENTION OF MISFITTINGS IN THE WORK. VERIFY LOCATIONS AND ELEVATIONS OF EXISTING UTILITIES BEFORE STARTING CONSTRUCTION IN EACH

5. CONTRACTOR TO COORDINATE WITH MISS UTILITY, THE CITY OF BALTIMORE, AND A PRIVATE UTILITY LOCATOR COMPANY PRIOR TO COMMENCING ANY WORK. THE CONTRACTOR MUST NOTIFY ALL PUBLIC UTILITY COMPANIES WITH UNDERGROUND FACILITIES IN THE AREA OF PROPOSED EXCAVATION AND HAVE THOSE FACILITIES LOCATED BY THE UTILITY COMPANIES PRIOR TO COMMENCING EXCAVATION.

6. LIVE UNDERGROUND UTILITIES EXIST WITHIN THE WORK AREA. CONTRACTOR SHALL USE EXTREME CAUTION AND SHALL COMPLY WITH APPLICABLE FEDERAL, STATE AND LOCAL REGULATIONS. CONTRACTOR SHALL TAKE NECESSARY PRECAUTIONS TO PROTECT EXISTING UTILITY STRUCTURES TO REMAIN DURING DEMOLITION AND CONSTRUCTION ACTIVITIES AND TO PREVENT DEBRIS, SEDIMENT, OR WATER FROM ENTERING THE STRUCTURES. 8. CONTRACTOR SHALL PROTECT ALL FACILITIES AND UTILITIES TO REMAIN FROM DAMAGE WHETHER

SHOWN HEREON OR NOT. 9. ALL EXISTING PAINT MARKINGS ADJACENT TO THE PROJECT AREA WHICH BECOME FADED OR

OBSCURED DUE TO CONSTRUCTION ACTIVITY SHALL BE REPAINTED OR RESTORED AT NO ADDITIONAL COST TO THE OWNER. 10. CONTRACTOR SHALL COORDINATE WITH OWNER AND UTILITY PROVIDER TO MINIMIZE DURATION OF

UTILITY OUTAGES. 11. CONTRACTOR IS RESPONSIBLE FOR THE COORDINATION AND PLACEMENT OF ALL UTILITY CONDUITS AND ENCASEMENT. CONTRACTOR SHALL PROVIDE CONDUITS AND PULL STRINGS IN ACCORDANCE

WITH UTILITY PROVIDER REQUIREMENTS FOR THEIR RESPECTIVE CONDUITS. 12. USE EXTREME CAUTION WHEN WORKING AROUND EXISTING TREES TO REMAIN SO AS NOT TO DAMAGE THE TREES OR ROOT SYSTEMS.

13. CONTRACTOR SHALL PROTECT ALL AREAS BEYOND THE LIMITS OF DISTURBANCE AND SHALL RESTORE ANY AND ALL AREAS DISTURBED DURING CONSTRUCTION TO THEIR ORIGINAL OR BETTER CONDITION.

14. INFORMATION SHOWN ON THIS DRAWING HAS BEEN PROVIDED AS A GUIDE TO ASSIST THE CONTRACTOR IN ESTABLISHING THE LOCATIONS OF PROPOSED CONSTRUCTION WITH RESPECT TO EXISTING SITE IMPROVEMENTS. IT IS THE RESPONSIBILITY OF THE CONTRACTOR TO PROVIDE ALL CONSTRUCTION SURVEY STAKEOUT REQUIRED AND TO CONFIRM ALL INFORMATION SHOWN HEREON. 15. CONTRACTOR SHALL FURNISH SHORING, SHEATHING, OR OTHERWISE SUPPORT EXCAVATIONS TO PROTECT EXCAVATIONS FROM CAVE-INS UNTIL BACKFILL PLACEMENT IS COMPLETE PER SPECIFICATIONS.

16. SEE EXISTING CONDITIONS PLAN FOR SITE BENCHMARKS. CONTRACTOR SHALL BE RESPONSIBLE FOR ESTABLISHING AND MAINTAINING TEMPORARY BENCHMARKS THROUGHOUT THE DURATION OF THE PROJECT FOR CONSTRUCTION LAYOUT PURPOSES. 17. REFER TO THE SITE LANDSCAPING PLANS FOR ADDITIONAL INFORMATION AND DETAILS.

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18. REFER TO THE ELECTRICAL PLANS FOR ADDITIONAL ELECTRICAL UTILITY INFORMATION.

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		SCALE	E: 1"=20'	

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OWNER / DEVELOPER / APPLICANT: MARYLAND ZOO IN BALTIMORE 1876 MANSION HOUSE DRIVE BALTIMORE MD 21217 CONTACT: MR. KARL KRANZ PHONE: 443-552-3350

PROJECT TEAM: ARCHITECT: BUELL KRATZER POWELL, P.C. 1525 LOCUST STREET PHILADELPHIA, PA 19102 T: 215.557.6509 CIVIL ENGINEER: CARROLL ENGINEERING, INC 215 SCHILLING CIRCLE, STE 102 HUNT VALLEY, MD 21031 T: 410.785.7423 LANDSCAPE ARCHITECT:

ROBINSON ANDERSON SUMMERS 28 WEST STATE STREET MEDIA, PA 19063 T: 302.888.1544 STRUCTURAL ENGINEER:

BKP

STRUCTURAL DESIGN STUDIO, INC 2225 EAST MURRAY HOLLADAY RD SALT LAKE CITY, UT 84117 T: 801.274.3950

MEP ENGINEER: KOVACS, WHITNEY & ASSOCIATES 190 WEST OSTEND ST, STE 300 BALTIMORE, MD 21230 T: 410.244.7191

CLIENT: MARYLAND ZQO

THE MARYLAND ZOO IN BALTIMORE 1 SAFARI PLACE BALTIMORE, MD 21217

HIS DRAWING IS TO ILLUSTRATE THE WORK TO BE DONE. THE ARCHITECT IS NOT RESPONSIBLE FOR THE MEANS, METHODS, TECHNIQUES, SEQUENCES, AND PROCEDURES USED TO DO THE WORK OR THE SAFETY ASPECTS OF CONSTRUCTION, AND NOTHING ON THIS DRAWING EXPRESSED

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THESE CONDITIONS WILL BE FORTHCOMING.

SEAL:



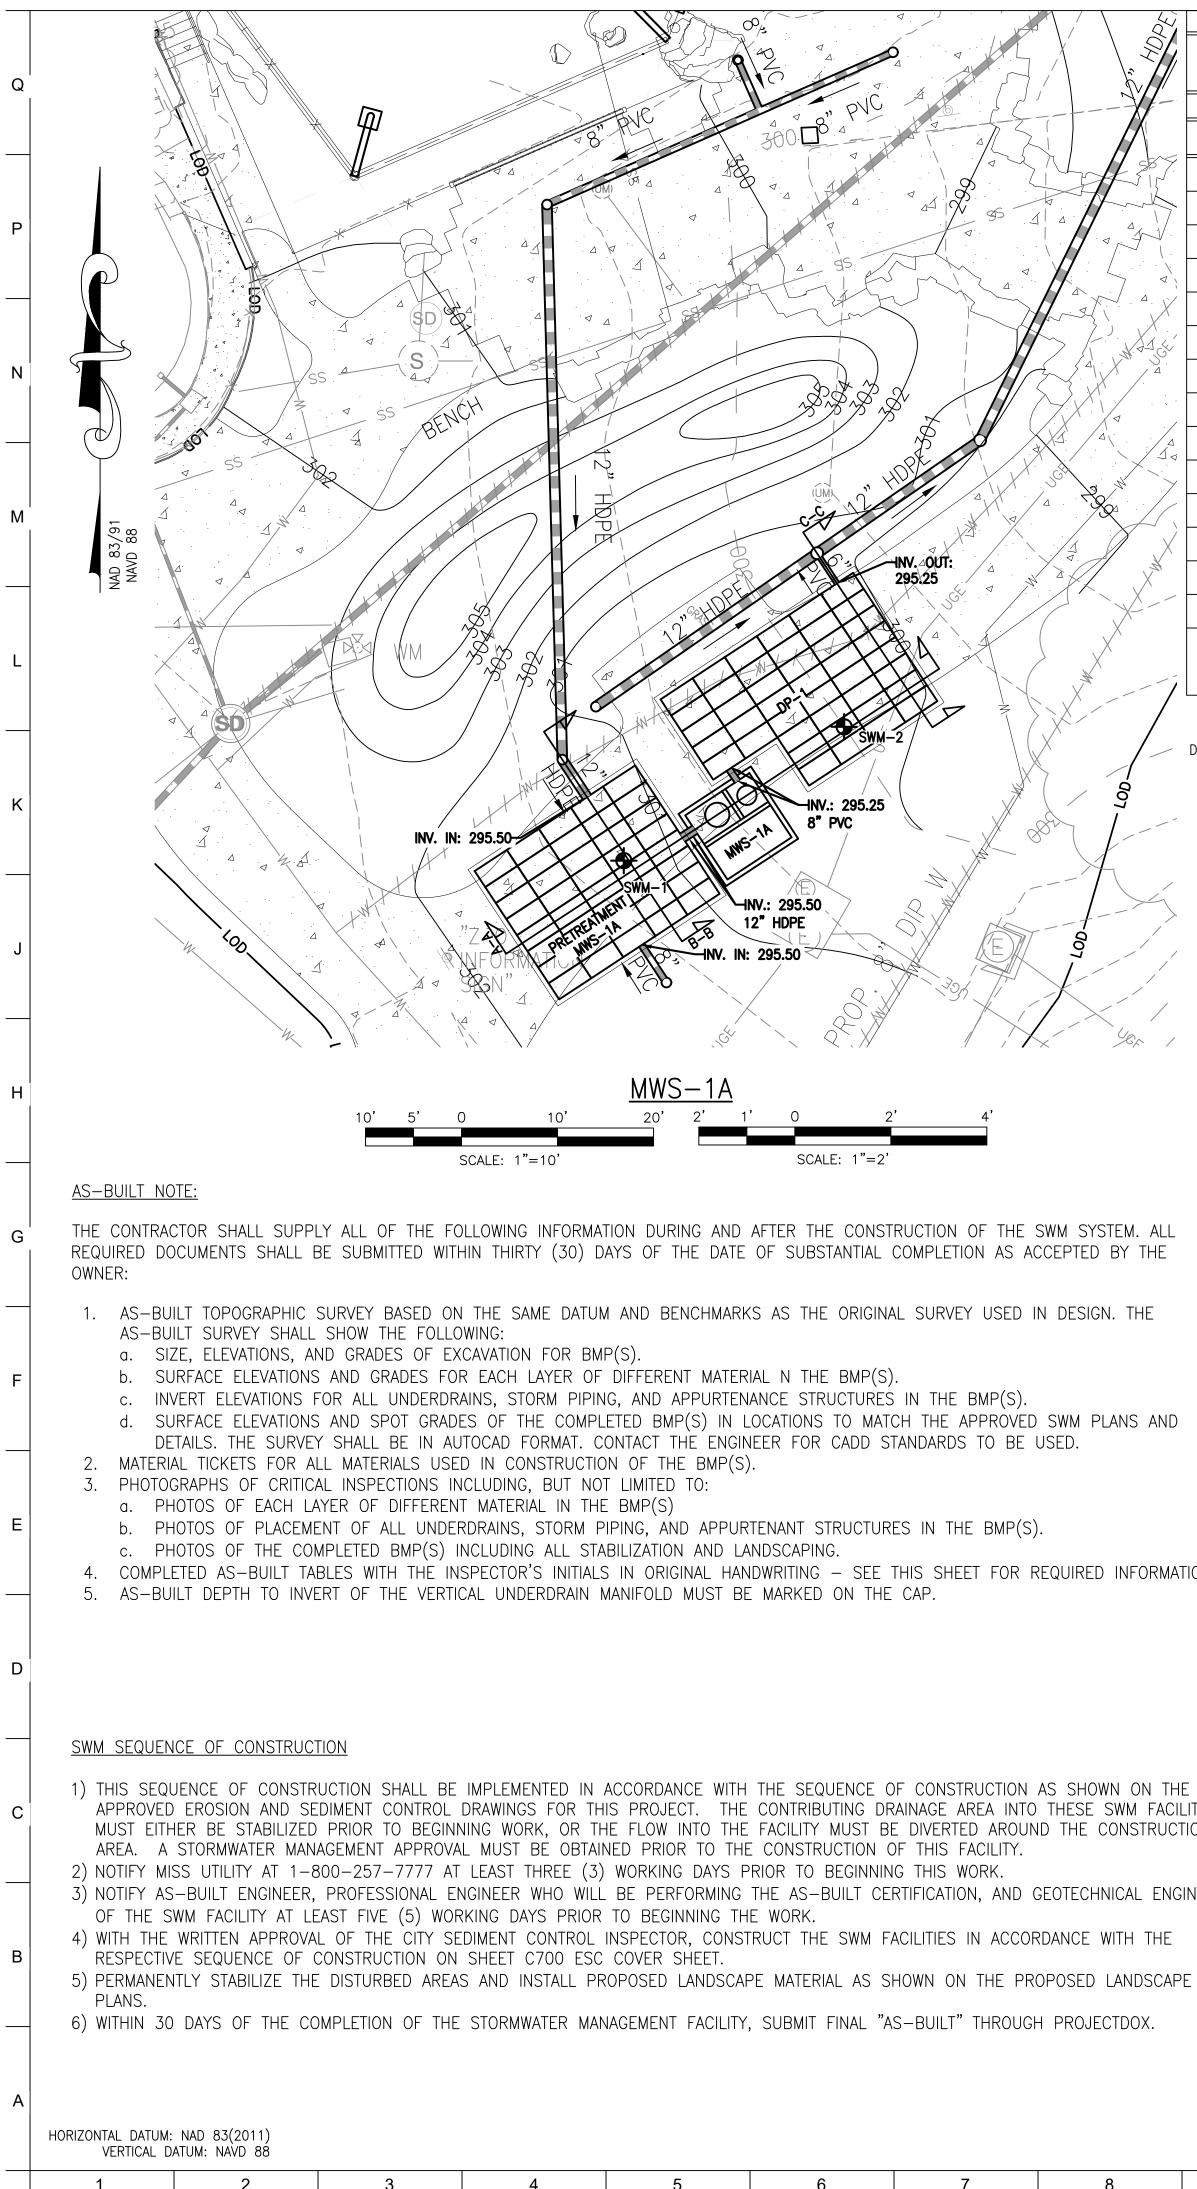
DATE: JANUARY 14, 202	5			
PROJECT NO: 2023-10.04				
DRAWN BY	MJE			
CHECKED BY	CMS			
SUBMISSION	DATE			
BID SET	01/14/2025			
REVISION	DATE			

DRAWING TITLE:

STORMWATER MANAGEMENT PLAN

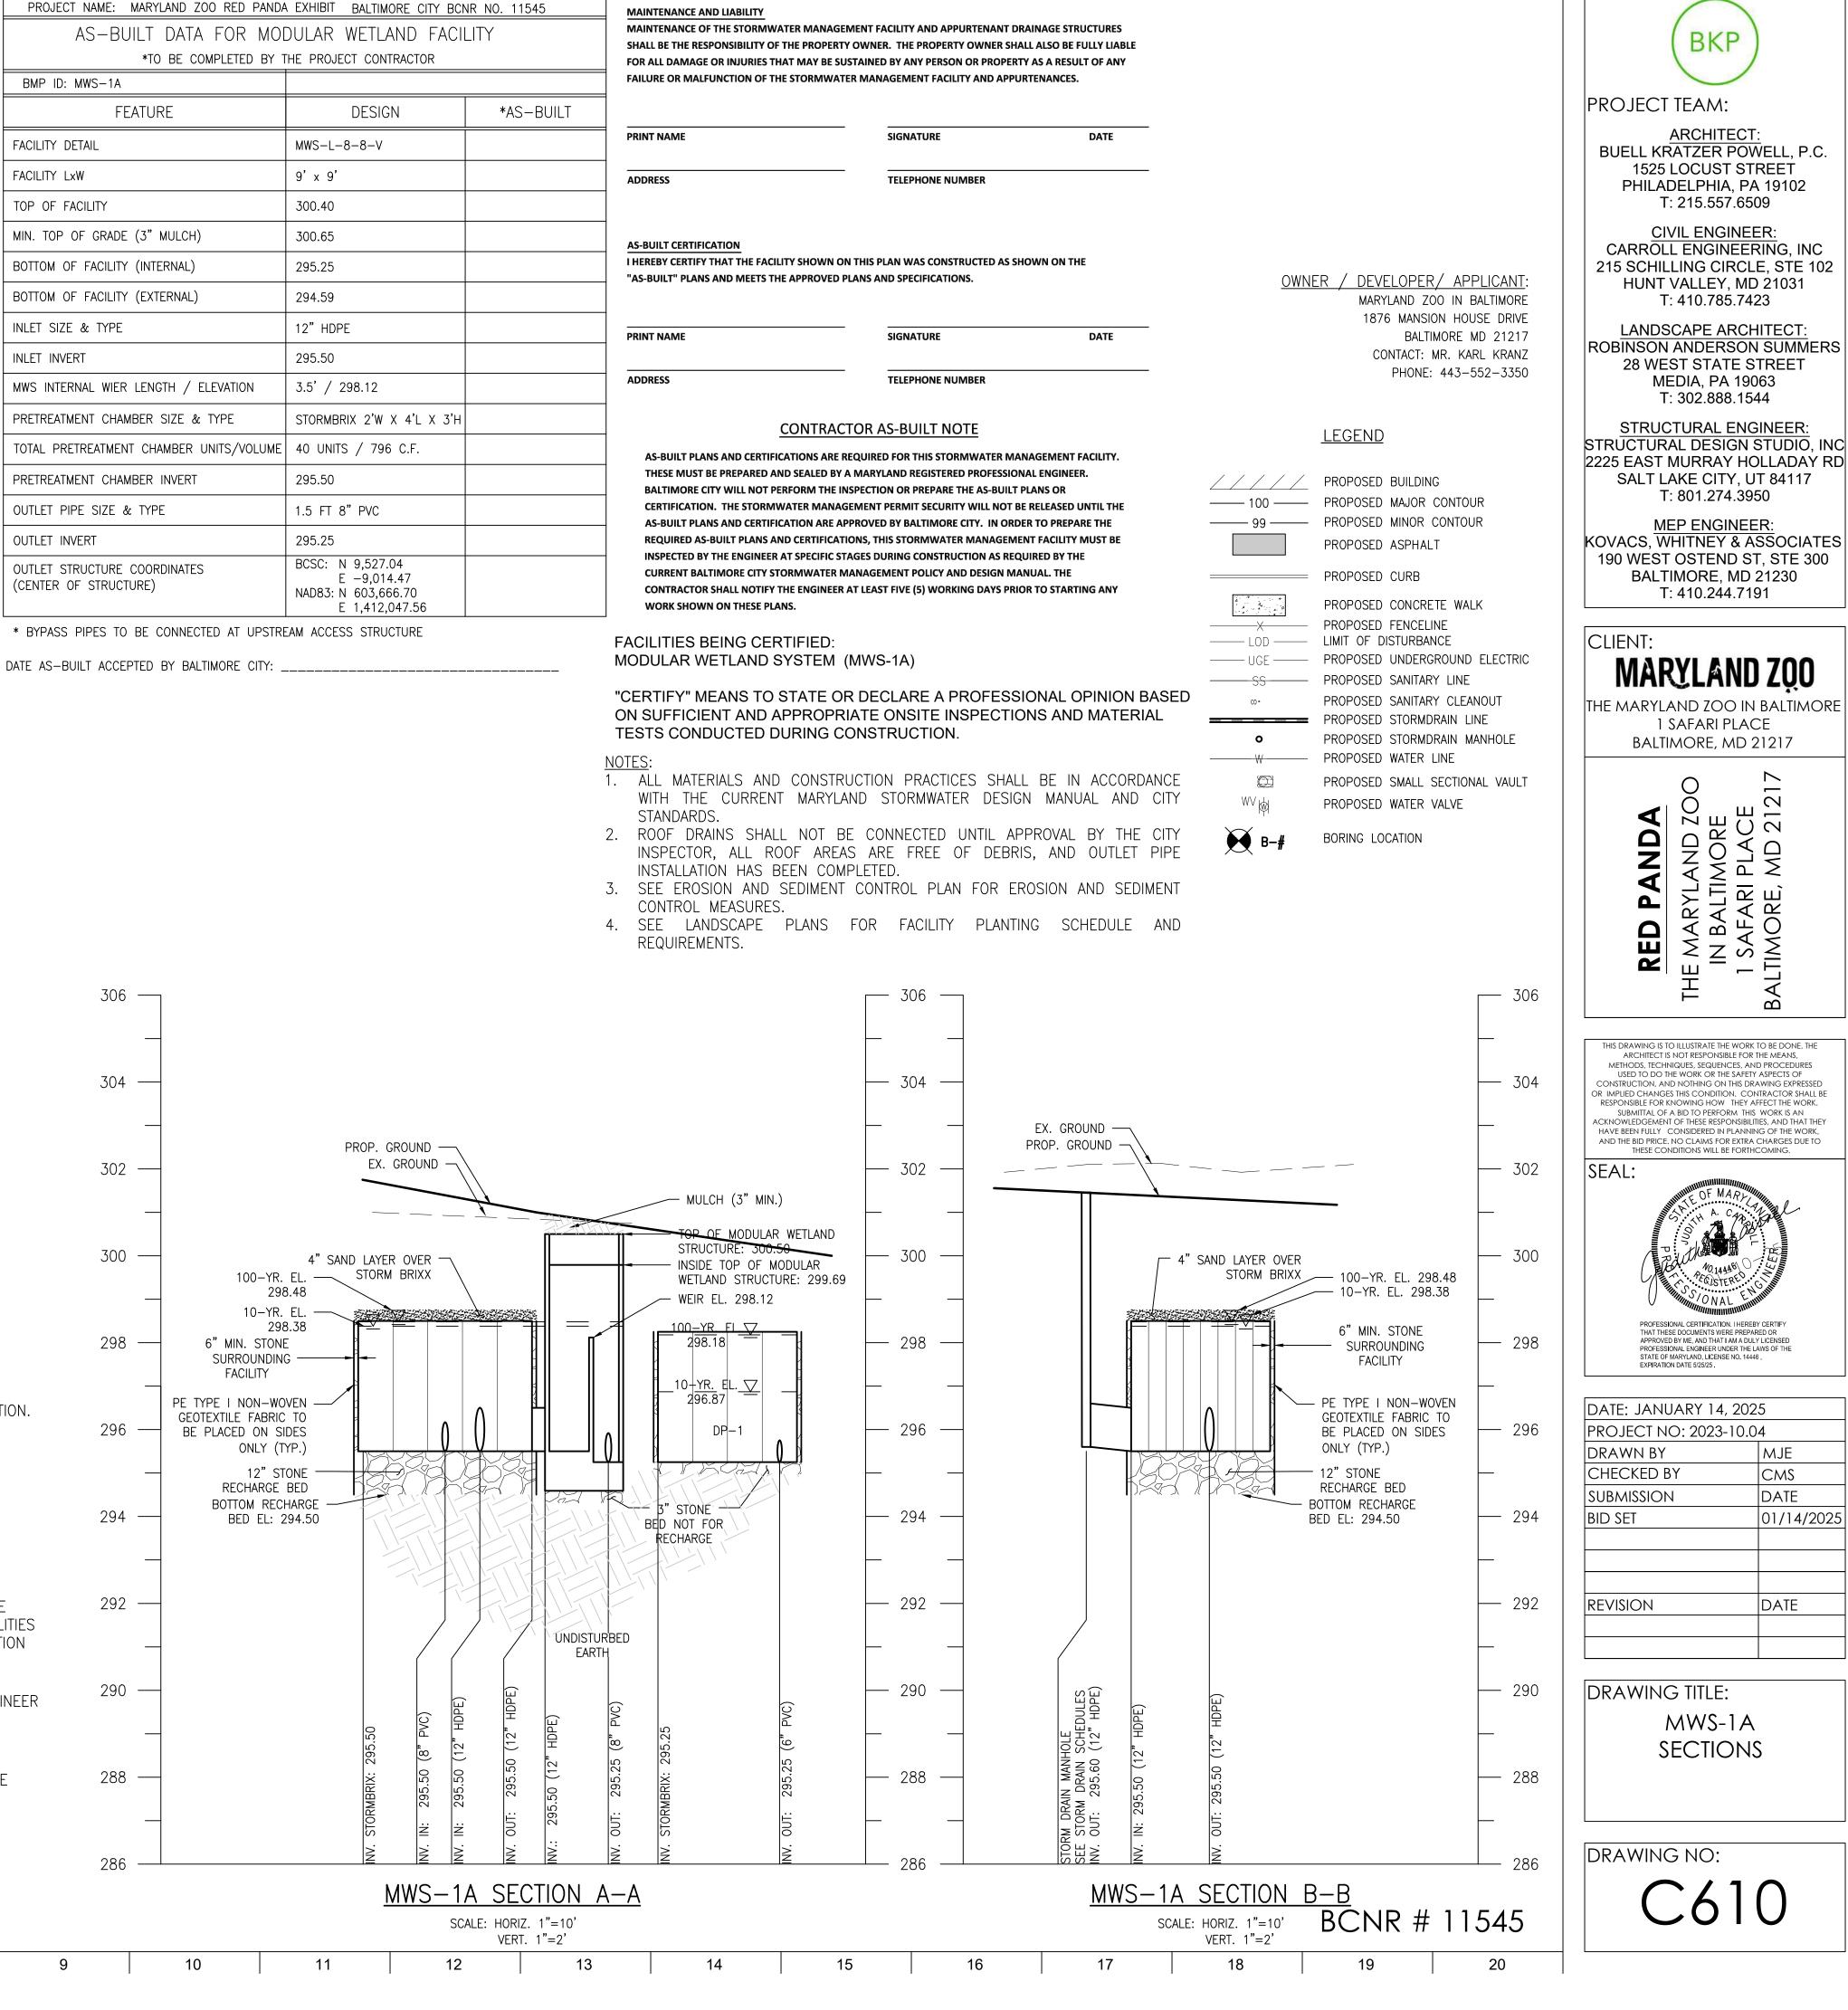
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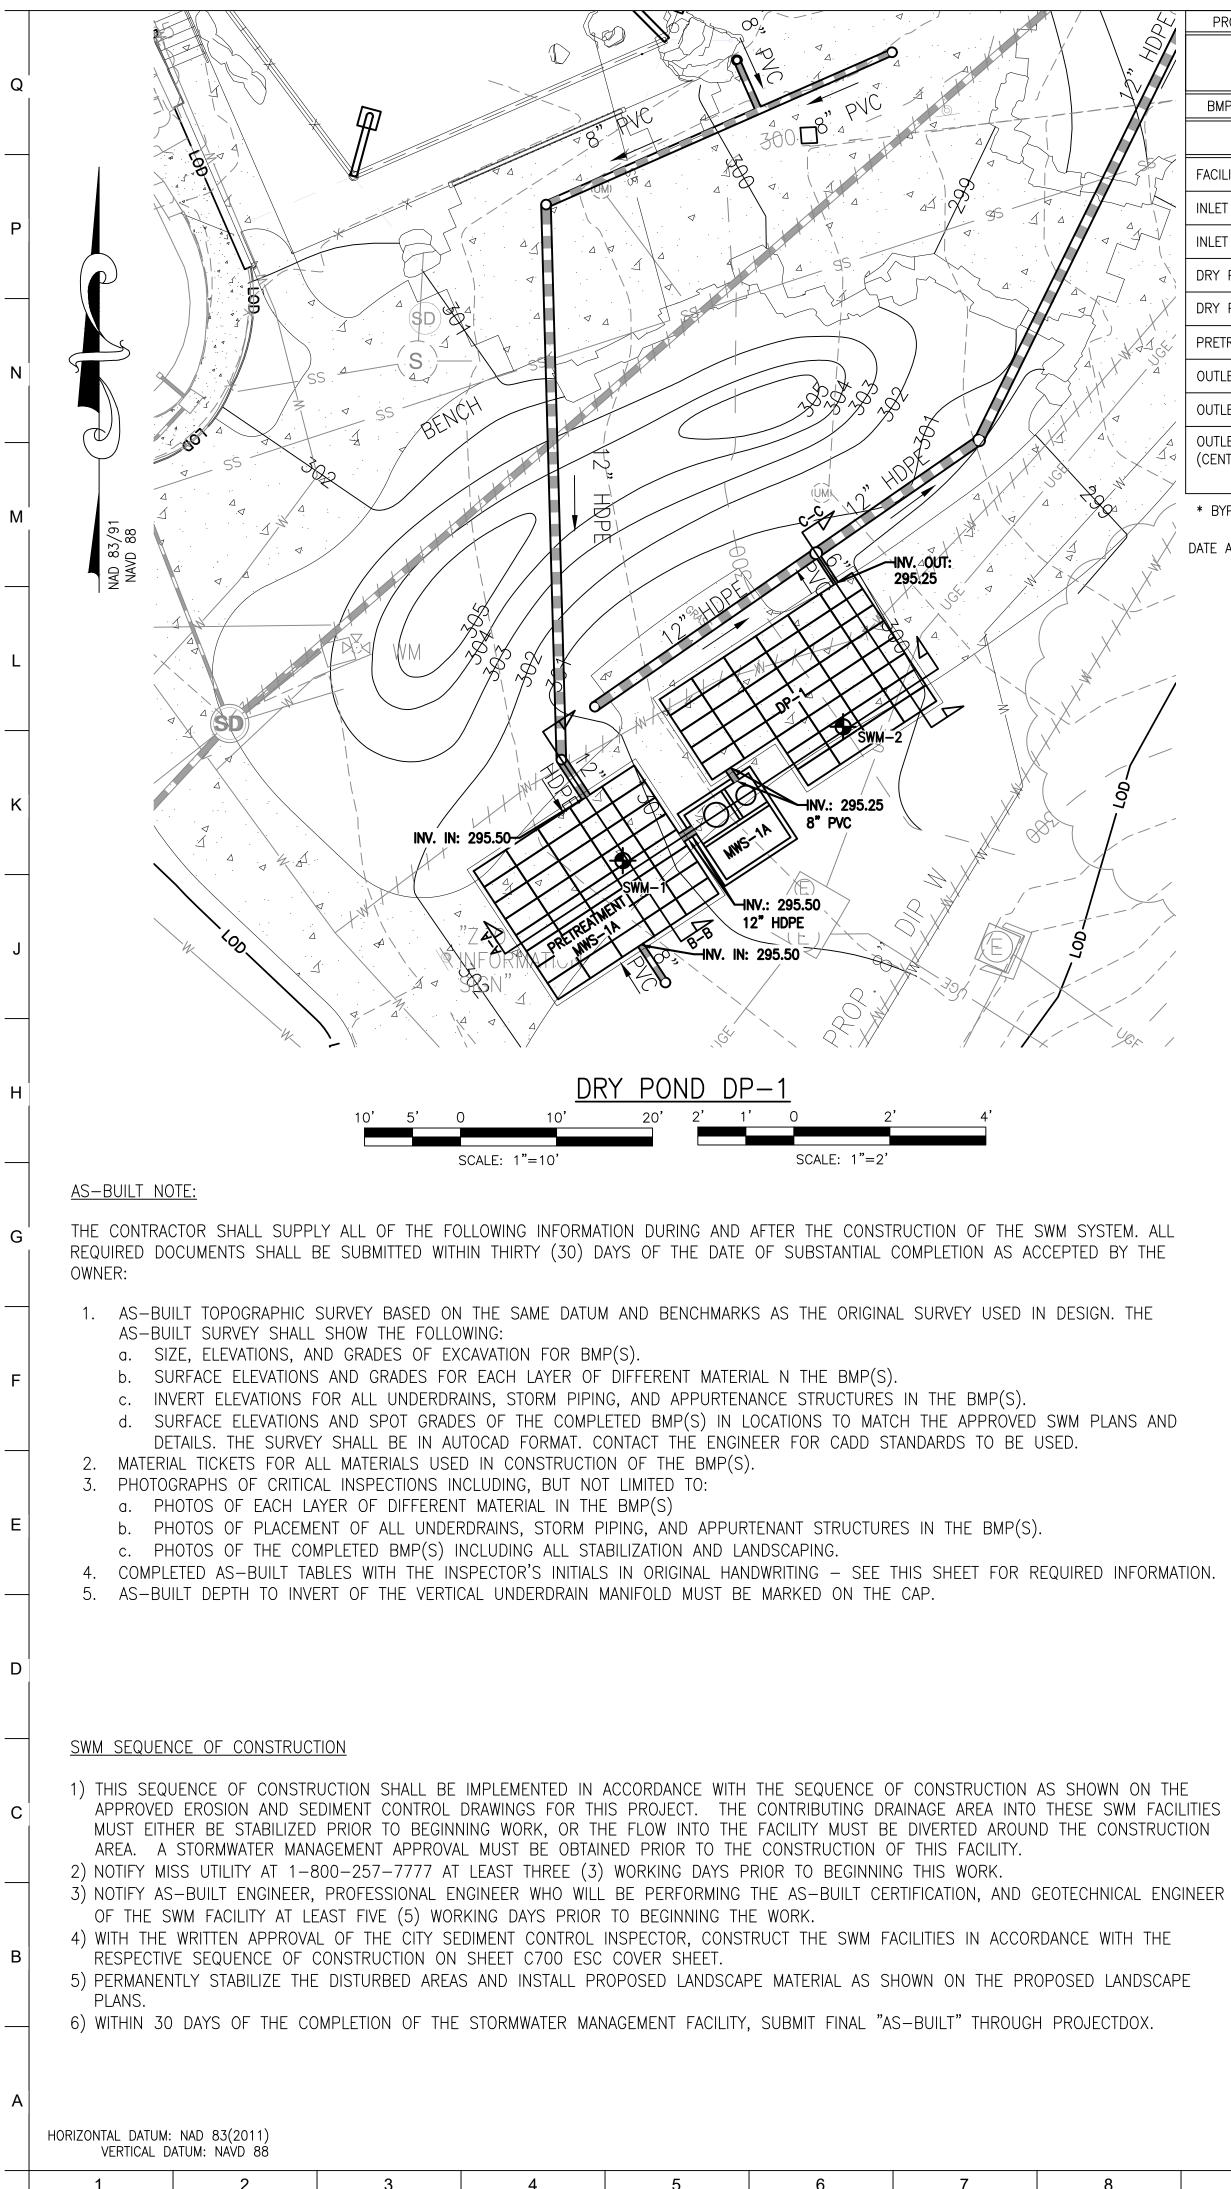


	PROJECT NAME: MARYLAND ZOO RED PANDA	EXHIBIT BALTIMORE CITY BCN	NR NO. 11545	MAINTENANCE AND LIABILITY
$\setminus \mathbb{Z}$	AS-BUILT DATA FOR MOL	DULAR WETLAND FACIL	LITY	MAINTENANCE OF THE STORMWATER MANAGEM
	*TO BE COMPLETED BY T	HE PROJECT CONTRACTOR		FOR ALL DAMAGE OR INJURIES THAT MAY BE SUST
	BMP ID: MWS-1A			FAILURE OR MALFUNCTION OF THE STORMWATER
	FEATURE	DESIGN	*AS-BUILT	
	FACILITY DETAIL	MWS-L-8-8-V		PRINT NAME
Think	FACILITY LxW	9' × 9'		ADDRESS
	TOP OF FACILITY	300.40		
	MIN. TOP OF GRADE (3" MULCH)	300.65		AS-BUILT CERTIFICATION
	BOTTOM OF FACILITY (INTERNAL)	295.25		I HEREBY CERTIFY THAT THE FACILITY SHOWN ON T "AS-BUILT" PLANS AND MEETS THE APPROVED PLA
- 1- 4-1- C+	BOTTOM OF FACILITY (EXTERNAL)	294.59		
	INLET SIZE & TYPE	12"HDPE		PRINT NAME
	INLET INVERT	295.50		
	MWS INTERNAL WIER LENGTH / ELEVATION	3.5' / 298.12		ADDRESS
A N Y	PRETREATMENT CHAMBER SIZE & TYPE	STORMBRIX 2'W X 4'L X 3'H		CONTRACT
The last	TOTAL PRETREATMENT CHAMBER UNITS/VOLUME	40 UNITS / 796 C.F.		AS-BUILT PLANS AND CERTIFICATIONS ARE REC
	PRETREATMENT CHAMBER INVERT	295.50		THESE MUST BE PREPARED AND SEALED BY A I BALTIMORE CITY WILL NOT PERFORM THE INSI
	OUTLET PIPE SIZE & TYPE	1.5 FT 8" PVC		CERTIFICATION. THE STORMWATER MANAGE

- STANDARDS
- INSTALLATION HAS BEEN COMPLETED.
- CONTROL MEASURES.
- REQUIREMENTS.

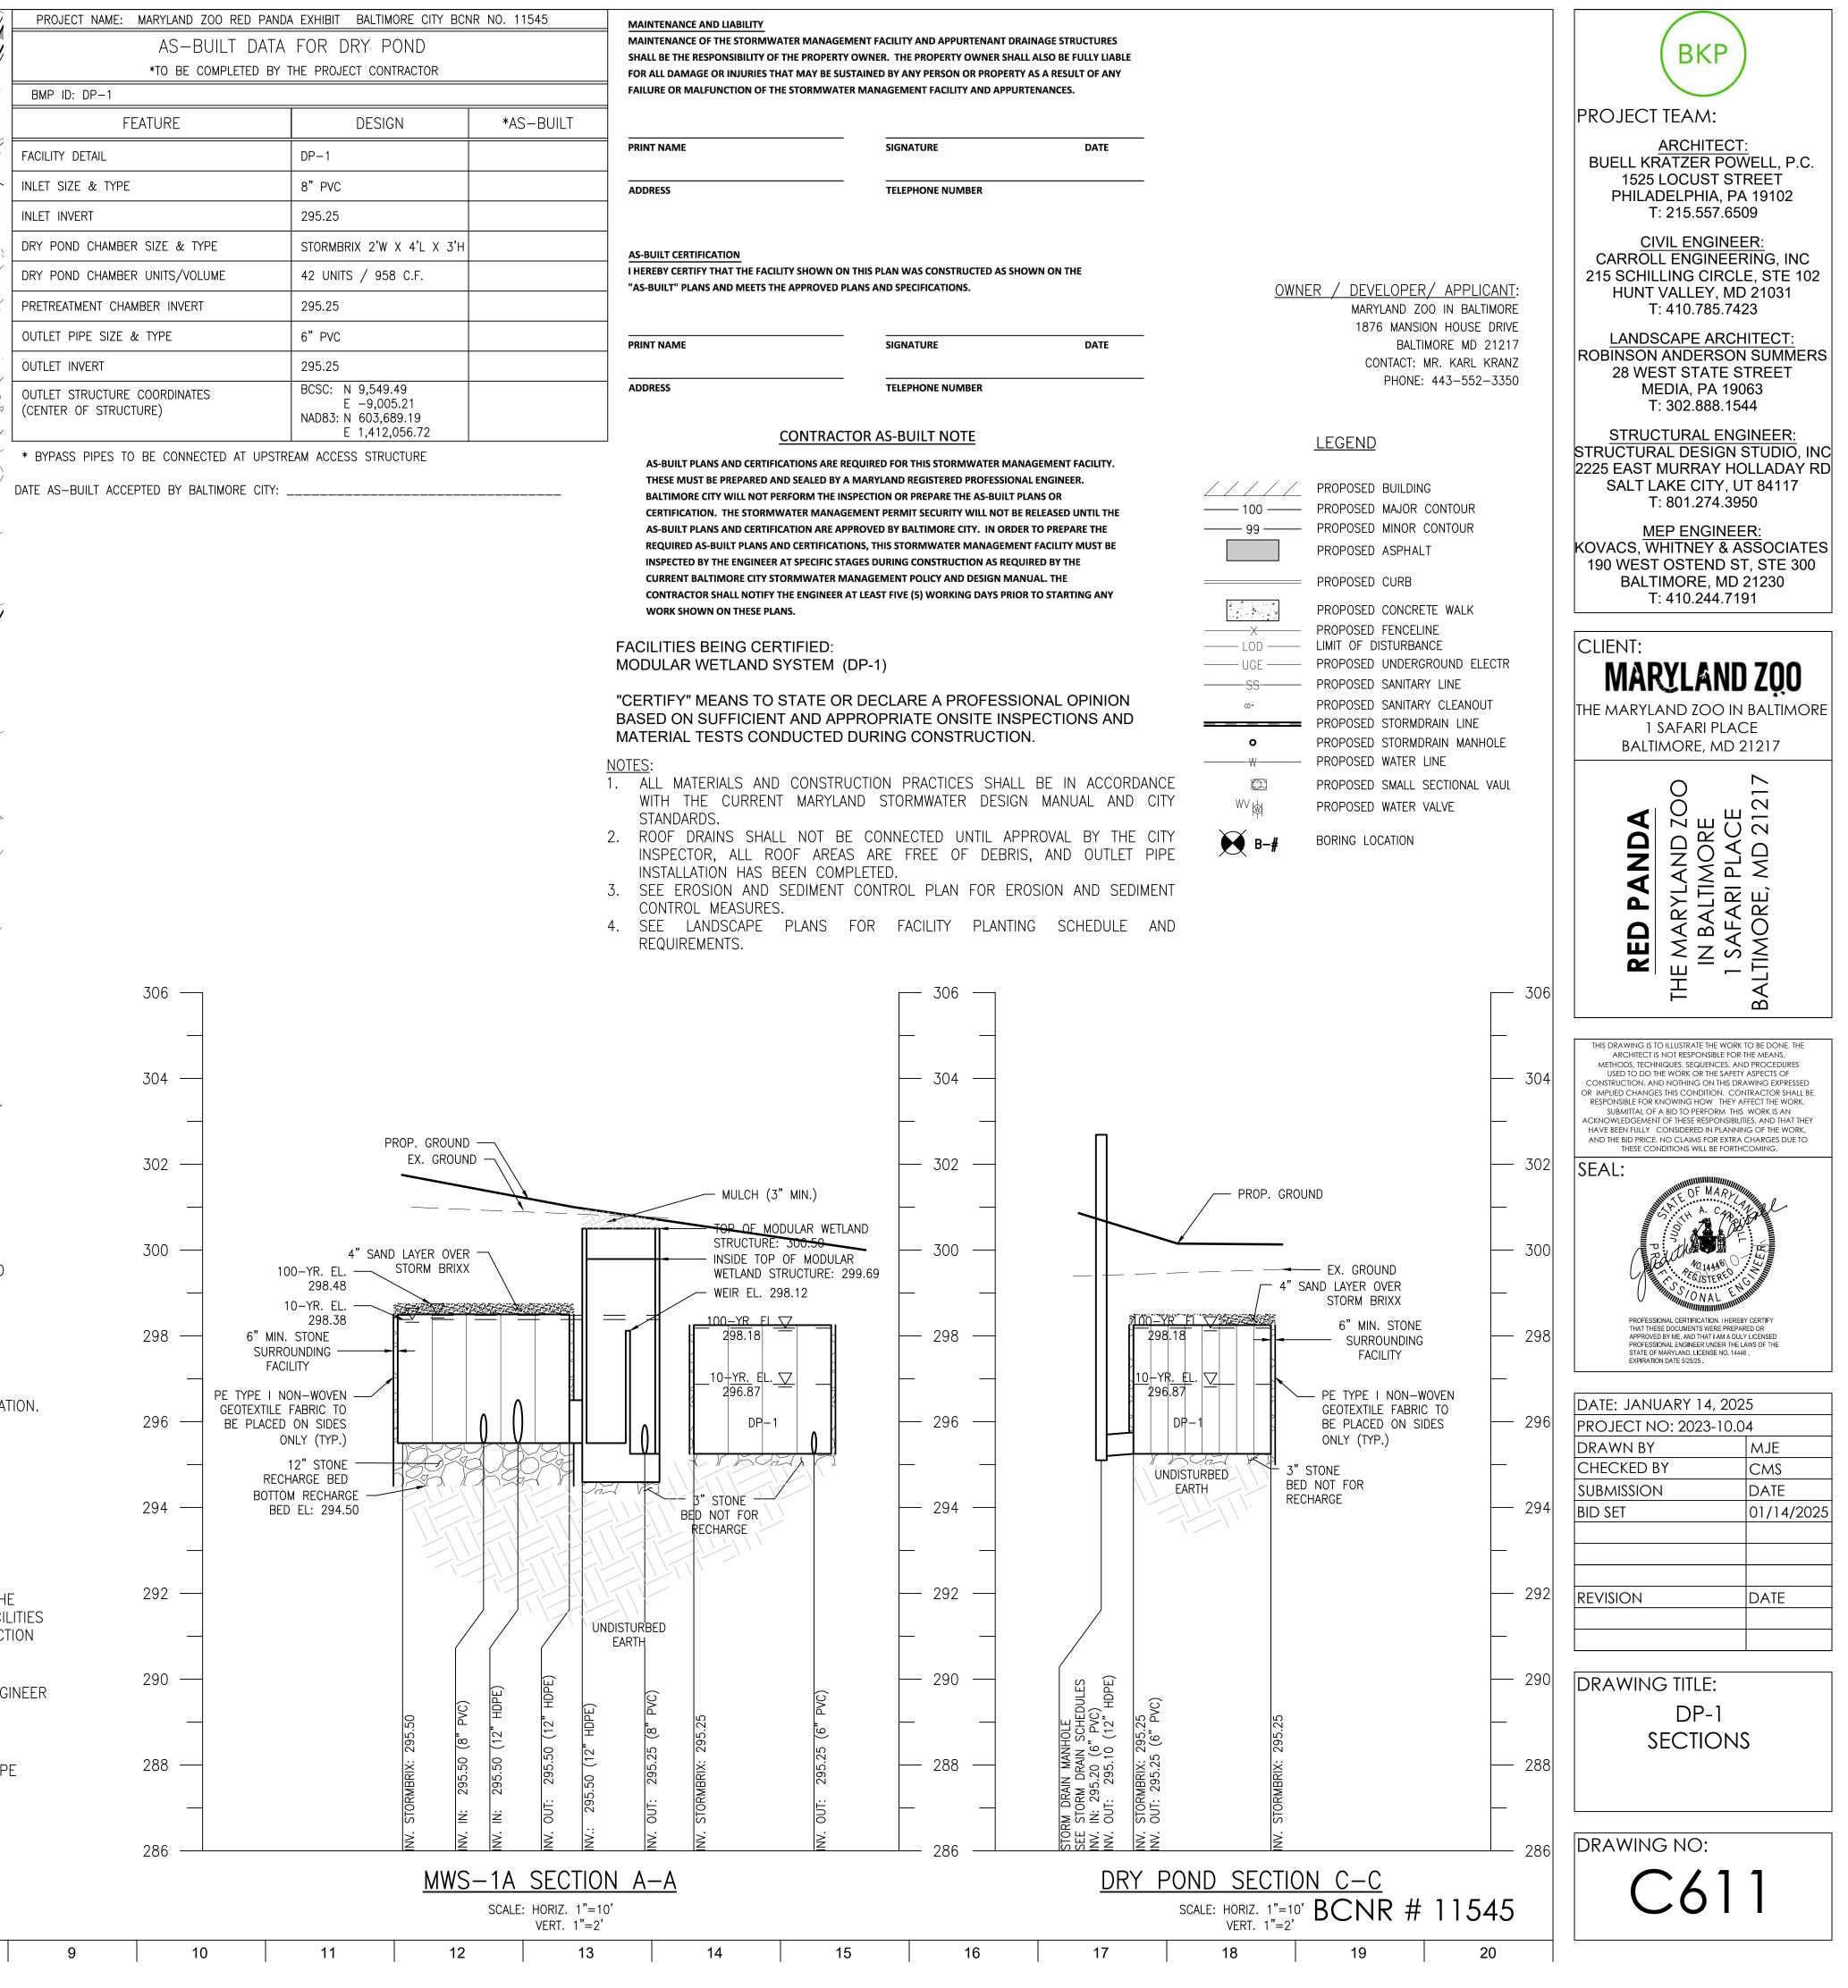


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ED SWM PLANS AND E USED.
S). REQUIRED INFORMATION.
N AS SHOWN ON THE TO THESE SWM FACILITIES JND THE CONSTRUCTION
GEOTECHNICAL ENGINEER
ORDANCE WITH THE
PODOSED LANDSCADE

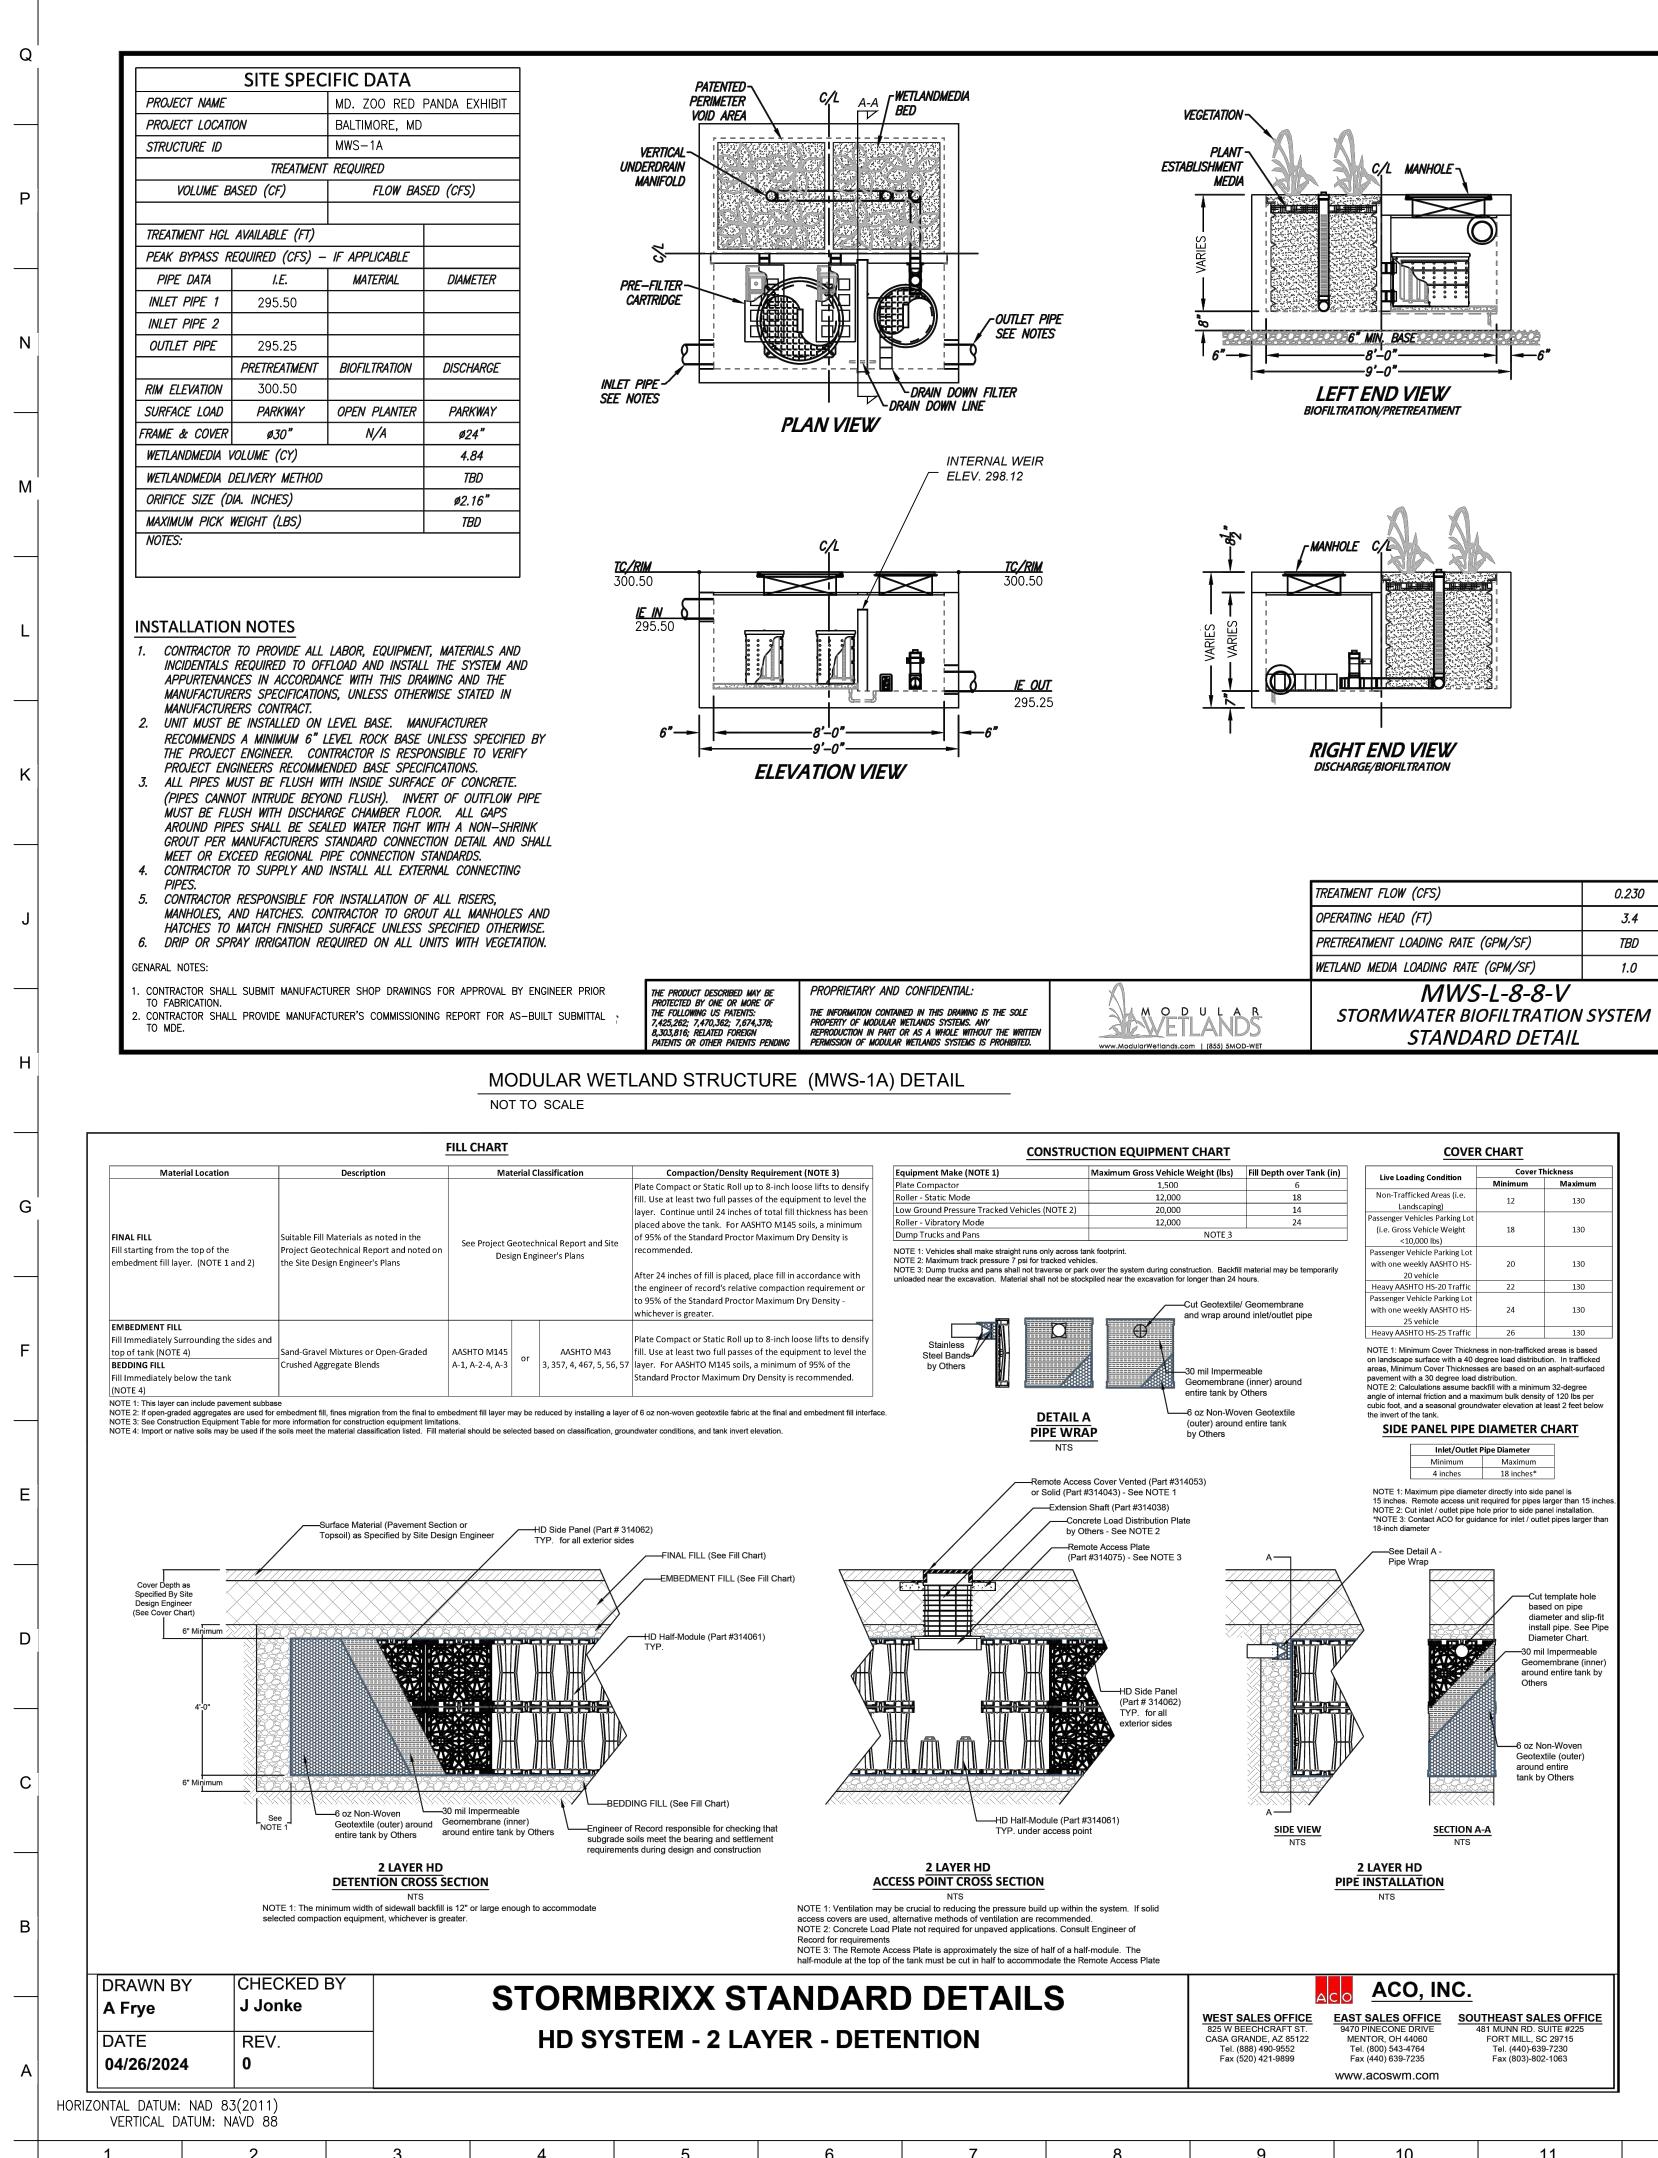


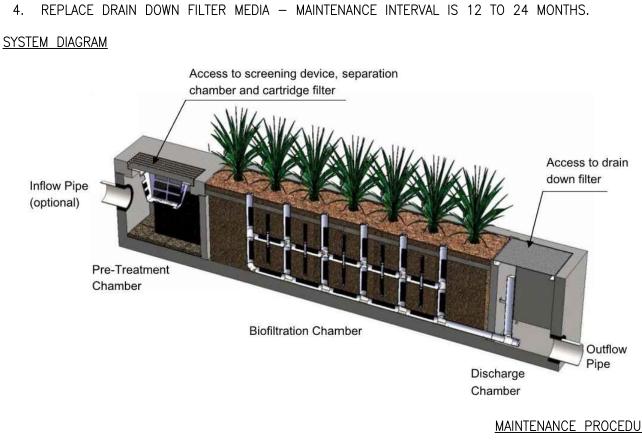
q	PROJECT NAME: MARYLAND ZOO RED P	ANDA EXHIBIT BALTIMORE CITY BCNF	R NO. 11545	MAINTENANCE AND LIABILITY	
		TA FOR DRY POND by the project contractor		MAINTENANCE OF THE STORMWATER SHALL BE THE RESPONSIBILITY OF THE FOR ALL DAMAGE OR INJURIES THAT I	PROPERTY OWNER. THE
¥[BMP ID: DP-1			FAILURE OR MALFUNCTION OF THE ST	
X	FEATURE	DESIGN	*AS-BUILT	=	
SBY.	FACILITY DETAIL	DP-1		PRINT NAME	SIGNA
-th	INLET SIZE & TYPE	8" PVC		ADDRESS	TELEP
	INLET INVERT	295.25			
	DRY POND CHAMBER SIZE & TYPE	STORMBRIX 2'W X 4'L X 3'H		AS-BUILT CERTIFICATION	
	DRY POND CHAMBER UNITS/VOLUME	42 UNITS / 958 C.F.		I HEREBY CERTIFY THAT THE FACILITY S	
AA GE	PRETREATMENT CHAMBER INVERT	295.25			
	OUTLET PIPE SIZE & TYPE	6" PVC		PRINT NAME	SIGNA
· · ·	OUTLET INVERT	295.25			
	OUTLET STRUCTURE COORDINATES (CENTER OF STRUCTURE)	BCSC: N 9,549.49 E -9,005.21 NAD83: N 603,689.19 E 1,412,056.72		ADDRESS	TELEP
/					

- STANDARDS
- INSTALLATION HAS BEEN COMPLETED.
- CONTROL MEASURES.
- REQUIREMENTS.



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SCREENING DEVICE

- MAINTENANCE CAN BE PERFORMED WITHOUT ENTRY.

INSPECTION AND MAINTENANCE SCHEDULE - MODULAR WETLAND SYSTEM

- TRUCK WILL NOT DAMAGE THE SCREENING DEVICE.
- OR MANHOLE COVER WHEN COMPLETED.

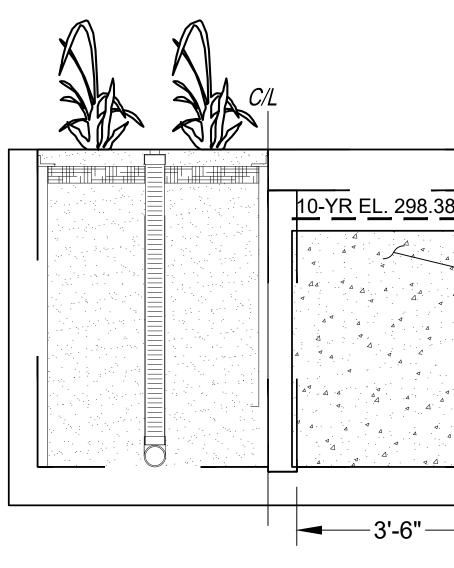
SEPARATION CHAMBER

- PERFORM MAINTENANCE PROCEDURES OF SCREENING DEVICE LISTED ABOVE BEFORE MAINTAINING THE SEPARATION CHAMBER. WITH A PRESSURE WASHER, SPRAY DOWN POLLUTANTS ACCUMULATED ON WALLS AND CARTRIDGE FILTERS.
- CARTRIDGE FILTERS
- PERFORM MAINTENANCE PROCEDURES ON SCREENING DEVICE AND SEPARATION CHAMBER BEFORE MAINTAINING CARTRIDGE FILTERS. ENTER SEPARATION CHAMBER.
- UNSCREW THE TWO BOLTS HOLDING THE LID ON EACH CARTRIDGE FILTER AND REMOVE LID.
- REMOVE EACH OF 4 TO 8 MEDIA CAGES HOLDING THE MEDIA IN PLACE. SPRAY DOWN THE CARTRIDGE FILTER TO REMOVE ANY ACCUMULATED POLLUTANTS.
- VACUUM OUT OLD MEDIA AND ACCUMULATED POLLUTANTS.
- PURCHASE 8. REPLACE THE LID AND TIGHTEN DOWN BOLTS. REPLACE SCREENING DEVICE, GRATE OR MANHOLE COVER WHEN COMPLETED.
- DRAIN DOWN FILTER 1. REMOVE HATCH OF MANHOLE COVER OVER DISCHARGE CHAMBER AND ENTER CHAMBER.
- PI ACF 3. EXIT CHAMBER AND REPLACE HATCH OR MANHOLE COVER.

- AVAILABLE TO THE GOVERNING MUNICIPALITY FOR INSPECTION UPON REQUEST AT ANY TIME.
- ENTRY INTO CHAMBERS MAY REQUIRE CONFINED SPACE TRAINING BASED ON STATE AND LOCAL REGULATIONS.
- NO FERTILIZER SHALL BE USED IN THE BIOFILTRATION CHAMBER.
- SPECIES. SOME PLANTS MAY REQUIRE IRRIGATION.

MEDIA MATERIAL SPECIFICATION FOR MODULAR WETLANDS:

MEDIA SHALL CONSIST OF CERAMIC MATERIAL PRODUCED BY EXPANDING AND VITRIFYING SELECT MATERIAL IN A ROTARY KILN. MEDIA MUST BE PRODUCED TO MEET THE REQUIREMENTS OF ASTM C330, ASTM C331, AND AASHTO M195. AGGREGATES MUST HAVE A MINIMUM 24-HOUR WATER ABSORPTION OF 10.5% MASS. MEDIA SHALL NOT CONTAIN ANY ORGANIC MATERIAL. FLOW THROUGH MEDIA SHALL BE HORIZONTAL FROM THE OUTER PERIMETER OF THE CHAMBER TOWARD THE CENTRALIZED AND VERTICALLY EXTENDING UNDERDRAIN. THE RETENTION TIME IN THE MEDIA SHALL BE AT LEAST 3 MINUTES. DOWNWARD FLOW FILTERS ARE NOT ACCEPTABLE ALTERNATIVES. THE THICKNESS OF THE MEDIA SHALL BE AT LEAST 19" FROM INFLUENT END TO EFFLUENT END. THE LOADING RATE ON THE MEDIA SHALL NOT EXCEED 1.1 GALLONS PER MINUTE PER SQUARE FOOT SURFACE. AREA. MEDIA MUST BE CONTAINED WITHIN STRUCTURE THAT SPACES THE SURFACE OF THE MEDIA AT LEAST 2" FROM ALL VERTICALLY EXTENDING WALLS OF THE CONCRETE STRUCTURE. MEDIA MUST BE CONTAINED WITHIN STRUCTURE THAT SPACES THE SURFACE OF THE MEDIA AT LEAST 2" FROM ALL VERTICALLY EXTENDING WALLS OF THE CONCRETE. STRUCTURE. MEDIA SHALL BE PROPRIETARY MEDIA FROM MODULAR WETLAND SYSTEM MANUFACTURER OR APPROVED EQUAL.



MODULAR WETLAND SE

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12 10 11 13 14 15

REMOVE TRASH FROM SCREENING DEVICE - MAINTENANCE INTERVAL IS 6 TO 12 MONTHS. REMOVE SEDIMENT FROM SEPARATION CHAMBER - MAINTENANCE INTERVAL IS 12 TO 24 MONTHS. REPLACE CARTRIDGE FILTER MEDIA - MAINTENANCE INTERVAL IS 12 TO 24 MONTHS.

> <u>OWNER / DEVELOPER/ APPLICANT</u>: MARYLAND ZOO IN BALTIMORE 1876 MANSION HOUSE DRIVE BALTIMORE MD 21217 CONTACT: MR. KARL KRANZ PHONE: 443-552-3350

MAINTENANCE PROCEDURES

1. REMOVE GRATE OR MANHOLE COVER TO GAIN ACCESS TO THE SCREENING DEVICE IN THE PRE-TREATMENT CHAMBER. VAULT TYPE UNITS DO NOT HAVE SCREENING DEVICE. REMOVE ALL POLLUTANTS COLLECTED BY THE SCREENING DEVICE. REMOVAL CAN BE DONE MANUALLY OR WITH THE USE OF A VACUUM TRUCK. THE HOSE OF THE VACUUM 3. SCREENING DEVICE CAN EASILY BE REMOVED FROM THE PRE-TREATMENT CHAMBER TO GAIN ACCESS TO SEPARATION CHAMBER AND MEDIA FILTERS BELOW. REPLACE GRATE

VACUUM OUT SEPARATION CHAMBER AND REMOVE ALL ACCUMULATED POLLUTANTS. REPLACE SCREENING DEVICE, GRATE OR MANHOLE COVER WHEN COMPLETED.

REINSTALL MEDIA CAGES AND FILL WITH NEW MEDIA FROM MANUFACTURER OR OUTSIDE SUPPLIER. MANUFACTURER WILL PROVIDE SPECIFICATION OF MEDIA AND SOURCES TO

2. UNLOCK AND LIFT DRAIN DOWN FILTER HOUSING AND REMOVE OLD MEDIA BLOCK. REPLACE WITH NEW MEDIA BLOCK. LOWER DRAIN DOWN FILTER HOUSING AND LOCK INTO

MAINTENANCE NOTES

1. FOLLOWING MAINTENANCE AND/OR INSPECTION, IT IS RECOMMENDED THE MAINTENANCE OPERATOR PREPARE A MAINTENANCE/INSPECTION RECORD. THE RECORD SHOULD INCLUDE ANY MAINTENANCE ACTIVITIES PERFORMED, AMOUNT AND DESCRIPTION OF DEBRIS COLLECTED, AND CONDITION OF THE SYSTEM AND ITS VARIOUS FILTER MECHANISMS. 2. THE OWNER SHOULD KEEP MAINTENANCE/INSPECTION RECORD(S) FOR A MINIMUM OF FIVE YEARS FROM THE DATE OF MAINTENANCE. THESE RECORDS SHOULD BE MADE TRANSPORT ALL DEBRIS, TRASH, ORGANICS AND SEDIMENTS TO AN APPROVED FACILITY FOR DISPOSAL IN ACCORDANCE WITH LOCAL AND STATE REQUIREMENTS.

6. IRRIGATION SHOULD BE PROVIDED AS RECOMMENDED BY THE MANUFACTURER AND/OR LANDSCAPE ARCHITECT. THE AMOUNT OF IRRIGATION REQUIRED IS DEPENDENT ON PLANT

	WEIR TOP 298.12 — BYPASS OVERFLOW WEIR	
	WEIR BOTTOM 295.25	
CTION A-	<u>–A</u>	BCNR # 1

T: 302.888.1544 STRUCTURAL ENGINEER: STRUCTURAL DESIGN STUDIO, INC 2225 EAST MURRAY HOLLADAY RD SALT LAKE CITY, UT 84117 T: 801.274.3950 MEP ENGINEER: KOVACS, WHITNEY & ASSOCIATES 190 WEST OSTEND ST, STE 300 BALTIMORE, MD 21230 T: 410.244.7191 CLIENT: MARYLAND ZQO THE MARYLAND ZOO IN BALTIMORE 1 SAFARI PLACE BALTIMORE, MD 21217 \sim \bigcirc \sim Ο Z U K K ш ARYLAND Z ALTIMORE FARI PLAC DRE, MD 2 Ζ Δ AFA AOR ₹ Å [⊥] Ž Z S × ш 2 ш m HIS DRAWING IS TO ILLUSTRATE THE WORK TO BE DONE. THE ARCHITECT IS NOT RESPONSIBLE FOR THE MEANS. METHODS, TECHNIQUES, SEQUENCES, AND PROCEDURES USED TO DO THE WORK OR THE SAFETY ASPECTS OF CONSTRUCTION, AND NOTHING ON THIS DRAWING EXPRESSED R IMPLIED CHANGES THIS CONDITION. CONTRACTOR SHALL BE RESPONSIBLE FOR KNOWING HOW THEY AFFECT THE WORK SUBMITTAL OF A BID TO PERFORM THIS WORK IS AN ACKNOWLEDGEMENT OF THESE RESPONSIBILITIES, AND THAT THEY HAVE BEEN FULLY CONSIDERED IN PLANNING OF THE WORK AND THE BID PRICE. NO CLAIMS FOR EXTRA CHARGES DUE TO THESE CONDITIONS WILL BE FORTHCOMING SEAL: PROFESSIONAL CERTIFICATION. I HEREBY CERTIF T THESE DOCUMENTS WERE PREPARED O APPROVED BY ME, AND THAT I AM A DULY LICENSI PROFESSIONAL ENGINEER UNDER THE LAWS OF THE STATE OF MARYLAND, LICENSE NO. 14446 , EXPIRATION DATE 5/25/25 . DATE: JANUARY 14, 2025 PROJECT NO: 2023-10.04 DRAWN BY MJE CHECKED BY CMS DATE SUBMISSION BID SET 01/14/2025 DATE REVISION DRAWING TITLE: SWM DETAILS

BKP

ARCHITECT:

BUELL KRATZER POWELL, P.C.

1525 LOCUST STREET

PHILADELPHIA, PA 19102

T: 215.557.6509

CIVIL ENGINEER:

CARROLL ENGINEERING, INC 215 SCHILLING CIRCLE, STE 102

HUNT VALLEY, MD 21031

T: 410.785.7423

LANDSCAPE ARCHITECT:

ROBINSON ANDERSON SUMMERS

28 WEST STATE STREET

MEDIA, PA 19063

PROJECT TEAM:

DRAWING NO:

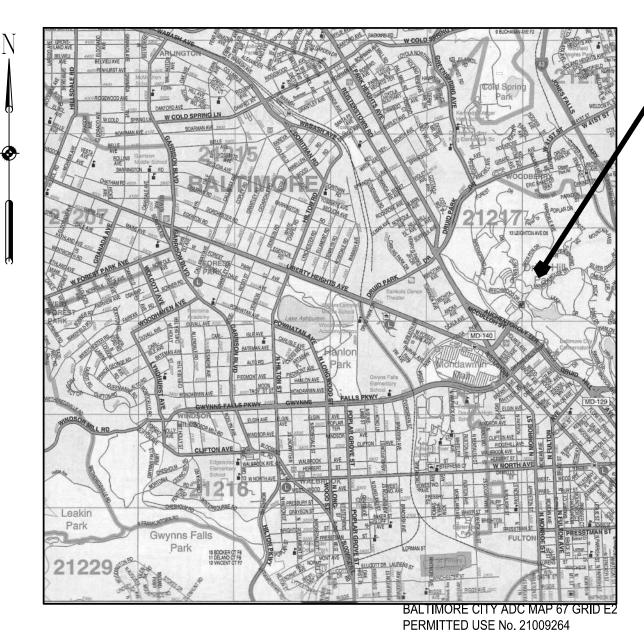


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MARYLAND ZOO RED PANDA EXHIBIT ION AND SEDIMENT CONTROL 1 SAFARI PLACE BALTIMORE, MARYLAND SEQUENCE OF CONSTRUCTION BCNR # 11545



VICINITY MAP SCALE: 1"=2000'

LIANCE WITH THE REQUIREMENTS

MANENT OR TEMPORARY

ALL PERIMETER DIKES, SWALES, HAN 3 HORIZONTAL TO 1

BED OR GRADED AREAS ON THE

SHALL MAINTAIN THE SITE IN A REMOVE STONE AND/OR VACUUMING, SCRAPING, QUIPMENT PRIOR TO LEAVING T AND SUFACES TO REMOVE IS DIRECTED TO AN APPROVED

D. FAILURE TO MAINTAIN ACCEPTABLE'

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DAILY STABILIZATION NOTE:

CONTRACTOR SHALL ONLY DISTURB THAT AREA WHICH CAN BE COMPLETED AND STABILIZED BY THE END OF EACH WORKING DAY. STABILIZATION SHALL BE AS FOLLOWS: 1. FOR AREAS TO BE PAVED, THE APPLICATION OF BASE STONE.

2. FOR AREAS TO BE VEGETATIVELY STABILIZED;

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2.a. PERMANENT SEED AND SOIL STABILIZATION MATTING OR SOD FOR STEEP SLOPES, CHANNELS OR SWALES.

2.b. PERMANENT SEED AND MULCH FOR ALL OTHER AREAS.

ANY AREAS WHICH CAN NOT BE STABILIZED BY THE END OF EACH WORKING DAY MUST HAVE SILT FENCE INSTALLED ON THE DOWNSLOPE SIDE.

MAINTENANCE NOTE:

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CONTRACTOR SHALL INSPECT AND MAINTAIN ALL SEDIMENT CONTROL MEASURES AND DEVICES AFTER EVERY STORM EVENT. MAINTENANCE SHALL INCLUDE, BUT NOT LIMITED TO THE REMOVAL OF ALL ACCUMULATED SEDIMENT. GEOTEXTILE FABRIC SHALL BE REPLACED AS NEEDED TO ENSURE PROPER FUNCTION.

SEDIMENT CONTROL NOTE:

SEDIMENT CONTROLS ARE OFFSET FROM THE LIMIT OF DISTURBANCE (LOD) FOR VISUAL CLARITY. ALL SEDIMENT CONTROLS WILL BE CONSTRUCTED AT THE LOD.

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OWNER / DEVELOPER/ APPLICANT: MARYLAND ZOO IN BALTIMORE 1876 MANSION HOUSE DRIVE BALTIMORE MD 21217 CONTACT: MR. KARL KRANZ PHONE: 443-552-3350

SITE

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12.

15.

PROVIDE ALL PROPER PERMITS PRIOR TO THE START OF CONSTRUCTION.

THE CONTRACTOR MUST SUBMIT A WRITTEN NOTIFICATION SWM/ESC INSPECTION SECTION AT LEAST 72 HOURS PRIOR TO THE START OF CONSTRUCTION TO THE DEPARTMENT OF PUBLIC WORKS, OFFICE OF RESEARCH AND ENVIRONMENTAL PROTECTION: 3001 DRUID PARK DRIVE, ROOM 228, BALTIMORE, MD 21215; PHONE: 410-396-0732: EMAIL DPW.ESCINSPECTIONS@BALTIMORECITY.GOV. THE NOTIFICATION MUST INCLUDE:

- A. REQUEST FOR A PRE-CONSTRUCTION MEETING
- B. WHEN CONTRACTOR INTENDS TO BEGIN CONSTRUCTION, C. WHEN CONTRACTOR INTENDS TO INSTALL STORMWATER MANAGEMENT FACILITIES.
- D. SOURCE OF BORROW MATERIAL
- E. LOCATION OF DISPOSAL AREA WITH AN ACTIVE PERMIT,
- F. CONTRACTOR'S TENTATIVE CLOSING DATE.

CONDUCT ON-SITE PRE-CONSTRUCTION MEETING WITH ALL PARTIES, INCLUDING BUT NOT LIMITED TO THE BALTIMORE CITY SEDIMENT CONTROL INSPECTOR, OWNER'S REPRESENTATIVES. CONTRACTOR'S REPRESENTATIVES AND ARCHITECT TO DISCUSS ISSUES INCLUDING, BUT NOT LIMITED TO WAYS AND MEANS AND LIMITS OF RESPONSIBILITIES AND WORK, AND TO INSPECT THE SITE FOR ANY UNFORESEEN CONDITIONS

UPON WRITTEN APPROVAL OF THE BALTIMORE CITY ESC INSPECTOR, CLEAR AND GRUB THE AREA FOR THE INSTALLATION OF PERIMETER SEDIMENT CONTROL DEVICES ONLY. UPON WRITTEN APPROVAL OF THE BALTIMORE CITY ESC INSPECTOR, INSTALL REMAINING SEDIMENT CONTROL DEVICES SEDIMENT CONTROL DEVICES AND BEGIN CONSTRUCTION. CONTRACTOR SHALL INSTALL DEWATERING CONTROLS DURING ALL TRENCHING AND EXCAVATION AT THE DISCRETION OF THE EROSION AND SEDIMENT CONTROL INSPECTOR. PERFORM SITE DEMOLITION AND SITE GRADING TO FACILITATE THE INSTALLATION OF THE PROPOSED SITE FEATURES, THE CONTRACTOR SHALL REMOVE FROM ANY MATERIAL FROM THE SITE THAT EXCEEDS THE ALLOWABLE STOCKPILE AREA LIMIT BY THE END OF

EACH WORKDAY BEGIN CONSTRUCTION OF THE PROPOSED BUILDING AND ANIMAL EXHIBITS. PERFORM SITE GRADING, AND STABILIZE ALL AREAS DISTURBED BY THIS PROCESS. BEGIN UTILITY CONSTRUCTION INCLUDING, BUT NOT LIMITED TO, STORM DRAIN

STRUCTURES, STORM WATER MANAGEMENT FACILITIES, AND ALL STORM DRAIN, SANITARY SEWER, AND WATER PIPING. DO NOT INSTALL STORM WATER FILTRATION MEDIA IN THE MODULAR WETLAND AT THIS TIME. SEE APPROVED STORM WATER MANAGEMENT SHEETS FOR THE STORM WATER SEQUENCE OF CONSTRUCTION. STABILIZE ALL AREAS DISTURBED BY THIS PROCESS

BEGIN CONSTRUCTION OF HARDSCAPED AREAS INCLUDING, BUT NOT LIMITED TO, ASPHALT PAVING, CONCRETE PAVING, FENCE INSTALLATION, AND ITEMS ASSOCIATED WITH THE ANIMAL EXHIBITS. PERMANENTLY STABILIZE ALL AREAS DISTURBED BY THIS PROCESS.

AFTER ALL STORM DRAIN AND STORM WATER MANAGEMENT DEVICES HAVE BEEN INSTALLED AND HAVE BEEN PROPERLY CONNECTED, FLUSH THE STORM DRAIN NETWORK. INSTALL THE FILTRATION MEDIA IN THE MODULAR WETLAND. AND ACTIVATE THE STORM DRAIN SYSTEM. CONTRACTOR MUST CAPTURE ALL SEDIMENT FROM THE STORM DRAIN NETWORK FLUSH

13. <u>NOTIFY</u> AS-BUILT ENGINEER, PROFESSIONAL ENGINEER WHO WILL BE PERFORMING THE AS-BUILT CERTIFICATION, AND GEOTECHNICAL ENGINEER OF THE SWM FACILITY AT LEAST FIVE (5) WORKING DAYS PRIOR TO BEGINNING THE WORK. 14. PERFORM FINE GRADING AND PERMANENTLY STABILIZE THE AREAS DISTURBED BY THIS

PROCESS. ONCE THE SITE HAS BEEN PERMANENTLY STABILIZED AND WITH WRITTEN PERMISSION FROM THE BALTIMORE CITY SEDIMENT CONTROL INSPECTOR, REMOVE ESC MEASURES AND IMMEDIATELY STABILIZE ANY DISTURBANCE FROM REMOVAL 16. AS REQUIRED, WITH INSPECTOR'S WRITTEN APPROVAL, CONTRACTOR TO FILE NOTICE OF TERMINATION (NOT) TO MDE AND CLOSE ANY APPLICABLE PERMITS.



BKP

DRAWING TITLE: EROSION AND SEDIMENT CONTROL COVER SHEET

DRAWING NO:

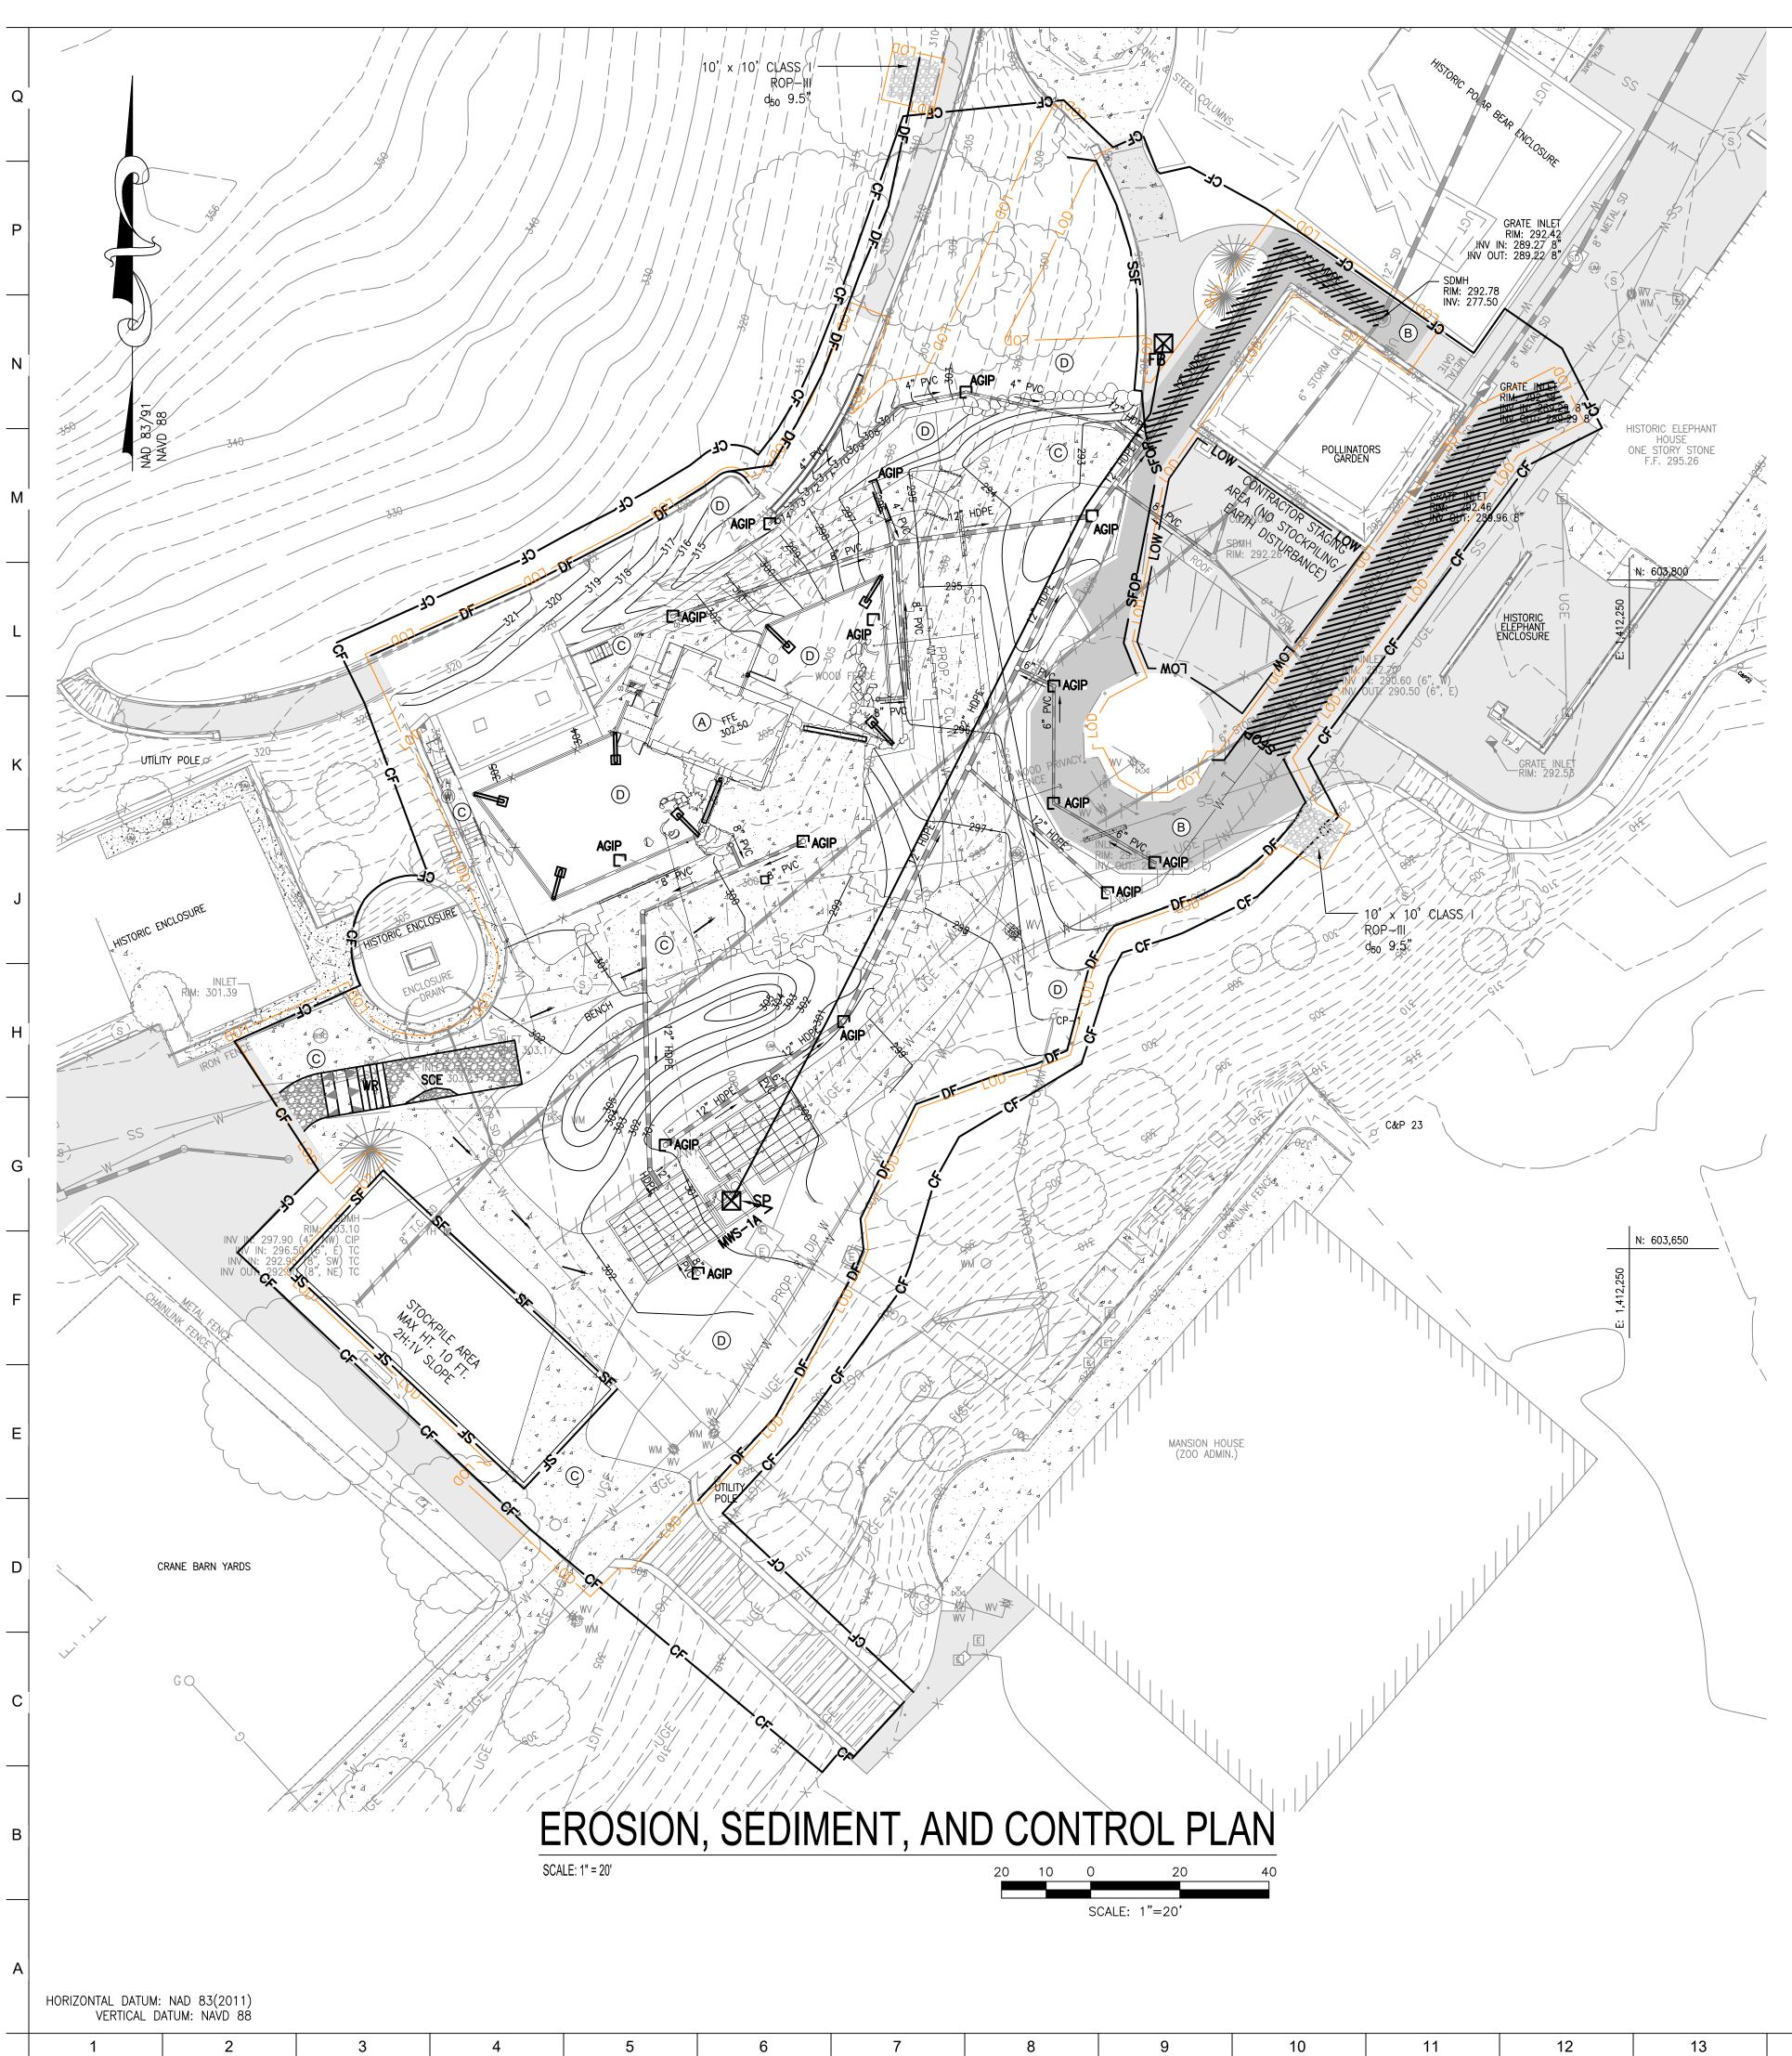


BCNR # 11545

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STABILIZED CONS

<u>GENERAL NOTES</u>:

- FIELD RUN TOPOGRAPHIC SU
 EXISTING UNDERGROUND UTILITIES SHOWN FOR REFERENCE ONLY.
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- SATISFACTION, AT THE CONTRACTO
 LIVE UNDERGROUND UTILITIES MAY WITH APPLICABLE FEDERAL, STATE
 INFORMATION SHOWN ON THIS DR LOCATIONS OF PROPOSED CONSTR CONTRACTOR TO PROVIDE ALL CO

<u>NOTE:</u>

- 1. LIMIT OF DISTURBANCE OFFSET
- 2. TOTAL LIMIT OF DISTURANCE: 33, **PROJECT WILL REQUIRE MDE
- 3. ANY SILT FENCE OR SILT FENCE WORKING DAY. ANY SEDIMENT IN

	<u>ST</u>
AREA	SQ.FT.
A BUILDINGS	2,265
B ROADWAYS	3,365
C CURBS & SIDEWALKS	11,210
D PERVIOUS AREAS	16,695
E SEDIMENT CONTROLS	
AREAS ARE TO BE VEGETA THE BALTIMORE CITY STAN	

SITE AREA	743.98
LOD	0.77
CUT	1,625
FILL	525
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						PROJECT TEAN	
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	WALK					CARROLL ENG	
	E FUND ELECTRIC			OWNER / DEVELOPER/ APPLICANT MARYLAND ZOO IN BALTIMORE 1876 MANSION HOUSE DRIVE		HUNT VALLE T: 410.7	EY, MD 21031 85.7423
RMDRA	CLEANOUT IN LINE IN MANHOLE			BALTIMORE MD 21217 CONTACT: MR. KARL KRANZ PHONE: 443–552–3350	2	LANDSCAPE ROBINSON ANDE 28 WEST ST/ MEDIA, F T: 302.8	RSON SUMMERS ATE STREET PA 19063
LL SEC ER VAL	CTIONAL VAULT .VE .T FENCE						SIGN STUDIO, INC AY HOLLADAY RD ITY, UT 84117
	CTION FENCE FECTION				ł	MEP EN KOVACS, WHITNE 190 WEST OSTE BALTIMORE T: 410.2	Y & ASSOCIATES ND ST, STE 300 E, MD 21230
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_ter e	PAG					CLIENT: MARYLA THE MARYLAND ZO	AND ZOO
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ES DES THE D COLLE ELF F/ EXCAV ION, TI ILTIES GIVING SIGNAT ONTRA TOR'S IAY EX	SIGNATED ON THE OWNER AND ENGI ESIGNATION INDICA ECTION AND DEPIC AMILIAR WITH THOS ATION, IN THE AB HE EXISTENCE, DE ARE LIVE. ANY EA OF INFORMATION TED OR UNDESIGN CTOR, THE CONTR EXPENSE.	PLANS ARE BAS INEER DISCLAIM ATED. THE QUA CTION OF EXISTIN SE STANDARDS F SENCE OF QUAL EPTH, SIZE, MATE ARTHWORK IN LO ON THE PLANS ATED EXISTING U ACTOR SHALL RI	ANY RESPONSIBILITY LITY LEVEL DESIGNA IG SUBSURFACE UTI PRIOR TO ANY RELIA ITY LEVEL A OR B ERIAL, AND LOCATION CATIONS WHERE UT WILL NOT RELIEVE JTILITIES AND APPUF EPAIR THE DAMAGE	D24 . AVAILABLE INFORMATION AND ARE FOR THE ACCURACY OR COMPLETENESS FED IS IN ACCORDANCE WITH ASCE LITY DATA" (CI/ASCE 38–02). THE NCE ON THE INFORMATION SHOWN ON DESIGNATION, THE CONTRACTOR SHALL I OF ALL UNDERGROUND UTILITIES, AND LITIES ARE POSSIBLE SHALL BE DONE THE CONTRACTOR OF HIS OBLIGATION TO RTENANCES. SHOULD ANY EXISTING CAUSED TO THE UTILITY OWNER'S		D PAND	IN BALIIMURE 1 SAFARI PLACE BALTIMORE, MD 2121
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-		·	9			DATE: JANUARY 1	4, 2025
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0	CONCRETE CURBS/W	ALKS (permanent)	9			CHECKED BY	CMS
5	TEMPORARY SEED	·	<u>7,8</u>			SUBMISSION BID SET	DATE 01/14/2025
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	TO SATISFY THE 3/7 DA ID SEDIMENT CONTRO		PER			REVISION	DATE
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