



**ARCHITECT:** BUELL KRATZER POWELL, P.C. 1525 LOCUST STREET PHILADELPHIA, PA 19102

## T: 215.557.6509 **CIVIL ENGINEER:**

CARROLL ENGINEERING, INC 215 SCHILLING CIRCLE, STE 102 HUNT VALLEY, MD 21031 T: 410.785.7423

## **LANDSCAPE ARCHITECT:** ROBINSON ANDERSON SUMMERS

28 WEST STATE STREET MEDIA, PA 19063 T: 302.888.1544

## STRUCTURAL ENGINEER: STRUCTURAL DESIGN STUDIO, INC

2225 EAST MURRAY HOLLADAY RD SALT LAKE CITY, UT 84117 T: 801.274.3950

## MEP ENGINEER: KOVACS, WHITNEY & ASSOCIATES

190 WEST OSTEND ST, STE 300 BALTIMORE, MD 21230 T: 410.244.7191

## CLIENT:

THE MARYLAND ZOO IN BALTIMORE 1 SAFARI PLACE BALTIMORE, MD 21217

THIS DRAWING IS TO ILLUSTRATE THE WORK TO BE DONE. THE ARCHITECT IS NOT RESPONSIBLE FOR THE MEANS, METHODS, TECHNIQUES, SEQUENCES, AND PROCEDURES USED TO DO THE WORK OR THE SAFETY ASPECTS OF CONSTRUCTION, AND NOTHING ON THIS DRAWING EXPRESSED RESPONSIBLE FOR KNOWING HOW THEY AFFECT THE WORK. SUBMITTAL OF A BID TO PERFORM THIS WORK IS AN

ACKNOWLEDGEMENT OF THESE RESPONSIBILITIES, AND THAT THEY

HAVE BEEN FULLY CONSIDERED IN PLANNING OF THE WORK

....10 PSF

..20 PSF

...25 PSF + DRIFT



DATE: JANUARY 14	, 2025
PROJECT NO: 2023	3-10.04
DRAWN BY	SDS
CHECKED BY	JLM
SUBMISSION	DATE
BID SET	01/14/2025
REVISION	DATE

DRAWING TITLE:

ROOF FRAMING PLAN

DRAWING NO:

structural

DESIGN STUDIO 2225 E. Murray Holladay Rd. #110 Salt Lake City, Utah 84117 801.274.3950 :: structuralds.com

CC#					CONCRETE COLUMN SCHEDULE
MADIZ	CIZE	TVDE	COLUMN RE	INFORCING	COMMENTS
MARK	SIZE	TYPE	VERTICAL BARS	TIES	COMMENTS
CC12	8X16	S4	(4) #5	#3@6" OC	
			( )		

1. DESIGNATION "TYPE S[#] AND R[#]" WHERE [#] EQUALS THE NUMBER OF VERTICAL REINFORCING BARS.

2. ALL PIERS SHALL BE CENTERED ON COLUMN BASE PLATE ABOVE UNLESS NOTED OTHERWISE.


3. ALL VERT REINFORCING SHALL BE DOWELED TO FOOTING BELOW WITH SAME SIZE REINFORCING WITH STANDARD 90 DEGREE HOOK.

4. TIES SHALL BE PLACED @ 3" OC AROUND ANCHOR BOLTS UNO.

5. SEE GENERAL STRUCTURAL NOTES FOR REINFORCING LAYOUT.

CONCRETE COLUMN SCHEDULE + DETAILS M1

CONCRETE COLUMN "INTEGRATED" INTO CONC WALL

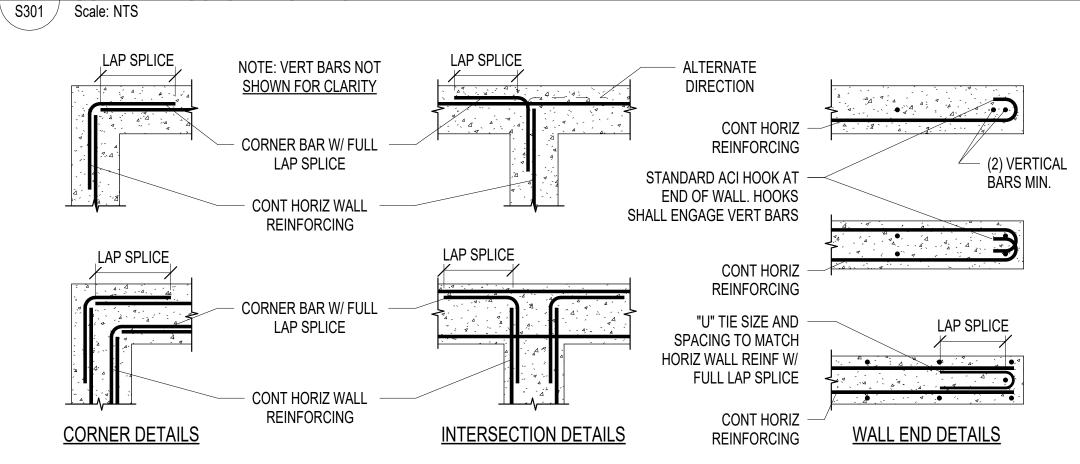


	SEE GSN FOR	CLR	
TYPE A	INSIDE FACE  TYPE B	INSIDE FACE  A COUTSIDE FACE  A COUTSIDE FACE	INSIDE FACE  OUTSIDE FACE  OUTSIDE FACE


CW#					CONCRETE WALL SCHEDUL
MADIA	MIDTH	TVDF	WALL REI	NFORCING	COMMENTS
MARK	WIDTH	TYPE	HORIZONTAL	VERTICAL	COMMENTS
CW6	6"	TYPE A	#4@12" OC	#4@12" OC	
CW8	8"	TYPE A	#5@12" OC	#5@12" OC	
CW8S	8"	TYPE A	#4@12" OC	#4@12" OC	
CW14	14"	TYPE C	#5@12" OC IF, #4@12" OC OF	#5@12" OC IF, #4@12" OC OF	THERMOMASS

- 1. AT TOP AND BTM OF WALL, INCLUDING ALL DECK BEARING ELEVATIONS PROVIDE (2) #5 CONT IN ADDITION TO SCHEDULED REINFORCING. 2. OUTSIDE FACE OF REINFORCING DESIGNATION TO BE PLACED ON THE SOIL SIDE OF THE WALL.
- 3. THIS IS A SHEAR WALL PLACE CC12 AT THE END + EA JAMB OF WALL
- 4. ALL HORIZONTAL REINFORCING SHALL TERMINATE AT ENDS OF WALLS + ALL JAMBS WITH A STANDARD HOOK. END OF WALL IS DEFINED AS ANY
- WALL SEGMENT THAT EITHER CHANGES DIRECTION AND/OR CHANGES TO A DIFFERENT WALL TYPE.
- 5. SEE GENERAL STRUCTURAL NOTES FOR ALL OTHER REQUIREMENTS.


REINFORCED CONCRETE WALL SECTION TYPES

CONCRETE WALL SCHEDULE + DETAILS S301 / Scale: NTS

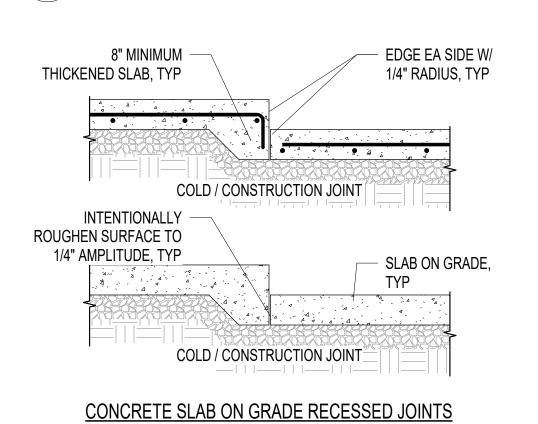

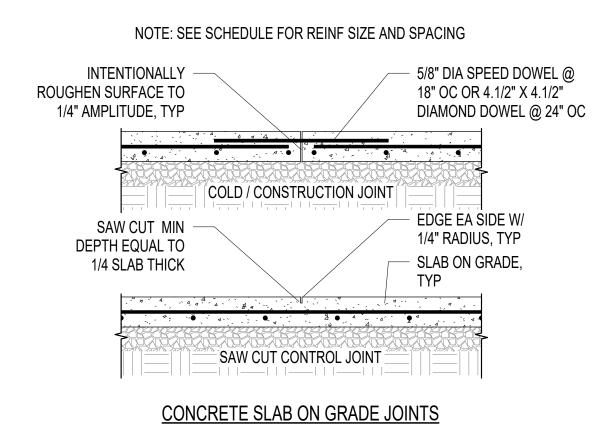

CONCRETE COLUMN REINFORCING LAYOUT TYPES

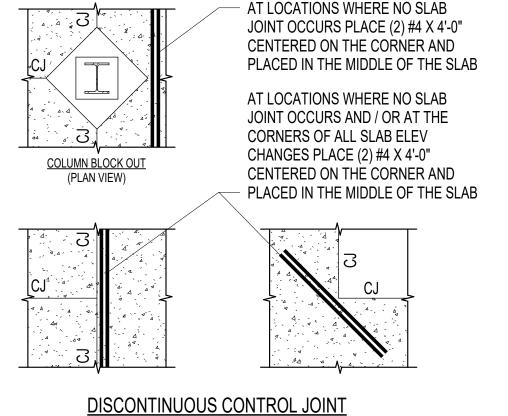


(PLAN VIEW)

S#			CONCRETE	E SLAB ON GRADE SCHEDULE
MARK	THICK	SLAB REINFORCING	SLAB BASE MATERIAL	COMMENTS
S1	5"	#4@16" OC EA WAY	SEE GEOTECH	

1. SEE GEOTECHNICAL REPORT FOR ADDITIONAL SLAB ON GRADE REQUIREMENTS.

2. SEE GENERAL STRUCTURAL NOTES FOR ALL OTHER REQUIREMENTS.

CONCRETE SLAB ON GRADE SCHEDULE + DETAILS S301 / Scale: NTS

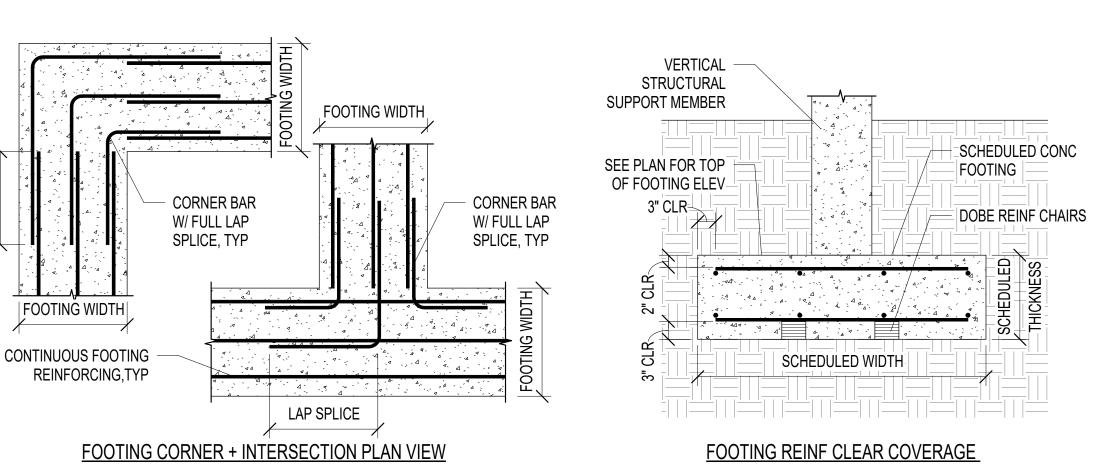

MADIZ	MIDTU	LENCTU	TUICIA	CF	ROSSWISE	REINFORC	ING	LE	NGTHWISE	REINFORC	ING	COMMENTO
MARK	WIDTH	LENGIH	IHICK	NO. BARS	BAR SIZE	LENGTH	SPACING	NO. BARS	BAR SIZE	LENGTH	SPACING	COMMENTS
FC2.5	2' - 6"	CONT	12"		#5	2' - 0"	12" OC	4	#5	CONT	8"	
FC3.0	3' - 0"	CONT	12"		#5	2' - 6"	12" OC	4	#5	CONT	10"	
		I	I				I	I	ı			
FS4.5x12	4' - 6"	12' - 0"	18"	13	#6	4' - 0"	12"	7	#7	11' - 6"	8"	TOP+BTM, NOTE 6
1 0 T.OX 12			4.011	11	#6	3' - 6"	11"	6	#7	9' - 6"	8"	TOP+BTM, NOTE 6
	4' - 0"	10' - 0"	18"	11	πΟ							
	4' - 0" 4' - 0"	10' - 0" 11' - 0"	18" 18"	12	#6	3' - 6"	11"	6	#7	10' - 6"	8"	TOP+BTM, NOTE 6
FS4X10						3' - 6" 4' - 6"	11" 12"	6 8	#7 #7	10' - 6" 11' - 6"	8" 8"	TOP+BTM, NOTE 6 TOP+BTM, NOTE 6

1. CONTINUOUS FOOTINGS SHALL BE CENTERED UNDER WALLS, UNO 2. SPOT FOOTINGS SHALL BE CENTERED UNDER COLUMNS, UNO.

- 3. ALL FOOTINGS SHALL BE FORMED AND NOT EARTH FORMED OR OVERSIZED WITHOUT WRITTEN PERMISSION FROM THE STRUCTURAL

- 4. PLACE ALL FOOTING REINFORCING IN BOTTOM OF FOOTING WITH 3" CLEAR CONCRETE COVER.
- 5. REINFORCING IN CONTINUOUS FOOTINGS SHALL PASS THROUGH INTERSECTING SPOT FOOTINGS.
- 6. PROVIDE TOP + BOTTOM REINFORCING WITH 90 DEGREE HOOK AT EACH END.
- 7. TOP REINFORCING SHOWN IN DETAILS SHALL BE #5 @ 12" OC UNLESS NOTED OTHERWISE 8. AS A MINIMUM ALL FOOTINGS GREATER THAN OR EQUAL TO 18" IN THICKNESS REQUIRE #6 @ 12" OC EA WAY IN THE TOP OF FOOTING. REFER
- TO SCHEDULE FOR MORE STRINGENT REQUIREMENTS.
- 9. SEE GENERAL STRUCTURAL NOTES FOR ALL OTHER REQUIREMENTS



BKP

PROJECT TEAM:

**ARCHITECT:** BUELL KRATZER POWELL, P.C. 1525 LOCUST STREET PHILADELPHIA, PA 19102

T: 215.557.6509 **CIVIL ENGINEER:** 

CARROLL ENGINEERING, INC 215 SCHILLING CIRCLE, STE 102 HUNT VALLEY, MD 21031 T: 410.785.7423

LANDSCAPE ARCHITECT: ROBINSON ANDERSON SUMMERS 28 WEST STATE STREET MEDIA, PA 19063 T: 302.888.1544

STRUCTURAL ENGINEER: STRUCTURAL DESIGN STUDIO, INC 2225 EAST MURRAY HOLLADAY RD SALT LAKE CITY, UT 84117 T: 801.274.3950

MEP ENGINEER: KOVACS, WHITNEY & ASSOCIATES 190 WEST OSTEND ST, STE 300 BALTIMORE, MD 21230

T: 410.244.7191

CLIENT:

THE MARYLAND ZOO IN BALTIMORE 1 SAFARI PLACE BALTIMORE, MD 21217

THIS DRAWING IS TO ILLUSTRATE THE WORK TO BE DONE. THE ARCHITECT IS NOT RESPONSIBLE FOR THE MEANS, METHODS, TECHNIQUES, SEQUENCES, AND PROCEDURES USED TO DO THE WORK OR THE SAFETY ASPECTS OF CONSTRUCTION, AND NOTHING ON THIS DRAWING EXPRESSED OR IMPLIED CHANGES THIS CONDITION. CONTRACTOR SHALL BE RESPONSIBLE FOR KNOWING HOW THEY AFFECT THE WORK. SUBMITTAL OF A BID TO PERFORM THIS WORK IS AN ACKNOWLEDGEMENT OF THESE RESPONSIBILITIES, AND THAT THEY HAVE BEEN FULLY CONSIDERED IN PLANNING OF THE WORK

AND THE BID PRICE. NO CLAIMS FOR EXTRA CHARGES DUE TO

THESE CONDITIONS WILL BE FORTHCOMING.



DATE: JANUARY 14	., 2025
PROJECT NO: 2023	3-10.04
DRAWN BY	SDS
CHECKED BY	JLM
SUBMISSION	DATE
BID SET	01/14/20
REVISION	DATE

DRAWING TITLE:

STRUCTURAL **SCHEDULES** 

DRAWING NO:

CONCRETE FOOTING SCHEDULE + DETAILS A1 S301 Scale: NTS

CROSSWISE

FOOTING STEP

REINF AS OCCURS

Z-BARS MATCH


DOWEL TO MATCH

VERT + HORIZ WALL

REINF, TYP

REINF

FOOTING LENGTHWISE

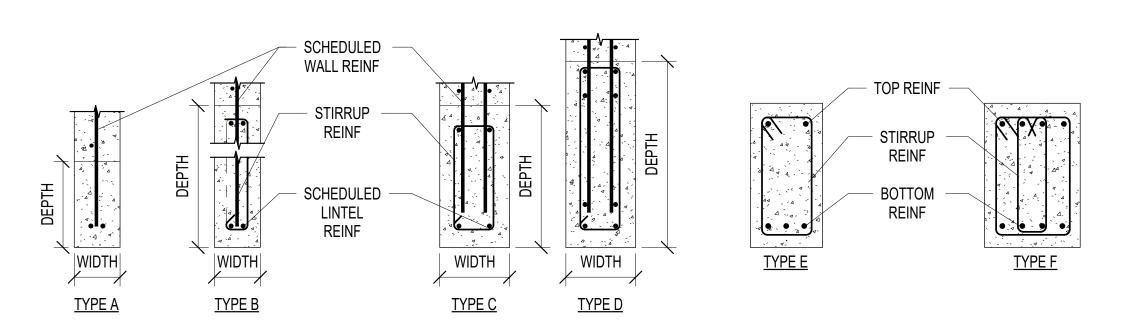

CB# CL	_#					CONC	RETE BEAM/LINTEL SCHEDULE
MARK	DEPTH	WIDTH	TYPE	BEAM/LINTEL F	REINFORCING	SUPPORT	COMMENTS
IVIAINN	DEFIN	חוטוויי	ITFE	HORIZONTAL	STIRRUPS	COLUMN	COMMENTS
CL1	18"	8"	TYPE B	(2) #5 T+B	#3@8" OC	CC12	
CB1	16"	12"	TYPE E	(2) #5 T+B	#3@6" OC	CC12	


## NOTES:

- 1. LINTELS SHALL BE OF THE SAME MATERIAL AND WIDTH AS THE WALL IN WHICH THEY ARE CONSTRUCTED.
- 2. EXTEND HORIZONTAL REINFORCING BEYOND THE EDGE OF ALL OPENINGS BY REQD DEVELOPMENT LENGTH. PROVIDE
- A 90° STANDARD HOOK WHERE THIS CANNOT BE ACCOMPLISHED. 3. BEAMS SHALL BE POURED MONOLITHICALLY WITH WALL.
- 4. TERMINATE LONGITUDINAL BEAM REINFORCING WITH A STANDARD 90 DEGREE HOOK.

- 5. SEE GENERAL STRUCTURAL NOTES FOR ALL OTHER REQUIREMENTS.

## CONCRETE LINTEL SCHEDULE + DETAILS S302 Scale: NTS

**CONCRETE LINTEL TYPES** 

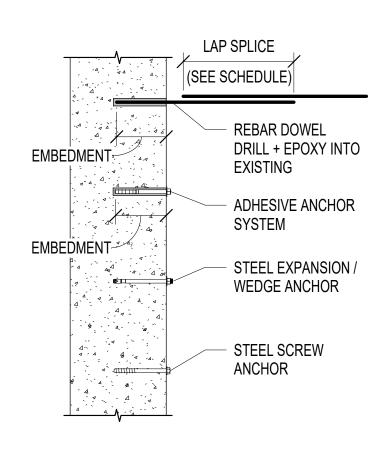


ANCHOR TYPE		ANCH	IOR			EVAL REI	PORT
ADHESIVE	HIT-RE	500 V3			IC	CC-ES ES	R-3814
ANCHOR SYSTEM	DEWA	LT PURE '	110+		IC	CC-ES ESI	R-3298
	SIMPS	ON SET-3	G		IC	CC-ES ESI	R-4057
STEEL	HILTI	KWIK BOL	T TZ		IC	CC-ES ESI	R-1917
EXPANSION / WEDGE	DEWA	LT POWER	R-STUD+ S	SD2	IC	CC-ES ESI	R-2502
ANCHOR	SIMPS	ON STRO	NG-BOLT 2	2	IC	CC-ES ESI	R-3037
STEEL	HILTI	WIK HUS	-EZ		IC	CC-ES ESI	R-3027
SCREW ANCHOR	DEWA	LT SCREV	V-BOLT+		IC	CC-ES ESI	R-3889
	SIMPS	ON TITEN	HD		IC	CC-ES ESI	R-2713
	ADHESIVI	E ANCHOR	RSYSTEM	EMBED	ME	NT	
SIZE (DIA)	#3 (3/8")	#4 (1/2")	#5 (5/8")	#6 (3/4	")	#7 (7/8")	#8 (1")
EMBEDMENT	4.1/2"	6.1/2"	7.1/2"	10"		12"	13"

							TYPICAL POST-INSTALLED ANCHOR SCHEDULE
ANCHOR TYPE		ANCH	IOR		EVAL RE	PORT	NOTES:
ADHESIVE	HIT-RE	500 V3			ICC-ES ES	R-3814	1. CAST-IN-PLACE ANCHORS CALLED OUT IN PLANS <b>SHALL NOT</b> BE REPLACED WITH POST-INSTALLED ANCHORS UNLESS SPECIFICALLY DIRECTED BY THE ENGINEER OF RECORD.
ANCHOR SYSTEM	DEWAL	T PURE 1	110+		ICC-ES ES	R-3298	2. ALL POST-INSTALLED ANCHORS INTO HARDENED CONCRETE SHALL BE SELECTED FROM THE PRE-APPROVED PRODUCTS (SHOWN IN THE TABLE) OR ENGINEER APPROVED EQUAL UNLESS NOTED OTHERWISE.
	SIMPSO	N SET-3	G		ICC-ES ES	R-4057	3. ANCHORS SHALL BE INSTALLED ACCORDING TO MANUFACTURER'S PUBLISHED INSTRUCTIONS AND APPLICABLE CODE
STEEL	HILTI KV	NIK BOLT	ГΤΖ		ICC-ES ES	R-1917	EVALUATION REPORTS  4. ALL POST-INSTALLED ANCHOR INSTALLATIONS ARE SUBJECT TO CONTINUOUS SPECIAL INSPECTION (SEE EVALUATION REPORTS
EXPANSION / WEDGE	DEWAL	T POWER	R-STUD+ S	SD2	ICC-ES ES	R-2502	AND SPECIAL INSPECTION TABLES).  5. SCHEDULED EMBEDMENT ABOVE ARE MINIMUM VALUES, HOWEVER ANY EMBEDMENT LENGTHS SHOWN IN PLANS GOVERN OVER
ANCHOR	SIMPSO	N STROI	NG-BOLT	2	ICC-ES ES	R-3037	THESE VALUES. 6. ANCHORS SHALL BE INSTALLED IN CONCRETE HAVING A MINIMUM AGE OF 21 DAYS. FOR INSTALLATIONS SOONER THAN 21 DAYS,
STEEL	HILTI KV	NIK HUS-	-EZ		ICC-ES ES	R-3027	CONSULT MANUFACTURER. 7. INSTALLATION OF ADHESIVE ANCHORS HORIZONTALLY OR UPWARDLY INCLINED TO SUPPORT SUSTAINED TENSION LOADS SHALL
SCREW ANCHOR	DEWAL	T SCREW	V-BOLT+		ICC-ES ES	R-3889	BE PERFORMED BY A CERTIFIED ADHESIVE ANCHOR INSTALLED (AAI) AS CERTIFIED THROUGH ACI AND IN ACCORDANCE WITH ACI
	SIMPSO	N TITEN	HD		ICC-ES ES	R-2713	318-14 (SECTION 17.8.2.2). PROOF OF CURRENT CERTIFICATION SHALL BE SUBMITTED TO THE ENGINEER FOR APPROVAL PRIOR TO COMMENCEMENT OF INSTALLATION.
A	DHESIVE	ANCHOR	RSYSTEM	EMBEDN	IENT		8. IF TEMPERATURE OF BASE MATERIAL AT TIME OF ADHESIVE INSTALLATION IS AT 40 DEGREES (FAHRENHEIT) OR LESS, VERIFY WITH MANUFACTURER THAT FULL STRENGTH OF ADHESIVE CAN BE OBTAINED, OTHERWISE AN "ACRYLIC" ADHESIVE IS
SIZE (DIA)	#3 (3/8") #	#4 (1/2")	#5 (5/8")	#6 (3/4")	#7 (7/8")	#8 (1")	REQUIRED.  9. DO NOT DAMAGE EXISTING REINFORCING OR EMBEDS DURING THE INSTALLATION OF POST-INSTALLED ANCHORS. CONTRACTOR
EMBEDMENT	4.1/2"	6.1/2"	7.1/2"	10"	12"	13"	TO LOCATE ALL EXISTING EMBEDDED ITEMS AND REINFORCING PRIOR TO THE INSTALLATION OF POST-INSTALLED ANCHORS.

**CONCRETE BEAM TYPES** 



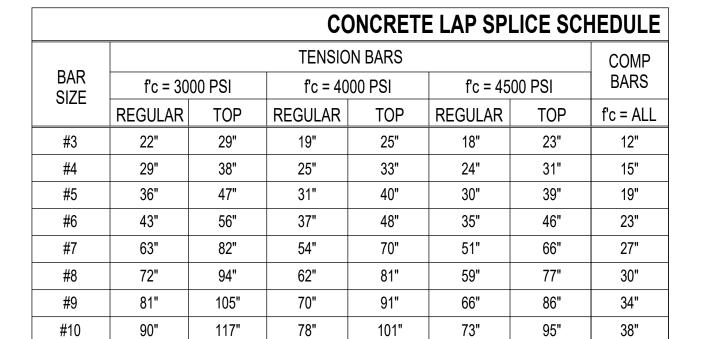

#11

98"

127"

1. TOP BARS ARE HORIZONTAL BARS, SPLICED SO THAT 12" OR MORE OF FRESH CONCRETE IS CAST IN THE MEMBER BELOW THE REINFORCING BAR.

85"

2. ALL COLUMNS CAST INTEGRAL WITH WALLS, OR WHICH SUPPORT STEEL BRACED OR MOMENT FRAMES, OR WHICH ARE DESIGNATED MOMENT FRAMES ARE TO USE REGULAR LAP SPLICES. ALL OTHER CONCRETE COLUMNS MAY USE COMPRESSION BAR (COMPBAR) LAP SPLICE

111"

80"

104"

42"

- 3. FOR VERTICAL BARS IN SHEAR WALL BOUNDARY ELEMENTS (SEE CONCRETE WALL SCHEDULE AND NOTES), LAP SPLICE VALUES ABOVE SHALL BE MULTIPLIED BY 1.25.
- 4. WHERE LIGHTWEIGHT CONCRETE IS USED, LAP SPLICE VALUES ABOVE SHALL BE MULTIPLIED
- 5. WHERE EPOXY COATED REINFORCING IS SPECIFIED, LAP SPLICE VALUES ABOVE SHALL BE MULTIPLIED BY 1.5.

H16 CONCRETE LAP SCHEDULE
S302 Scale: NTS

BKP

## PROJECT TEAM:

**ARCHITECT:** BUELL KRATZER POWELL, P.C. 1525 LOCUST STREET PHILADELPHIA, PA 19102

# T: 215.557.6509

**CIVIL ENGINEER:** CARROLL ENGINEERING, INC 215 SCHILLING CIRCLE, STE 102 HUNT VALLEY, MD 21031 T: 410.785.7423

## LANDSCAPE ARCHITECT: ROBINSON ANDERSON SUMMERS

28 WEST STATE STREET MEDIA, PA 19063 T: 302.888.1544

## STRUCTURAL ENGINEER: STRUCTURAL DESIGN STUDIO, INC

2225 EAST MURRAY HOLLADAY RD SALT LAKE CITY, UT 84117 T: 801.274.3950

## MEP ENGINEER: KOVACS, WHITNEY & ASSOCIATES

190 WEST OSTEND ST, STE 300 BALTIMORE, MD 21230 T: 410.244.7191

## CLIENT:

THE MARYLAND ZOO IN BALTIMORE 1 SAFARI PLACE BALTIMORE, MD 21217

THIS DRAWING IS TO ILLUSTRATE THE WORK TO BE DONE. THE ARCHITECT IS NOT RESPONSIBLE FOR THE MEANS, METHODS, TECHNIQUES, SEQUENCES, AND PROCEDURES USED TO DO THE WORK OR THE SAFETY ASPECTS OF CONSTRUCTION, AND NOTHING ON THIS DRAWING EXPRESSED OR IMPLIED CHANGES THIS CONDITION. CONTRACTOR SHALL BE RESPONSIBLE FOR KNOWING HOW THEY AFFECT THE WORK. SUBMITTAL OF A BID TO PERFORM THIS WORK IS AN

ACKNOWLEDGEMENT OF THESE RESPONSIBILITIES, AND THAT THEY HAVE BEEN FULLY CONSIDERED IN PLANNING OF THE WORK, AND THE BID PRICE. NO CLAIMS FOR EXTRA CHARGES DUE TO THESE CONDITIONS WILL BE FORTHCOMING.



DATE: JANUARY 14,	. 2025
PROJECT NO: 2023	-10.04
DRAWN BY	SDS
CHECKED BY	JLM
SUBMISSION	DATE
BID SET	01/14/2025
REVISION	DATE


DRAWING TITLE:

STRUCTURAL **SCHEDULES** 

DRAWING NO:



20

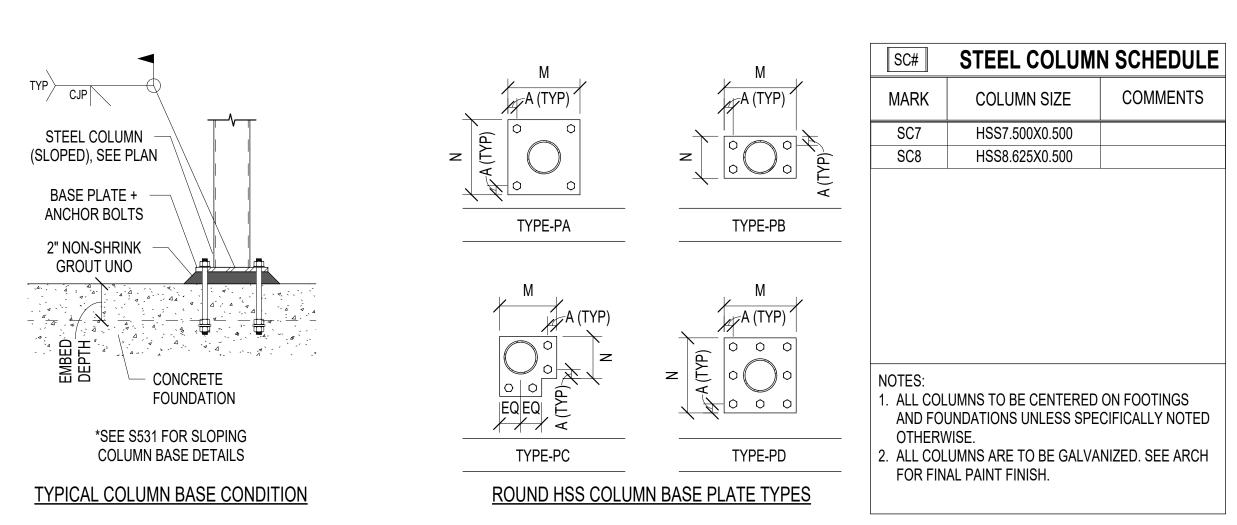

MARK	TYPE	"M" DIM	"N" DIM	PLATE THICKNESS	GROUT THICKNESS	"A" DIM	NO. OF ANCHORS	ANCHOR SIZE	ANCHOR EMBED	ANCHO TYPE
7	TYPE-PD	18"	18"	1 1/2"	2"	2"	8	1 1/4"	1' - 2"	HEADE
8	TYPE-PD	20"	20"	1 3/4"	2"	2"	8	1 1/4"	1' - 2"	HEADE

- 1. ALL COLUMNS TO BE CENTERED ON BASE PLATES UNLESS SPECIFICALLY NOTED OTHERWISE.
- 2. ALL BASE PLATES ARE TO BE A572-50 GRADE WITH 7/8" THICK x 6" x 6" SHEAR LUG CENTERED W/ 5/16" WELD TO BASE PLATE. NOTCH SHEAR LUGS AS REQ'D TO ACCOMMODATE REINF STEEL
- 3. ALL ANCHORS SHALL BE HEAVY HEADED ANCHOR RODS W/ 4"X4"X1/2" PLATE WASHERS WITH DOUBLE NUTS EMBEDDED IN CONCRETE AT THE
- EMBEDMENT DEPTH SPECIFIED.
- 4. ALL ANCHOR RODS ARE TO BE ASTM F1554-55 UNLESS NOTED OTHERWISE
- 5. SEE GENERAL STRUCTURAL NOTES FOR ALL OTHER REQUIREMENTS.

GRAVITY STEEL COLUMN + BASE PLATE SCHEDULE M1 GRAVITY S303 Scale: NTS

4'X8' WOOD

DIAPHRAGM

**BOUNDARY** 

NAILING IN THE

'FIELD' OF THE PANEL

STRUCTURAL PANEL

— PANEL EDGE NAILING	4'X8' WOOD — Structural Panel	
<ul><li>DIAPHRAGM</li><li>BOUNDARY NAILING</li></ul>	DIAPHRAGM — BOUNDARY	<ul><li>THIS PANEL JOINT NOT CONTINUOUS</li></ul>
- CONTINUOUS PANEL JOINT	MAX NAIL SPACING — AT DIAPH BOUNDARY	<ul><li>CONTINUOUS</li><li>PANEL JOINT</li></ul>
<ul> <li>NAILING ALONG</li> <li>CONTINUOUS PANEL</li> <li>JOINT</li> </ul>	AND SUPPORTED EDGE IS 6" OC	- ROOF OR FLOOR JOIST
ROOF OR FLOOR JOIST	THIS PANEL EDGE IS NOT — SUPPORTED BY BLOCKING AND IS KNOWN AS THE	<ul> <li>NAILING TO INTERMEDIATE     FRAMING MEMBERS IS ALSO     KNOWN AS 'FIELD' NAILING.     SPACING IS 12" OC FOR</li> </ul>
<ul> <li>BLOCKING CUT AND FITTED</li> <li>BETWEEN JOISTS AT PANEL</li> <li>EDGES. NAILING AT THESE</li> </ul>	UNBLOCKED EDGE - OTHER TYPE OF EDGE SUPPORT MAY BE REQUIRED FOR	ROOFS AND FLOORS (6" OC WHEN SUPPORTS ARE SPACED 48" OR GREATER).

					WOO	D DECK SCHEDULE
MARK T	THICKNESS	TYPE	BOUNDARY NAILING	FIELD NAILING	BLOCKING	COMMENTS
RD1	3/4"	OSB	10d@6" OC	8d@6" OC	UNBLOCKED	
RD2	15/32"	OSB	10d@6" OC	8d@6" OC	UNBLOCKED	

G1 WOOD DIAPh.
S303 Scale: NTS

A1 CABLE CONNECTION PLATE SCHEDULE

S303 Scale: NTS

	BLOCKING CUT AND FITTED BETWEEN JOISTS AT PANEL EDGES. NAILING AT THESE AND OTHER PANEL EDGES IS GIVEN IN IBC TABLE 2306.2	UNBLOCKED EDGE - OTHER TYPE OF EDGE SUPPORT MAY BE REQUIRED FOR SHEATHING LOADS	1 1	1 1	I	1 1	l	WHEN SU SPACED
<u>AL ROOF OR FLOOR PLAN (BLOCKED DIAPH</u>	HRAGM)	<u>Partial</u> f	ROOF OR FL	OOR PL	AN (UN	<u>IBLOCK</u>	ED DIA	<u>(PHRAGM)</u>
APHRAGM SHEATHING SCHEDULE	+ DETAILS							

						CABLE CONNECTION PLATE SCHEDULE
CABLE	THICKNESS	HOLE	WELD	PLATE DI	MENSIONS	B A
SIZE	(TP)	SIZE	W	А	В	
1/4"	1/2"	3/4"	1/4"	7/8"	3"	HOLE DIA
3/8"	1/2"	1"	5/16"	1.1/4"	3"	
1/2"	1/2"	1"	5/16"	1.5/8"	3"	
5/8"	3/4"	1.1/4"	3/8"	1.7/8"	3"	
3/4"	1"	1.1/2"	3/8"	2"	3"	TYP
7/8"	1"	1.1/2"	3/8"	2.1/2"	3"	HOLE DIA W
1"	1.1/4"	1.3/4"	7/16"	3"	3"	
1.1/4"	1.1/2"	2"	1/2"	3.3/4"	3"	
1.1/2"	1.3/4"	2.3/4"	1/2"	5"	3"	
2. GENERAL HARDWA 3. CABLES ( WIRE RO	TO MATCH THE S CONTRACTOR TO RE AND OR CABLE GREATER THAN O PE THIMBLE. ALL O S TO MATCH SAME	O COORDINAT E SIZE. R EQUAL TO 1' OTHERS TO US	E HOLE SIZE WIT ' IN DIAMETER T SE STANDARD W	TH PURCHASED O USE EXTRA H	IEAVY	B A

			GENERAL WOOD FRAMING SCHEDULE
CONNECTION	MINIMUM NAILING, U.N.O.	CONNECTION	MINIMUM NAILING, U.N.O.
JOIST TO SILL, TOP PLATE OR GIRDER	(3)8d, (3)3" X 0.131", TOENAIL	RIM JOIST TO TOP PLATE	8d @ 6" OC,3" X 0.131" @ 6" OC, TOENAIL
BRIDGING OR BLOCKING TO JOIST, RAFTER OR TRUSS	(2)8d, (2)3" X 0.131", TOENAIL EACH END	TOP PLATES, LAPS AND INTERSECTIONS	(2)16d, (3)3" X 0.131", FACE NAIL
BOTTOM PLATE TO JOIST, RIM JOIST, BAND JOIST OR	16d @ 16" OC, 3" X 0.131" @ 12" OC, FACE NAIL	BUILT UP HEADERS (2" TO 2" HEADER)	16d @ 16" OC, FACE NAIL EACH EDGE
BLOCKING (NOT AT BRACED WALL PANELS)	100 @ 10 00,0 7,0.101 @ 12 00,17,0214/112	CEILING JOIST TO TOP PLATE	(3)8d, (3)3" X 0.131", TOENAIL EACH JOIST
TOP OR BOTTOM PLATE TO STUD	(2)16d, (3)3" X 0.131", END NAIL	CONTINUOUS HEADER TO STUD	(4)8d, TOENAIL
STUD TO TOP OR BOTTOM PLATE	(4)8d, (4)3" X 0.131", TOENAIL; (2)16d, (3)3" X 0.131", END NAIL	CEILING JOIST, LAPS OVER PARTITIONS	(3)16d, (4)3" X 0.131", FACE NAIL
STUD TO STUD (NOT AT BRACED WALL PANELS)	16d @ 24" OC, 3" X 0.131" @ 16" OC, FACE NAIL	CEILING JOISTS TO PARALLEL RAFTERS (HEEL JOIST)	SEE IBC TABLE 2308.7.3.1, FACE NAIL
TOP PLATE TO TOP PLATE	16d @ 16" OC, 3" X 0.131" @ 12" OC, FACE NAIL	RAFTER OR ROOF TRUSS TO TOP PLATE	(3)10d, (3)3" X 0.131", TOENAIL
BLOCKING BETWEEN CEILING JOISTS, RAFTERS OR	(3)8d, (3)3" X 0.131", TOENAIL EACH END	KING STUD OR POST TO HEADER	(3)16d, FACE NAIL @ STUDS; SIMPSON A34, TOP & BOTTOM @ POSTS
TRUSSES TO TOP PLATE OR OTHER FRAMING BELOW		BUILT-UP BEAMS	SEE "TYPICAL BUILT-UP BEAM REQ'S"
RIM JOIST TO TOP PLATE	8d @ 6" OC,3" X 0.131" @ 6" OC, TOENAIL	LEDGER STRIP	(3)16d, (4)3" X 0.131", FACE NAIL EACH JOIST OR RAFTER
NOTES:			

1. USE COMMON NAILS FOR ALL NAILING.

2. REQUIREMENTS SHOWN ABOVE SHALL NOT REPLACE THOSE SHOWN IN PLANS OR DETAILS. IN ANY CASE, USE THE MORE STRINGENT REQUIREMENT.

ROOF AND WALL SHEATHING TO FRAMING	1/2" OR LESS	8d	6" OC EDGE NAILING	12" OC FIELD NAILING	SINGLE FLOOR SHEATHING TO FRAMING	3/4" OR LESS	8d	6" OC EDGE NAILING	12" OC FIELD NAILING	
	19/32" - 3/4"	8d	6" OC EDGE NAILING	12" OC FIELD NAILING		7/8" - 1"	8d	6" OC EDGE NAILING	12" OC FIELD NAILING	
	7/8" - 1.1/4"	10d	6" OC EDGE NAILING	12" OC FIELD NAILING	4	1.1/8" - 1.1/4"	10d	6" OC EDGE NAILING	12" OC FIELD NAILING	

GENERAL WOOD FRAMING SCHEDULE

S303 Scale: NTS





PROJECT TEAM:

**ARCHITECT:** BUELL KRATZER POWELL, P.C. 1525 LOCUST STREET PHILADELPHIA, PA 19102 T: 215.557.6509

**CIVIL ENGINEER:** CARROLL ENGINEERING, INC 215 SCHILLING CIRCLE, STE 102 HUNT VALLEY, MD 21031 T: 410.785.7423

LANDSCAPE ARCHITECT: ROBINSON ANDERSON SUMMERS 28 WEST STATE STREET MEDIA, PA 19063 T: 302.888.1544

STRUCTURAL ENGINEER: STRUCTURAL DESIGN STUDIO, INC 2225 EAST MURRAY HOLLADAY RD SALT LAKE CITY, UT 84117

T: 801.274.3950 **MEP ENGINEER:** KOVACS, WHITNEY & ASSOCIATES 190 WEST OSTEND ST, STE 300

CLIENT:

BALTIMORE, MD 21230 T: 410.244.7191

THE MARYLAND ZOO IN BALTIMORE 1 SAFARI PLACE BALTIMORE, MD 21217

THIS DRAWING IS TO ILLUSTRATE THE WORK TO BE DONE. THE ARCHITECT IS NOT RESPONSIBLE FOR THE MEANS, METHODS, TECHNIQUES, SEQUENCES, AND PROCEDURES USED TO DO THE WORK OR THE SAFETY ASPECTS OF CONSTRUCTION, AND NOTHING ON THIS DRAWING EXPRESSED OR IMPLIED CHANGES THIS CONDITION. CONTRACTOR SHALL BE RESPONSIBLE FOR KNOWING HOW THEY AFFECT THE WORK. SUBMITTAL OF A BID TO PERFORM THIS WORK IS AN ACKNOWLEDGEMENT OF THESE RESPONSIBILITIES, AND THAT THEY HAVE BEEN FULLY CONSIDERED IN PLANNING OF THE WORK,


AND THE BID PRICE. NO CLAIMS FOR EXTRA CHARGES DUE TO THESE CONDITIONS WILL BE FORTHCOMING.



DATE: JANUARY 14, 202	2.5
PROJECT NO: 2023-10.0	)4
DRAWN BY	SDS
CHECKED BY	JLM
SUBMISSION	DATE
BID SET	01/14/2025
REVISION	DATE

DRAWING TITLE:

STRUCTURAL **SCHEDULES** 

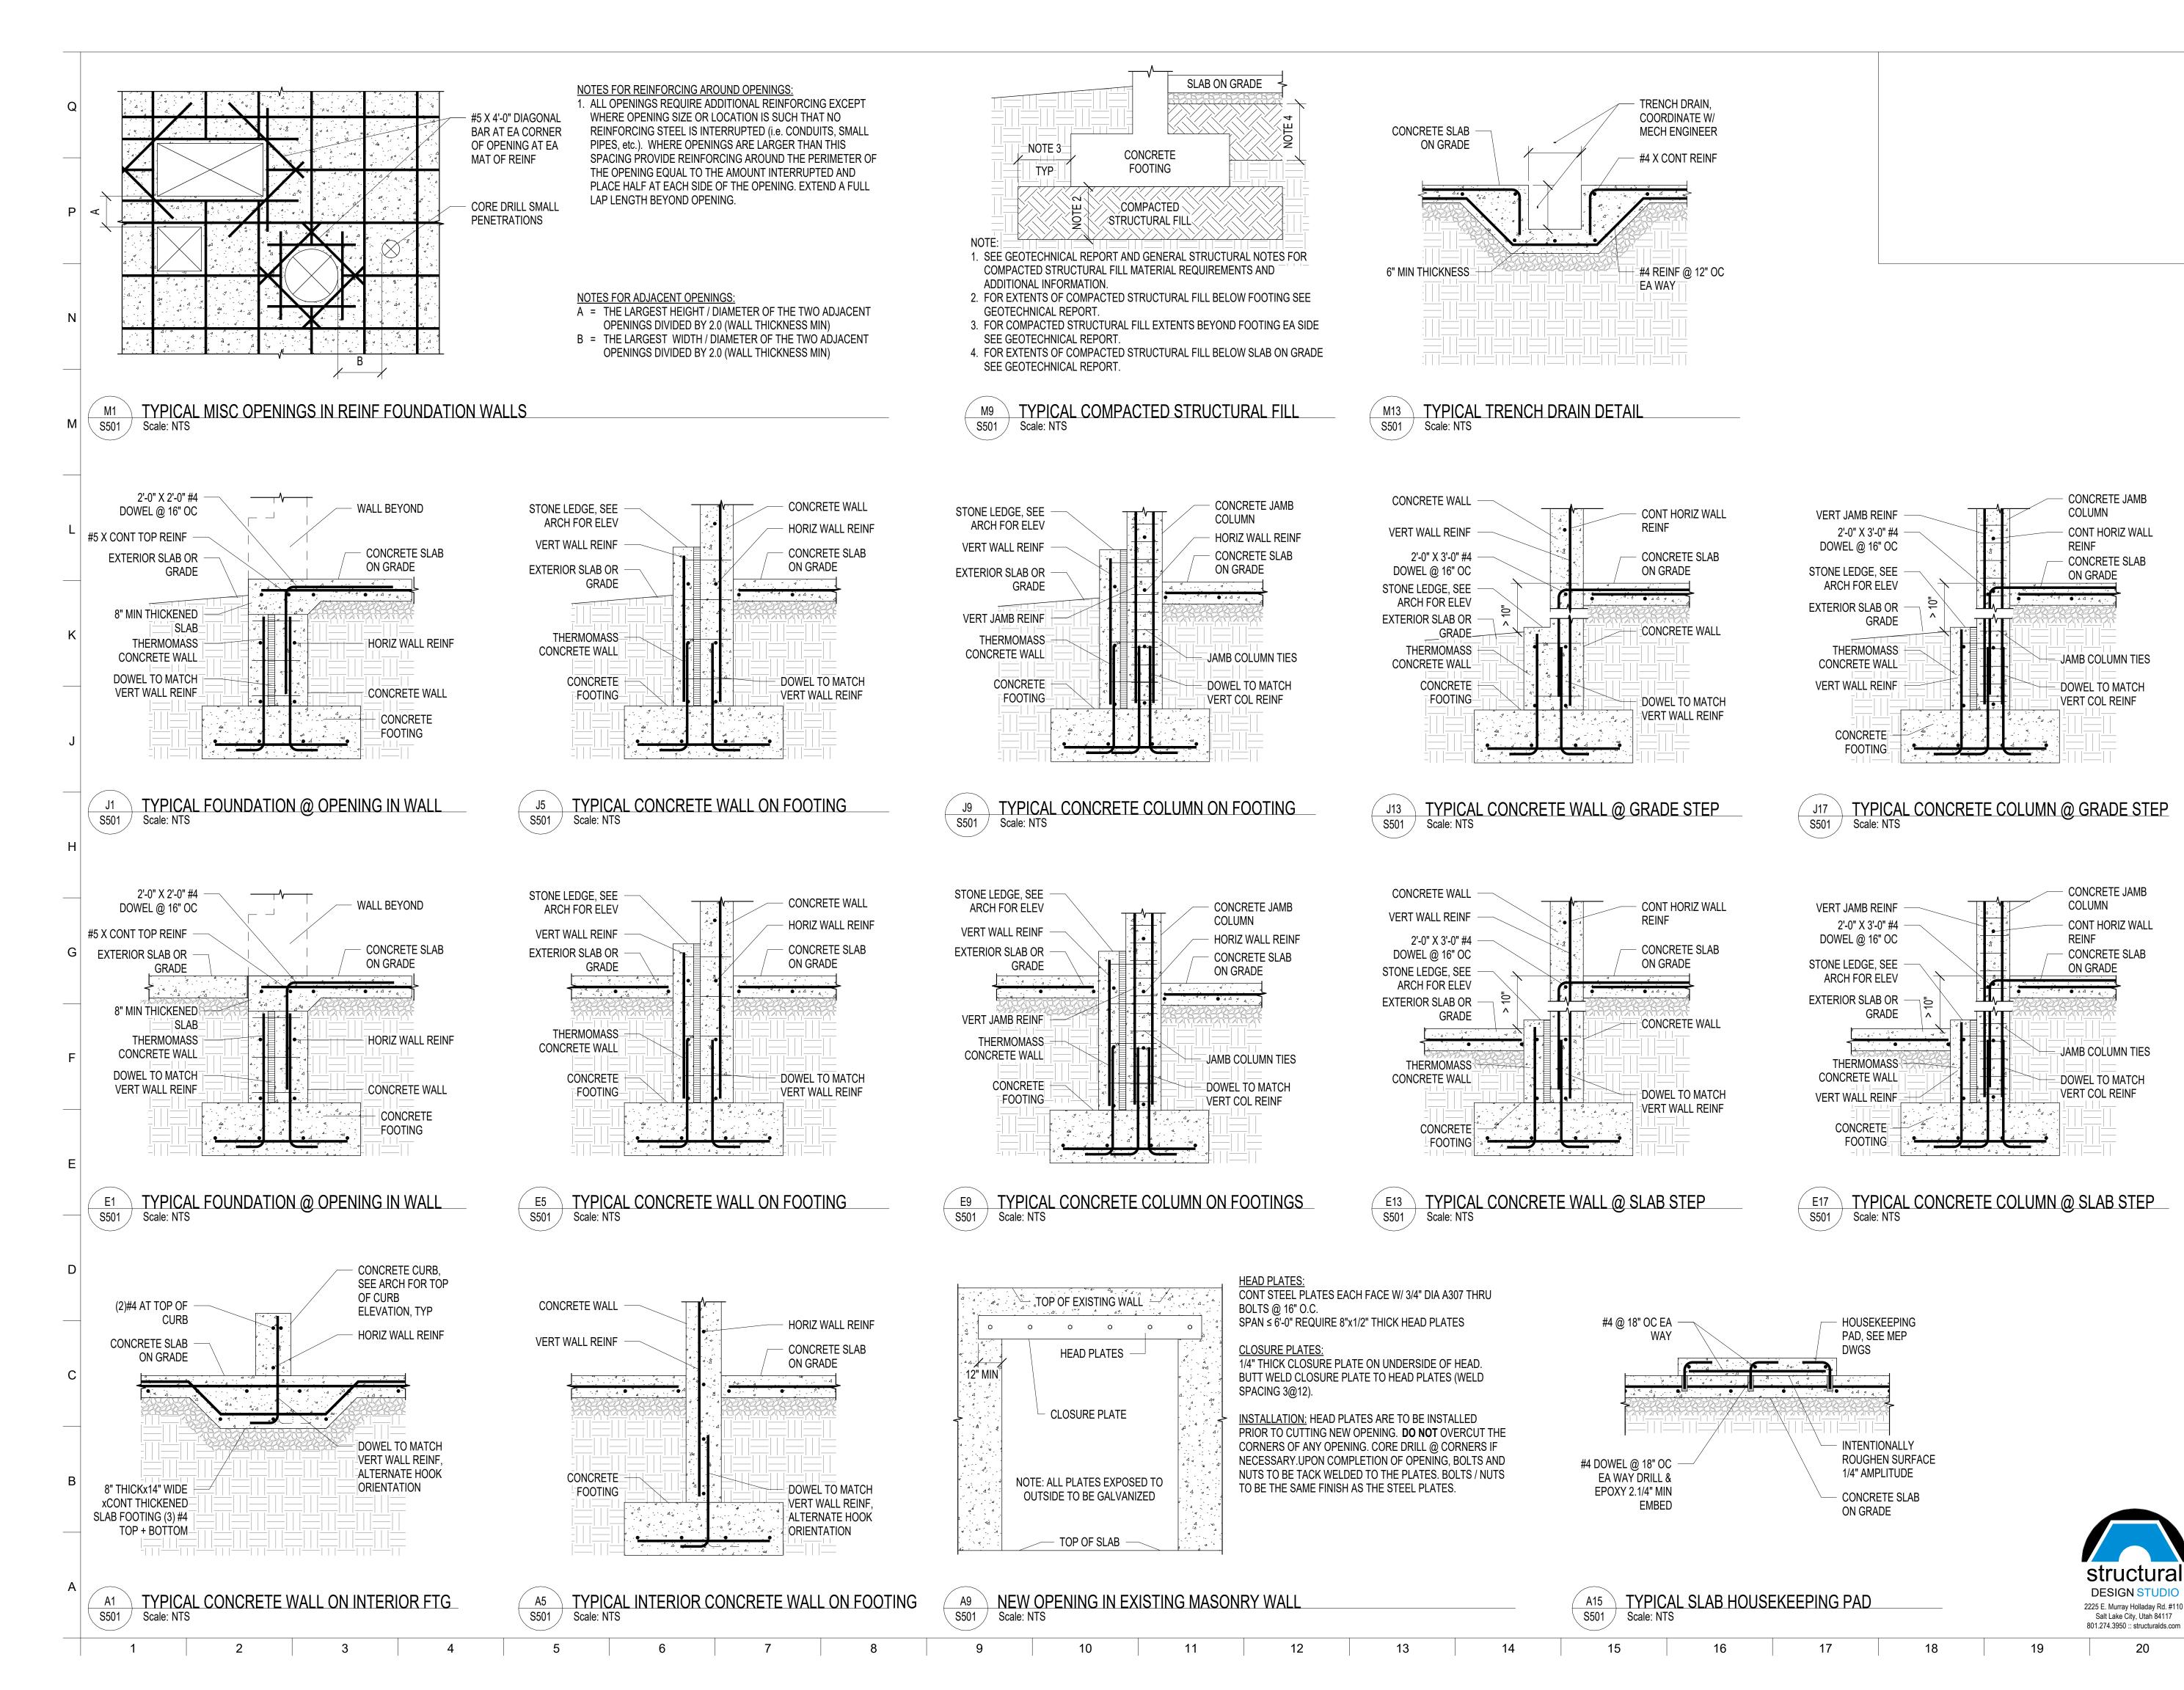

ВКР

PROJECT TEAM:

ARCHITECT:
BUELL KRATZER POWELL, P.C.
1525 LOCUST STREET
PHILADELPHIA, PA 19102
T: 215.557.6509

CIVIL ENGINEER: CARROLL ENGINEERING, INC 215 SCHILLING CIRCLE, STE 102 HUNT VALLEY, MD 21031 T: 410.785.7423

LANDSCAPE ARCHITECT:
ROBINSON ANDERSON SUMMERS
28 WEST STATE STREET
MEDIA, PA 19063
T: 302.888.1544

STRUCTURAL ENGINEER: STRUCTURAL DESIGN STUDIO, INC 2225 EAST MURRAY HOLLADAY RD SALT LAKE CITY. UT 84117

T: 801.274.3950

MEP ENGINEER:
KOVACS, WHITNEY & ASSOCIATES
190 WEST OSTEND ST, STE 300

7.00, WITHET W/100001/1120 90 WEST OSTEND ST, STE 300 BALTIMORE, MD 21230 T: 410.244.7191

CLIENT:

MARYLAND ZQQ

THE MARYLAND ZOO IN BALTIMORE
1 SAFARI PLACE

BALTIMORE, MD 21217

HE MARYLAND ZOO IN BALTIMORE 1 SAFARI PLACE LTIMORE, MD 21217

THIS DRAWING IS TO ILLUSTRATE THE WORK TO BE DONE. THE ARCHITECT IS NOT RESPONSIBLE FOR THE MEANS, METHODS, TECHNIQUES, SEQUENCES, AND PROCEDURES USED TO DO THE WORK OR THE SAFETY ASPECTS OF CONSTRUCTION, AND NOTHING ON THIS DRAWING EXPRESSED OR IMPLIED CHANGES THIS CONDITION. CONTRACTOR SHALL BE RESPONSIBLE FOR KNOWING HOW THEY AFFECT THE WORK. SUBMITTAL OF A BID TO PERFORM THIS WORK IS AN ACKNOWLEDGEMENT OF THESE RESPONSIBILITIES, AND THAT THEY HAVE BEEN FULLY CONSIDERED IN PLANNING OF THE WORK, AND THE BID PRICE. NO CLAIMS FOR EXTRA CHARGES DUE TO THESE CONDITIONS WILL BE FORTHCOMING.

SEAL




DATE: JANUARY 14, 202	5
PROJECT NO: 2023-10.0	4
DRAWN BY	SDS
CHECKED BY	JLM
SUBMISSION	DATE
BID SET	01/14/2025
REVISION	DATE

DRAWING TITLE:

STRUCTURAL
FOUNDATION DETAILS

DRAWING NO:

S501

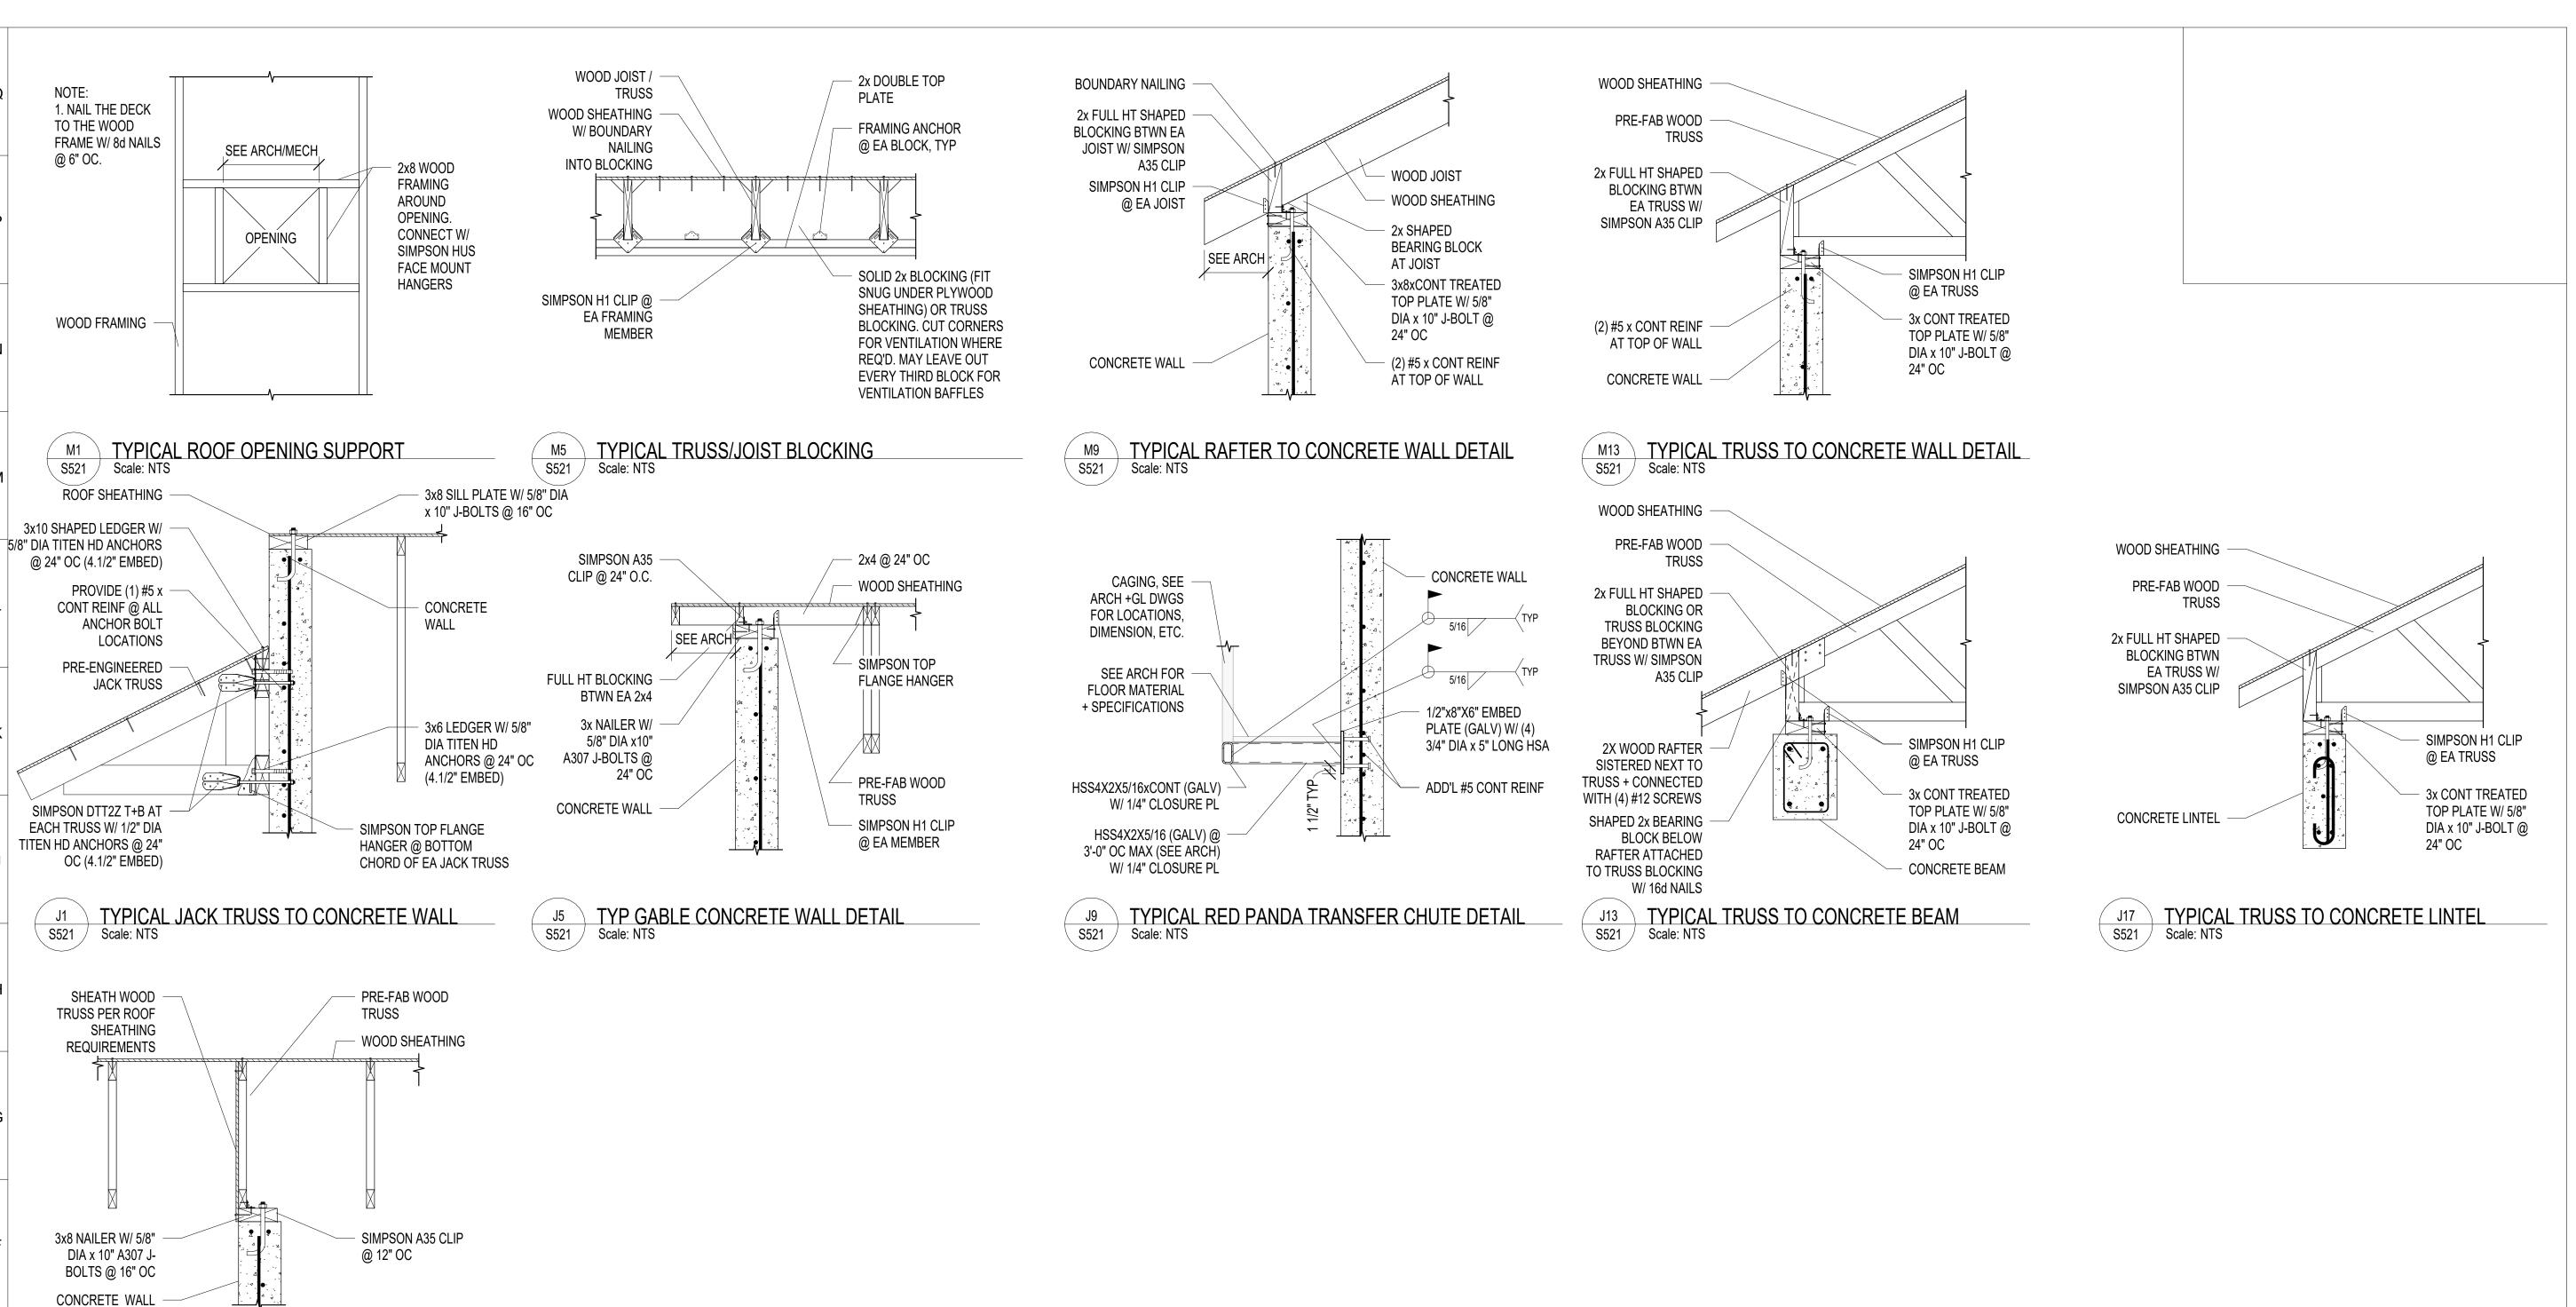

TYP DRAG TRUSS TO CONCRETE WALL DETAIL

S521 Scale: NTS

BKP

PROJECT TEAM:

ARCHITECT:
BUELL KRATZER POWELL, P.C.
1525 LOCUST STREET
PHILADELPHIA, PA 19102
T: 215.557.6509

CIVIL ENGINEER:
CARROLL ENGINEERING, INC
215 SCHILLING CIRCLE, STE 102
HUNT VALLEY, MD 21031

T: 410.785.7423

LANDSCAPE ARCHITECT:
ROBINSON ANDERSON SUMMERS
28 WEST STATE STREET
MEDIA, PA 19063
T: 302.888.1544

STRUCTURAL ENGINEER: STRUCTURAL DESIGN STUDIO, INC 2225 EAST MURRAY HOLLADAY RD SALT LAKE CITY, UT 84117 T: 801.274.3950

MEP ENGINEER:
KOVACS, WHITNEY & ASSOCIATES
190 WEST OSTEND ST, STE 300

BALTIMORE, MD 21230

T: 410.244.7191

CLIENT:

MARYLAND ZOO

THE MARYLAND ZOO IN BALTIMORE

1 SAFARI PLACE

BALTIMORE, MD 21217

RED PANDA

IE MARYLAND 200
IN BALTIMORE
1 SAFARI PLACE
LTIMORE, MD 21217

THIS DRAWING IS TO ILLUSTRATE THE WORK TO BE DONE. THE ARCHITECT IS NOT RESPONSIBLE FOR THE MEANS, METHODS, TECHNIQUES, SEQUENCES, AND PROCEDURES USED TO DO THE WORK OR THE SAFETY ASPECTS OF CONSTRUCTION, AND NOTHING ON THIS DRAWING EXPRESSED OR IMPLIED CHANGES THIS CONDITION. CONTRACTOR SHALL BE RESPONSIBLE FOR KNOWING HOW THEY AFFECT THE WORK. SUBMITTAL OF A BID TO PERFORM THIS WORK IS AN ACKNOWLEDGEMENT OF THESE RESPONSIBILITIES, AND THAT THEY HAVE BEEN FULLY CONSIDERED IN PLANNING OF THE WORK.

AND THE BID PRICE. NO CLAIMS FOR EXTRA CHARGES DUE TO THESE CONDITIONS WILL BE FORTHCOMING.

SEAL



DATE: JANUARY 14	, 2025				
PROJECT NO: 2023	3-10.04				
DRAWN BY SDS					
CHECKED BY	JLM				
SUBMISSION	DATE				
BID SET	01/14/2025				
REVISION	DATE				

DRAWING TITLE:
STRUCTURAL FRAMING


DRAWING NO:

S521

DETAILS

Structural
DESIGN STUDIO
2225 E. Murray Holladay Rd. #110
Salt Lake City, Utah 84117
801.274.3950 :: structuralds.com

22/25 E. Mutray Hot Salt Lakey Hot S

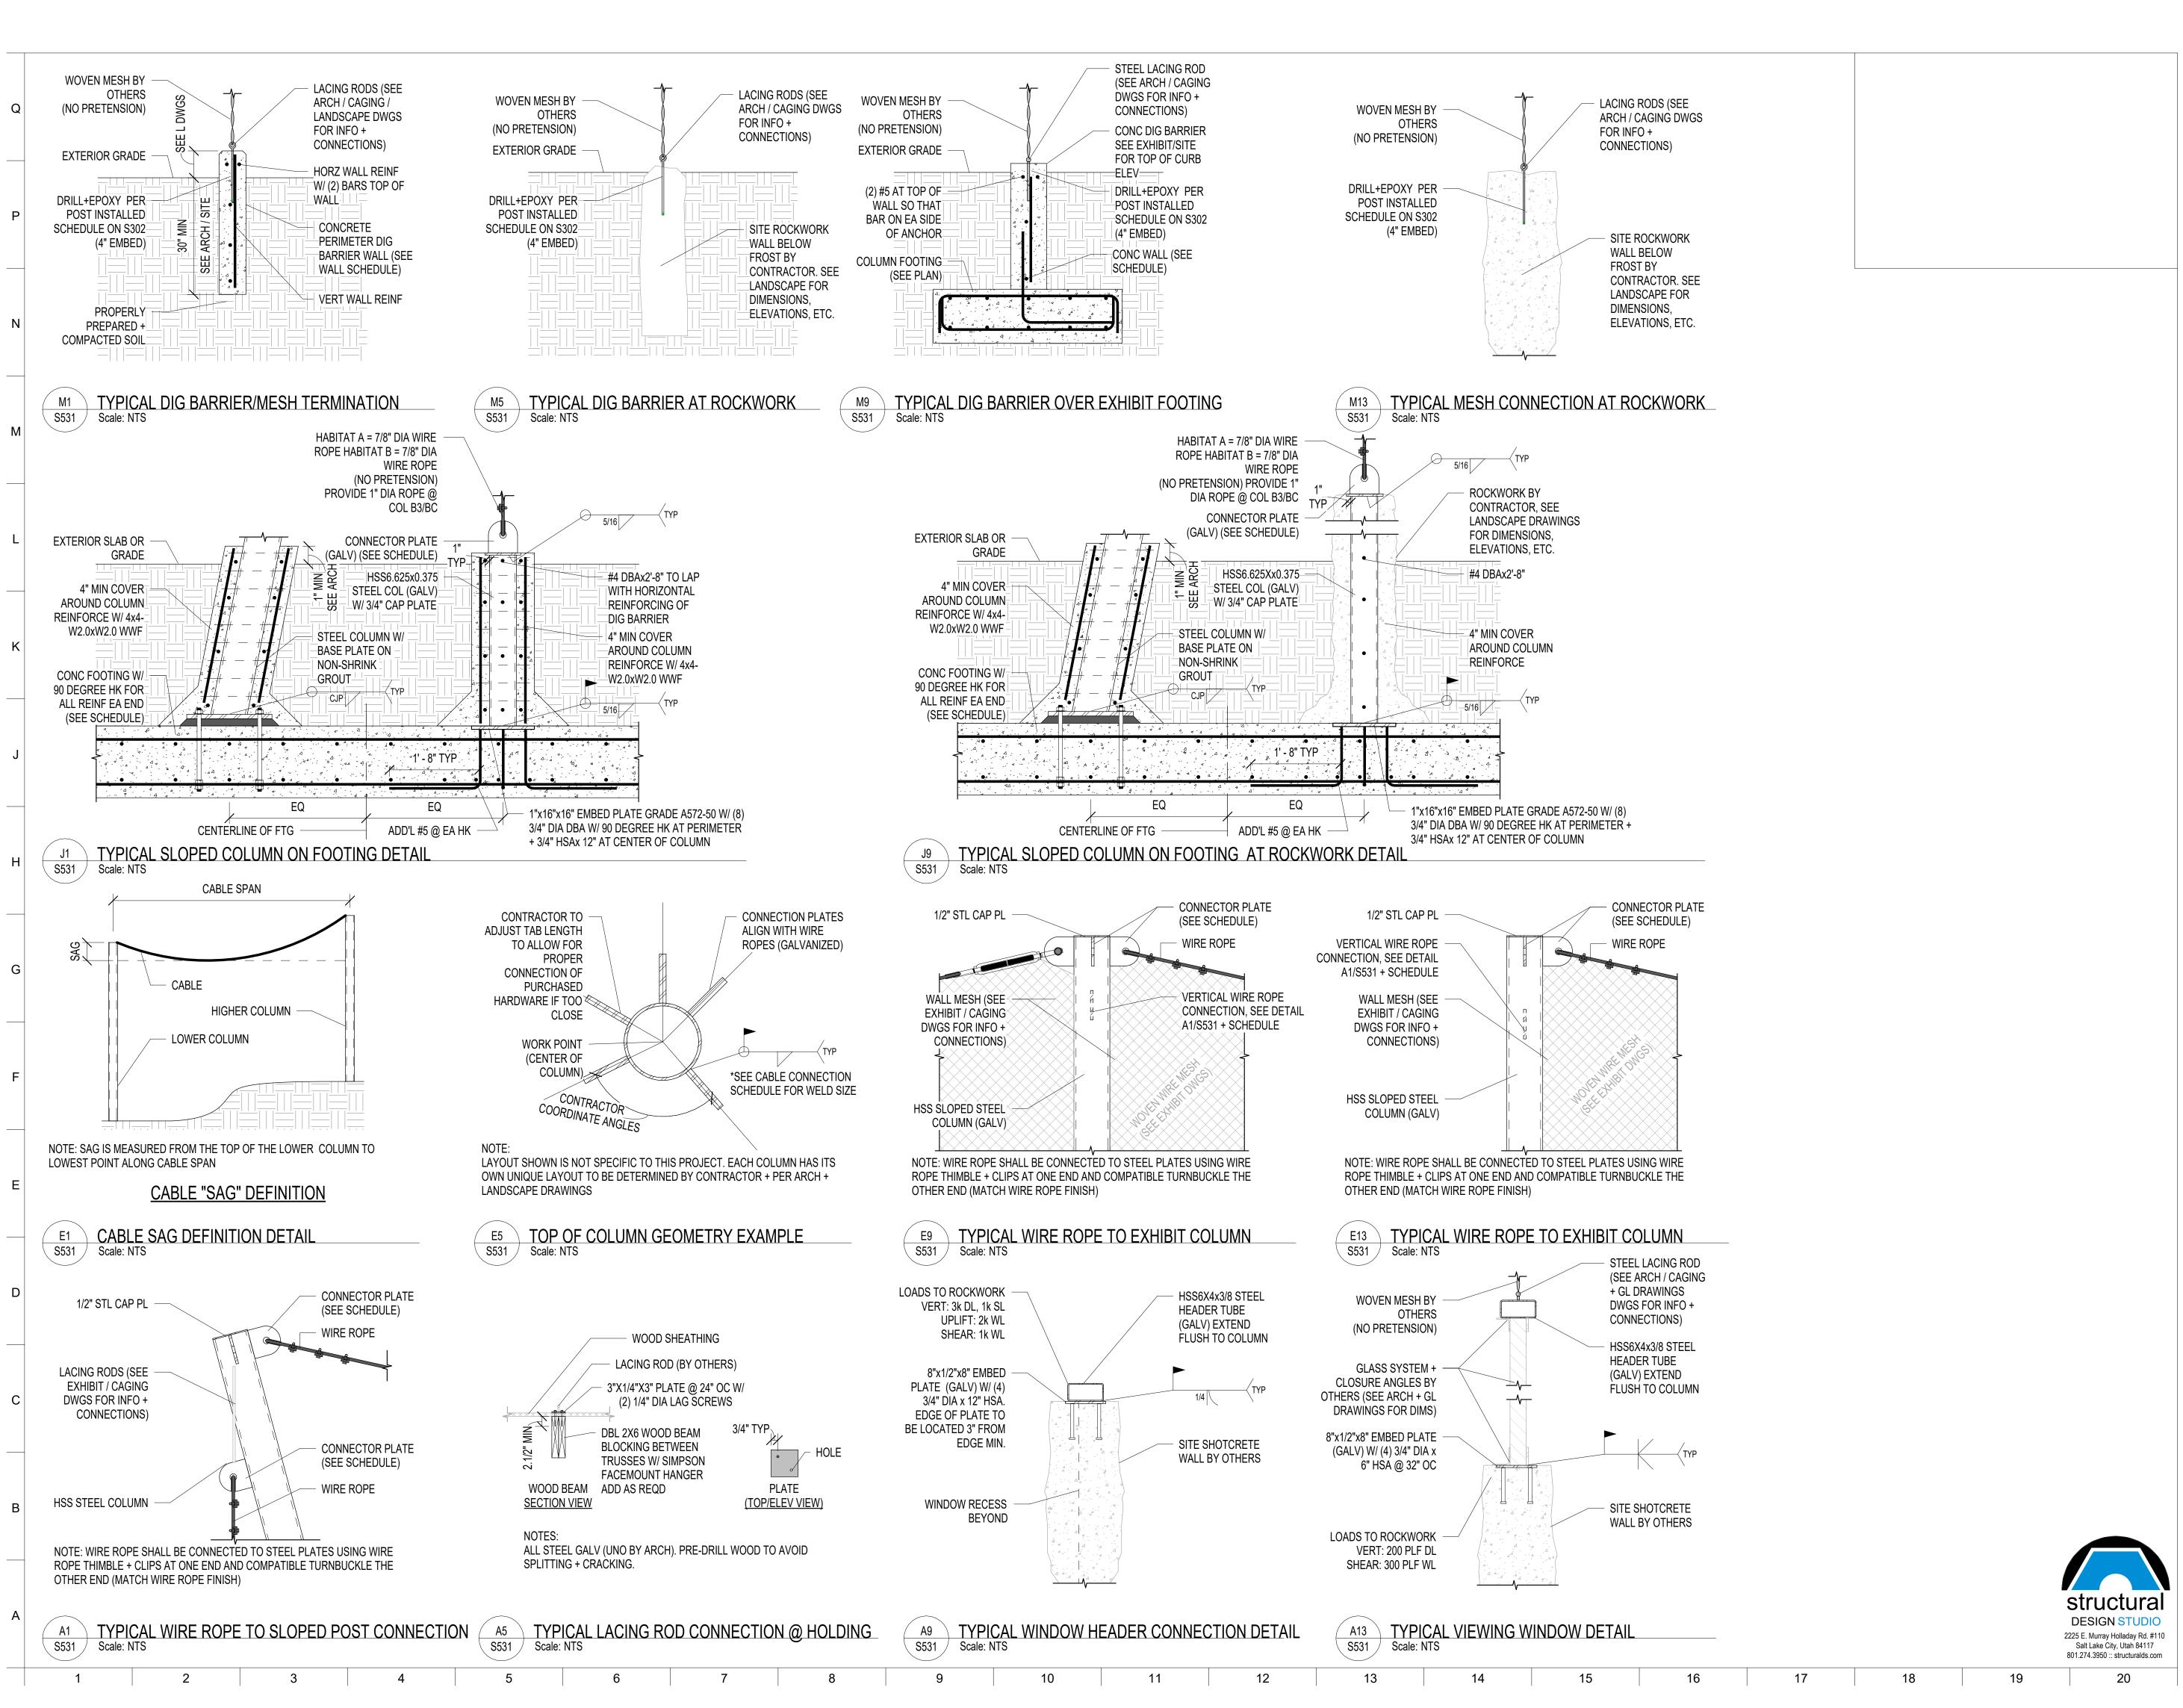

ВКР

PROJECT TEAM:

ARCHITECT:
BUELL KRATZER POWELL, P.C.
1525 LOCUST STREET
PHILADELPHIA, PA 19102
T: 215.557.6509

CIVIL ENGINEER:
CARROLL ENGINEERING, INC
215 SCHILLING CIRCLE, STE 102
HUNT VALLEY, MD 21031

T: 410.785.7423

LANDSCAPE ARCHITECT:
ROBINSON ANDERSON SUMMERS
28 WEST STATE STREET
MEDIA, PA 19063

T: 302.888.1544

STRUCTURAL ENGINEER:
RUCTURAL DESIGN STUDIO,

STRUCTURAL DESIGN STUDIO, INC 2225 EAST MURRAY HOLLADAY RD SALT LAKE CITY, UT 84117 T: 801.274.3950

MEP ENGINEER:
KOVACS, WHITNEY & ASSOCIATES
190 WEST OSTEND ST, STE 300
BALTIMORE, MD 21230
T: 410.244.7191

CLIENT:

## MARYLAND ZQO

THE MARYLAND ZOO IN BALTIMORE

1 SAFARI PLACE

BALTIMORE, MD 21217


RED PANDA

THE MARYLAND 200
IN BALTIMORE
1 SAFARI PLACE
ALTIMORE, MD 21217

THIS DRAWING IS TO ILLUSTRATE THE WORK TO BE DONE. THE ARCHITECT IS NOT RESPONSIBLE FOR THE MEANS, METHODS, TECHNIQUES, SEQUENCES, AND PROCEDURES USED TO DO THE WORK OR THE SAFETY ASPECTS OF CONSTRUCTION, AND NOTHING ON THIS DRAWING EXPRESSED OR IMPLIED CHANGES THIS CONDITION. CONTRACTOR SHALL B. RESPONSIBLE FOR KNOWING HOW THEY AFFECT THE WORK. SUBMITTAL OF A BID TO PERFORM THIS WORK IS AN ACKNOWLEDGEMENT OF THESE RESPONSIBILITIES, AND THAT THEY HAVE BEEN FULLY CONSIDERED IN PLANNING OF THE WORK.

THESE CONDITIONS WILL BE FORTHCOMING.

SEAL

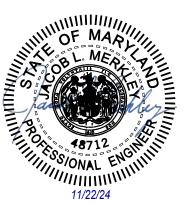


DATE: JANUARY 14, 202	5
PROJECT NO: 2023-10.0	4
DRAWN BY	SDS
CHECKED BY	JLM
SUBMISSION	DATE
BID SET	01/14/202
REVISION	DATE

DRAWING TITLE:

EXHIBIT STRUCTURAL DETAILS

DRAWING NO:

S531

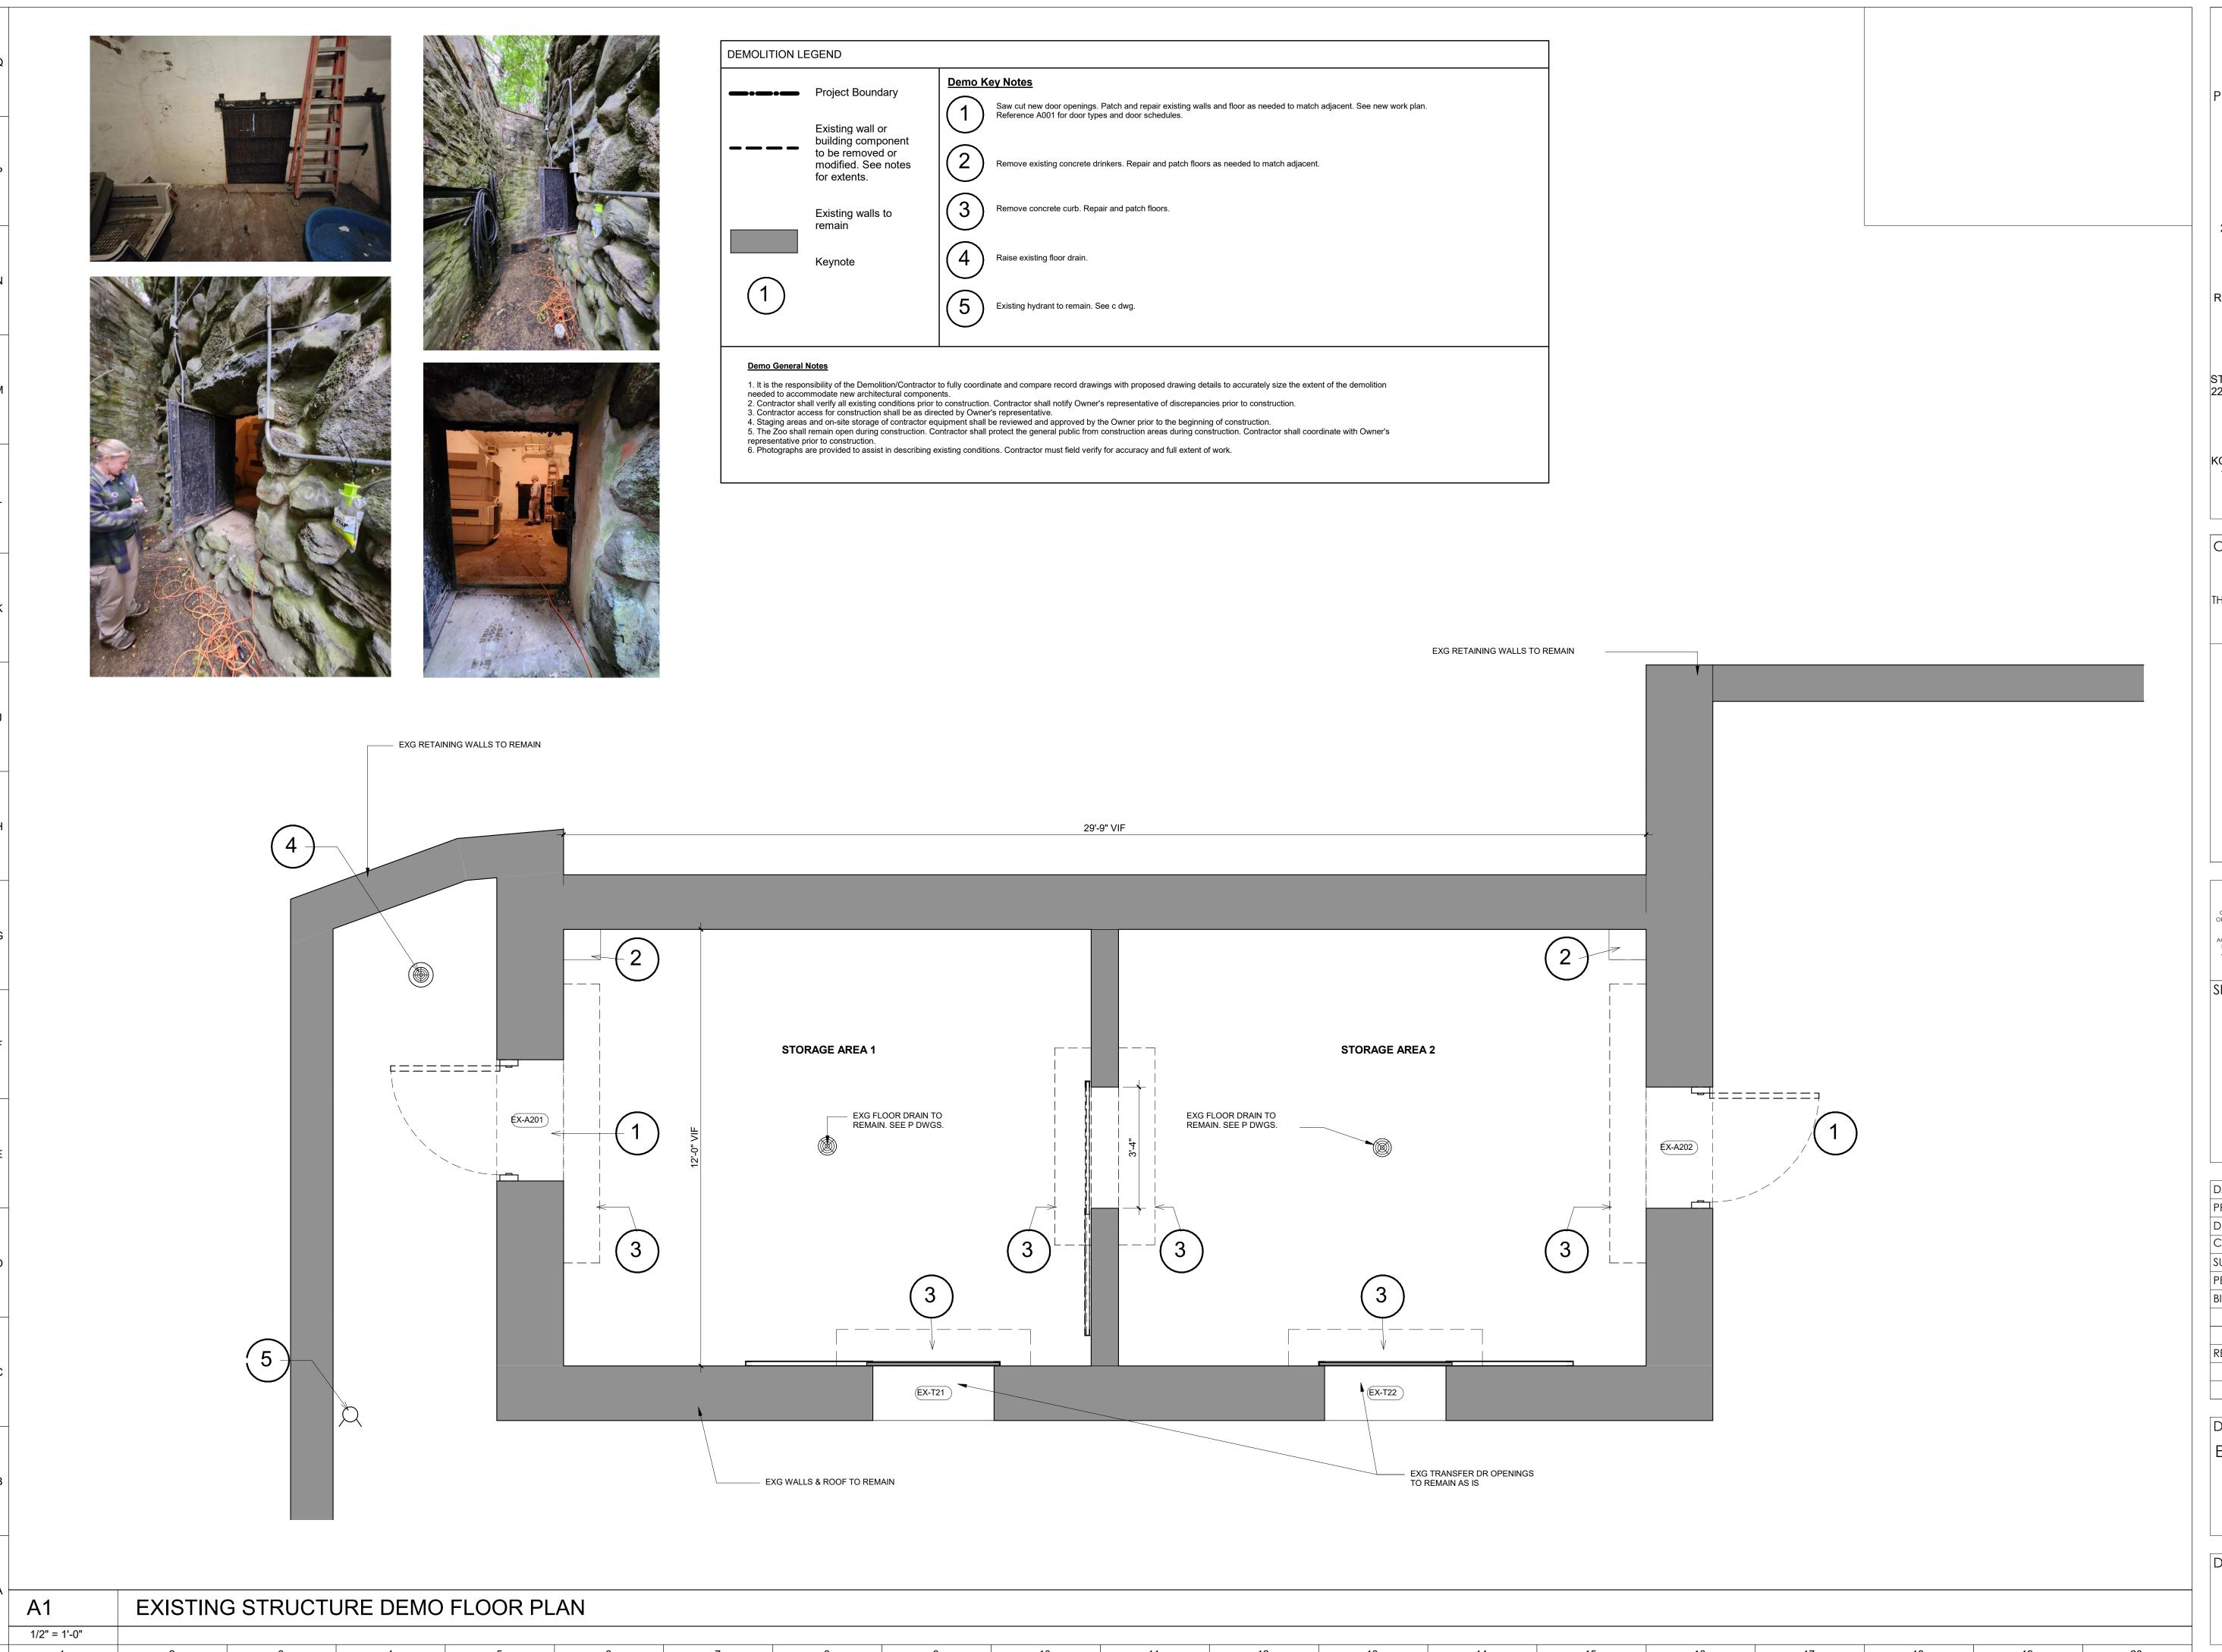



ARCHITECT:
BUELL KRATZER POWELL, P.C.
1525 LOCUST STREET
PHILADELPHIA, PA 19102
T: 215.557.6509

CIVIL ENGINEER:
CARROLL ENGINEERING, INC
215 SCHILLING CIRCLE, STE 102
HUNT VALLEY, MD 21031
T: 410.785.7423

LANDSCAPE ARCHITECT:
ROBINSON ANDERSON SUMMERS
28 WEST STATE STREET
MEDIA, PA 19063
T: 302.888.1544

STRUCTURAL ENGINEER: STRUCTURAL DESIGN STUDIO, INC 2225 EAST MURRAY HOLLADAY RD SALT LAKE CITY, UT 84117 T: 801.274.3950

MEP ENGINEER:
KOVACS, WHITNEY & ASSOCIATES
190 WEST OSTEND ST, STE 300
BALTIMORE, MD 21230
T: 410.244.7191

CLIENT:


## MARYLAND ZQO

THE MARYLAND ZOO IN BALTIMORE
1 SAFARI PLACE
BALTIMORE, MD 21217

RED PANDA

HE MARYLAND ZOO
IN BALTIMORE
1 SAFARI PLACE

THIS DRAWING IS TO ILLUSTRATE THE WORK TO BE DONE. THE ARCHITECT IS NOT RESPONSIBLE FOR THE MEANS, METHODS, TECHNIQUES, SEQUENCES, AND PROCEDURES USED TO DO THE WORK OR THE SAFETY ASPECTS OF CONSTRUCTION, AND NOTHING ON THIS DRAWING EXPRESSED OR IMPUED CHANGES THIS CONDITION, CONTRACTOR SHALL BE RESPONSIBLE FOR KNOWING HOW THEY AFFECT THE WORK. SUBMITTAL OF A BID TO PERFORM THIS WORK IS AN ACKNOWLEDGEMENT OF THESE RESPONSIBILITIES, AND THAT THEY HAVE BEEN FULLY CONSIDERED IN PLANNING OF THE WORK, AND THE BID PRICE. NO CLAIMS FOR EXTRA CHARGES DUE TO THESE CONDITIONS WILL BE FORTHCOMING.

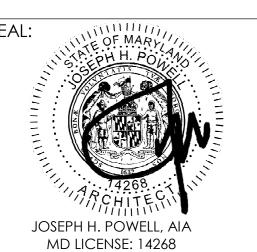


DATE: JANUARY 14, 2025	
PROJECT NO: 2023-10.04	
DRAWN BY	CC
CHECKED BY	JS
SUBMISSION	DATE
PERMIT SET	11/22/2024
BID SET	01/14/2025
REVISION	DATE

DRAWING TITLE:

EXG STRUCTURE DEMO
FLOOR PLAN

DRAWING NO:

AD210

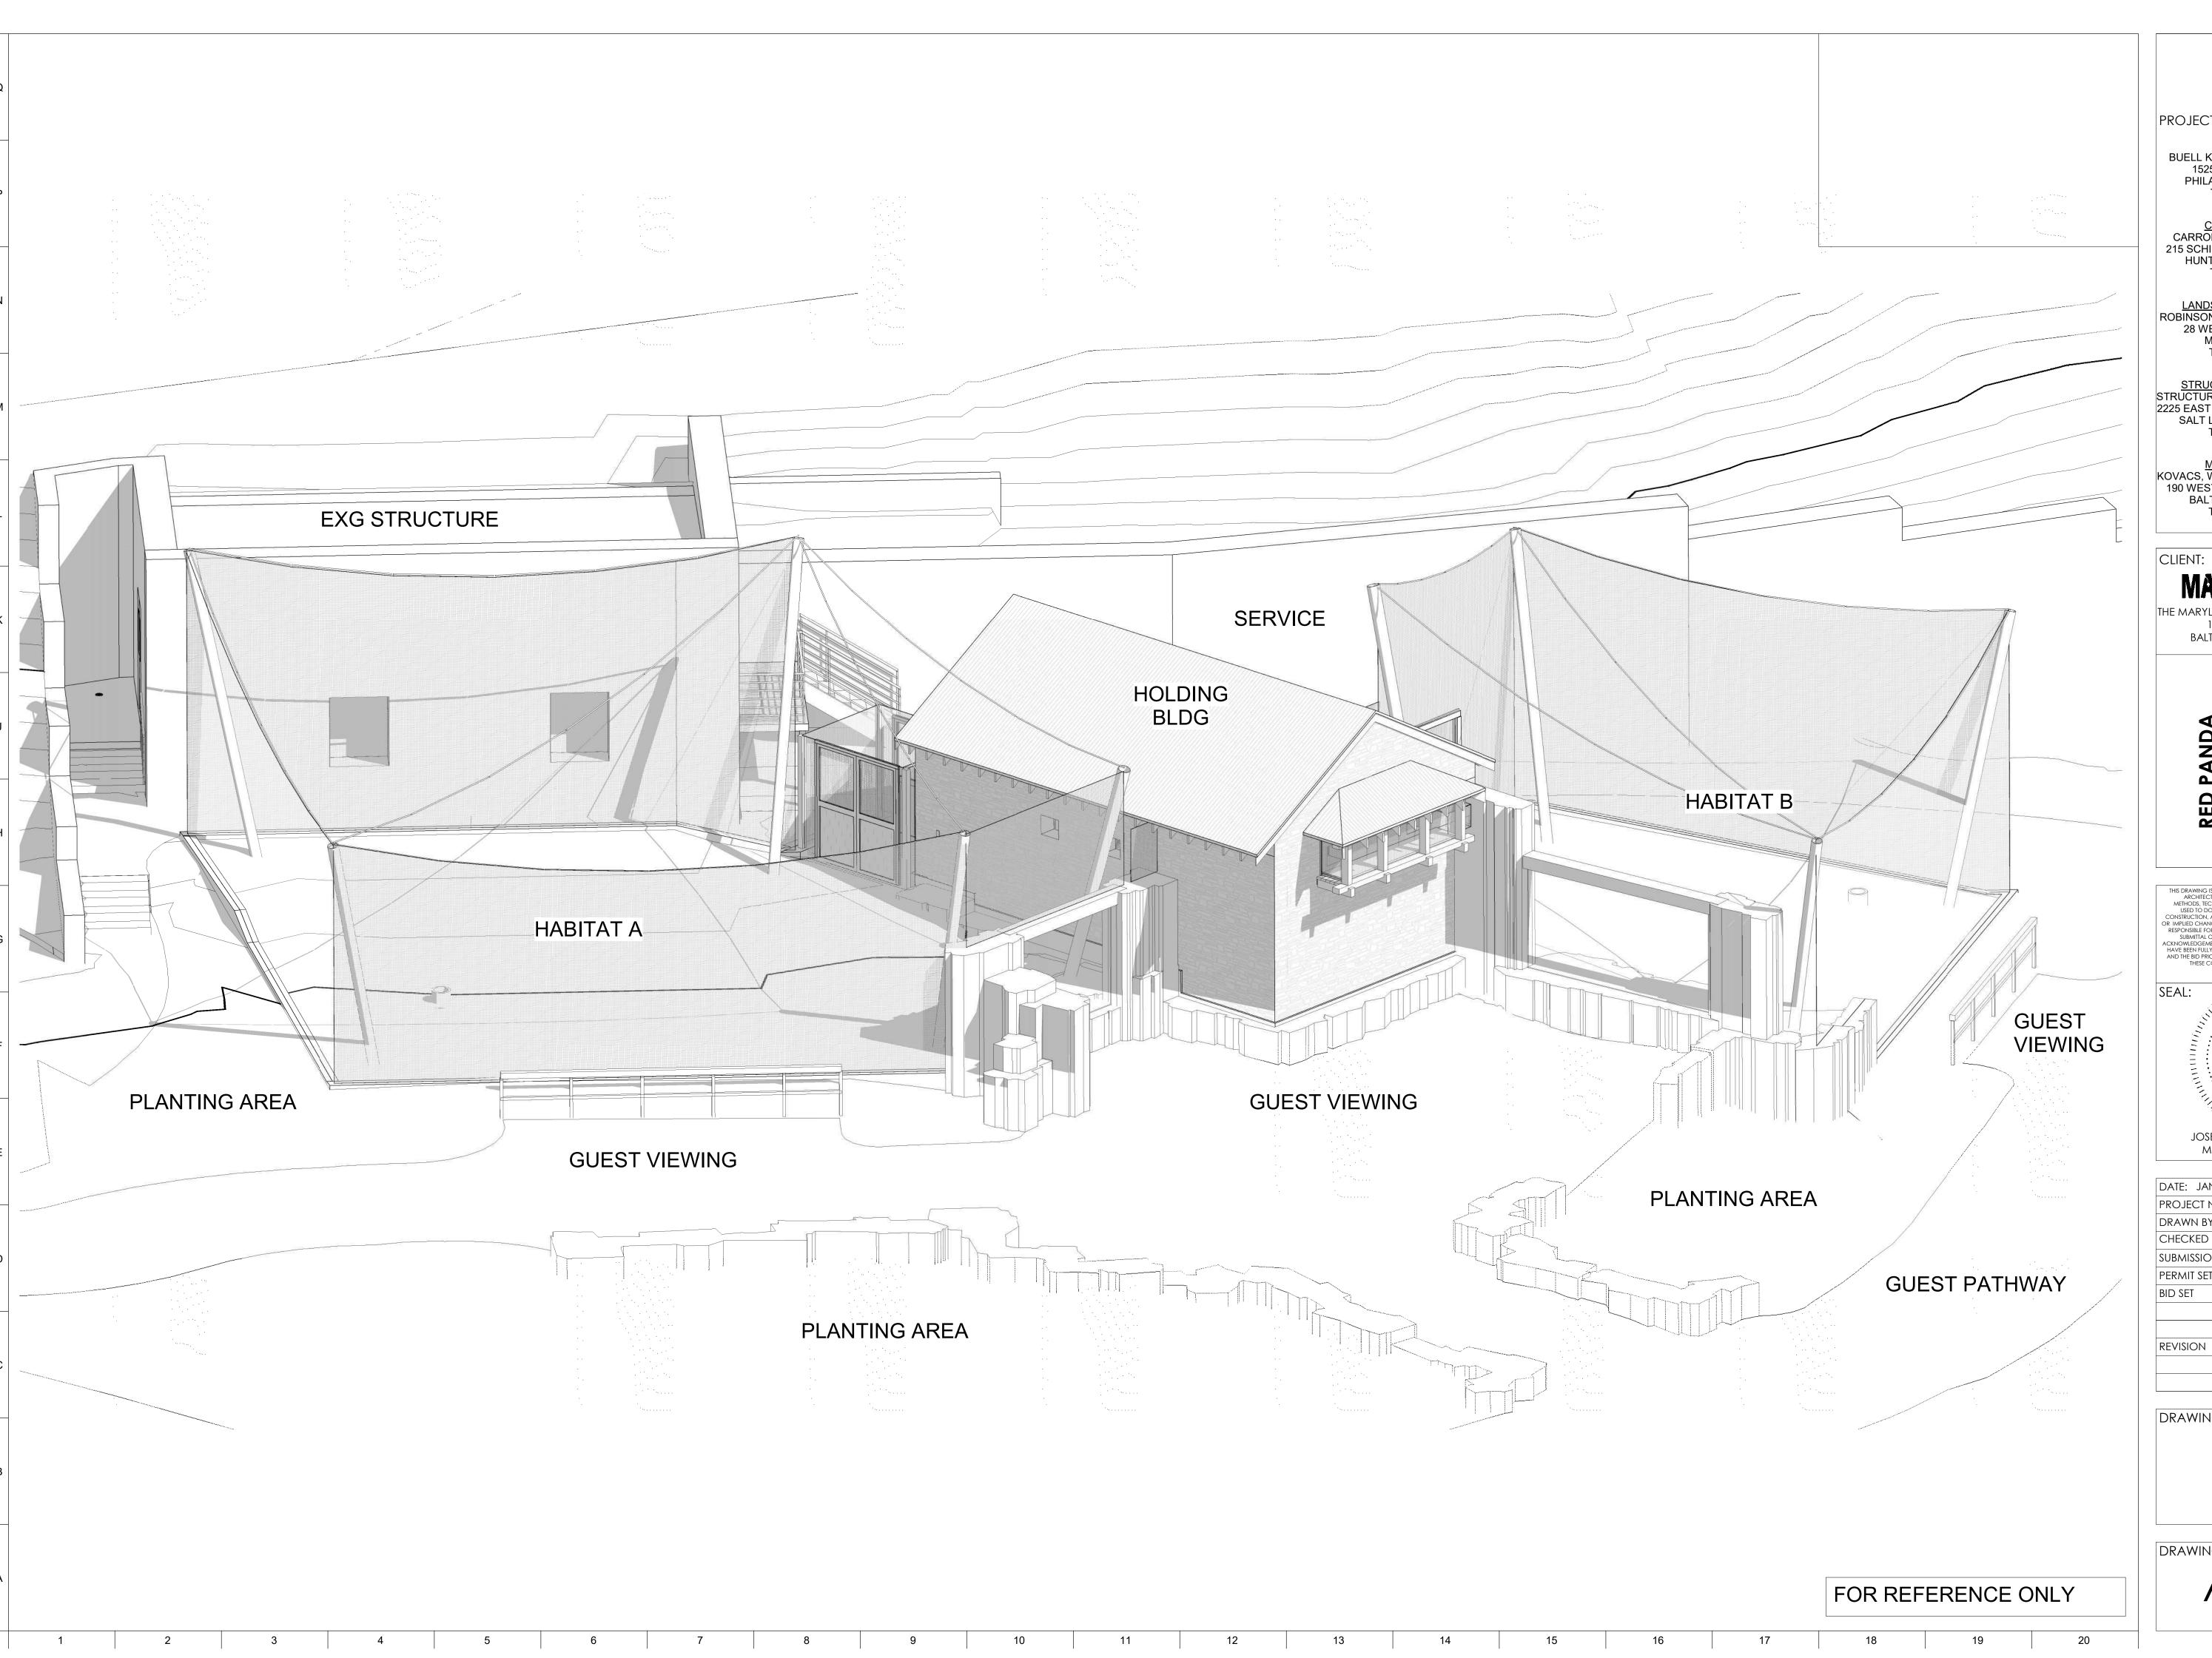



ARCHITECT:
BUELL KRATZER POWELL, P.C.
1525 LOCUST STREET
PHILADELPHIA, PA 19102
T: 215.557.6509

CIVIL ENGINEER:
CARROLL ENGINEERING, INC
215 SCHILLING CIRCLE, STE 102
HUNT VALLEY, MD 21031
T: 410.785.7423

LANDSCAPE ARCHITECT:
ROBINSON ANDERSON SUMMERS
28 WEST STATE STREET
MEDIA, PA 19063
T: 302.888.1544

STRUCTURAL ENGINEER: STRUCTURAL DESIGN STUDIO, INC 2225 EAST MURRAY HOLLADAY RD SALT LAKE CITY, UT 84117 T: 801.274.3950

MEP ENGINEER:
KOVACS, WHITNEY & ASSOCIATES
190 WEST OSTEND ST, STE 300
BALTIMORE, MD 21230
T: 410.244.7191


# MARYLAND ZQO

THE MARYLAND ZOO IN BALTIMORE

1 SAFARI PLACE

BALTIMORE, MD 21217

THIS DRAWING IS TO ILLUSTRATE THE WORK TO BE DONE. THE ARCHITECT IS NOT RESPONSIBLE FOR THE MEANS, METHODS, TECHNIQUES, SEQUENCES, AND PROCEDURES USED TO DO THE WORK OR THE SAFETY ASPECTS OF CONSTRUCTION, AND NOTHING ON THIS DRAWING EXPRESSED OR IMPLIED CHANGES THIS CONDITION. CONTRACTOR SHALL BE RESPONSIBLE FOR KNOWING HOW THEY AFFECT THE WORK. SUBMITTAL OF A BID TO PERFORM THIS WORK IS AN ACKNOWLEDGEMENT OF THESE RESPONSIBILITIES, AND THAT THEY HAVE BEEN FULLY CONSIDERED IN PLANNING OF THE WORK, AND THE BID PRICE. NO CLAIMS FOR EXTRA CHARGES DUE TO THESE CONDITIONS WILL BE FORTHCOMING.

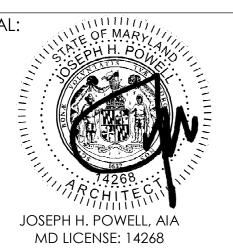

DATE: JANUARY 14, 2025	
PROJECT NO: 2023-10.04	
DRAWN BY	CC
CHECKED BY	JS
SUBMISSION	DATE
PERMIT SET	11/22/2024
BID SET	01/14/2025
DEV/ISIONI	DATE

DRAWING TITLE: 3D VIEW

DRAWING NO:

HOLDING BUILDING DOOR SCHEDULE									
	ROUGH O	PENING	DOOR		FRAME				
DOOR NO.	WIDTH	HEIGHT	MATERIAL	FINISH	MATERIAL	FINISH	NOTES		
		·	·	·	·				
A001	3' - 4"	7' - 4"	FRP	PNT	FRP	PNT	WDW LITE		
A002	3' - 4"	7' - 4"	FRP	PNT	FRP	PNT	WDW LITE		
A003	3' - 4"	7' - 4"	FRP	PNT	FRP	PNT	LOUVER		

NEW DOOR HARDWARE MATRIX										
DOOR#	CONT. HINGE	LOCKSET(OFF ICE)	LOCKSET (STOREROOM)	CYLINDER	CLOSER	WALL STOP	GASKETING	DRIP	SWEEP	THRESHOLD
A001	X	X		X	X		X	X	X	X
A002	X	X		X	X		Х	X	Х	X
A003	X	X		Х	X	Х	Х	Χ	Х	X
A201	Х		X	X	Х		X	Х	Х	X
A202	Х		X	X	Х		X	X	Х	X
	•	•			•	•			•	•

NTS

REFER TO SPECIFICATIONS FOR ADDITIONAL INFORMATION. REFER TO CAGING GENERAL REQUIREMENTS CG001 FOR ANIMAL TRANSFER DOORS AND KEEPER DOORS.

## BASIS-OF-DESIGN PRODUCTS:

- CONTINUOUS HINGE PEMKO FM\_HD1
- LOCKSET (OFFICE) BEST 45H7A3S LOCKSET (STOREROOM) BEST 45H7D3S
- CYLINDER BEST
- CLOSER LCN 4030-3077CNS (CUSH)
  WALL STOP ROCKWOOD 474
- GASKETING PEMKO 305\_S DRIP - PEMKO 346C (FULL WIDTH + 2")
- SWEEP PEMKO 29326CV THRESHOLD - PEMKO 252X5AFG (FULL WIDTH + 2")

FRP

40	
.10	DOOR HARDWARE MATRIX AND BASIS-OF-DESIGN

<del>_</del> -	
NTS	

7' - 4"

REFER TO SPECIFICATIONS FOR ADDITIONAL INFORMATION.
REFER TO CAGING GENERAL REQUIREMENTS CG001 FOR ANIMAL
TRANSFER DOORS AND KEEPER DOORS.

	ROUGH O	PENING	DOOR		FRAME		
DOOR NO.	WIDTH	HEIGHT	MATERIAL	FINISH	MATERIAL	FINISH	NOTES

FRP

## NOTES:

A202

- REFER TO SPECIFICATIONS FOR ADDITIONAL INFORMATION.
  REFER TO CAGING GENERAL REQUIREMENTS CG001 FOR ANIMAL
  TRANSFER DOORS AND KEEPER DOORS.

3' - 4"

3'-4" J	3'-0"
ROUGH OPENING	FRAME OPENING
SONGH ODENING  WDW LITE  FINISH FLOOR  FRP DOOR & FRAME  ALL DOORS, UNO	2"  DOUVER  FRP DOOR & FRAME  DOOR A003

1. REFER TO SPECIFICATIONS FOR ADDITIONAL INFORMATION.

「  F1	DOOR SCHEDULE - EXISTING STRUCTURE	F10	DOOR AND FRAME TYPES
NTS		NTS	

PNT

WDW LITE

					FIN	IISH SCHEDU	LE							
OOM	1	FLOOR		WALLS								CEILING		
				NORTH		EAST		SOUTH		WEST				
Ο.	NAME	BASE	FINISH	MATERIAL	FINISH	MATERIAL	FINISH	MATERIAL	FINISH	MATERIAL	FINISH	MATERIAL	FINISH	NOTES
01	STALL 1	CLEAR PENETRATING SILICONE SEALER - 099600-3.6.B.1	CLEAR PENETRATING SILICONE SEALER - 099600-3.6.B.1	CONC	PNT - 099600-3.6.A.1	CONC	PNT - 099600-3.6.A.1	CAGING	SEE CG DWGS	CAGING	SEE CG DWGS	MARINE GRADE PLY	EPOXY - 099600-3.6.C.1	
)2	STALL 2	CLEAR PENETRATING SILICONE SEALER - 099600-3.6.B.1	CLEAR PENETRATING SILICONE SEALER - 099600-3.6.B.1	CAGING	SEE CG DWGS	CONC	PNT - 099600-3.6.A.1	CONC	PNT - 099600-3.6.A.1	CAGING	SEE CG DWGS	MARINE GRADE PLY	EPOXY - 099600-3.6.C.1	
03	STALL 3	CLEAR PENETRATING SILICONE SEALER - 099600-3.6.B.1	CLEAR PENETRATING SILICONE SEALER - 099600-3.6.B.1	CONC / CAGING	PNT - 099600-3.6.A.1	CAGING	SEE CG DWGS	CONC	PNT - 099600-3.6.A.1	CONC	PNT - 099600-3.6.A.1	MARINE GRADE PLY	EPOXY - 099600-3.6.C.1	
04	MECH	CLEAR PENETRATING SILICONE SEALER - 099600-3.6.B.1	CLEAR PENETRATING SILICONE SEALER - 099600-3.6.B.1	CONC	PNT - 099600-3.6.A.1	CONC	PNT - 099600-3.6.A.1	CONC	PNT - 099600-3.6.A.1	CONC	PNT - 099600-3.6.A.1	EXPOSED DECK	-	
05	KEEPER	CLEAR PENETRATING SILICONE SEALER - 099600-3.6.B.1	CLEAR PENETRATING SILICONE SEALER - 099600-3.6.B.1	CONC	PNT - 099600-3.6.A.1	CAGING	SEE CG DWGS	CAGING	SEE CG DWGS	CONC	PNT - 099600-3.6.A.1	MARINE GRADE PLY	EPOXY - 099600-3.6.C.1	
)1	STORAGE AREA 1	-	-	CONC	-	CONC	-	CONC	-	CONC	-	CONC	-	EXG TO REMAIN
)2	STORAGE AREA 2	-	-	CONC	-	CONC	-	CONC	-	CONC	-	CONC	-	EXG TO REMAIN

## FINISH SCHEDULE NOTES:

- ALL PAINT (PNT) NOTED IN THE FINISH SCHEDULE TO BE HPC [HIGH PERFORMANCE COATING] SPEC SECTION 099600-3.6.A.1.
- REFER TO SPECIFICATIONS FOR ADDITIONAL INFORMATION.

A  -	A1	FINISH S	CHEDULE																	
	NTS																			
	1	2	3	4	5	6	7	8	9	10	11	12	13	14	15	16	17	18	19	20



PROJECT TEAM:

<u>ARCHITECT:</u> BUELL KRATZER POWELL, P.C. 1525 LOCUST STREET PHILADELPHIA, PA 19102 T: 215.557.6509

**CIVIL ENGINEER:** CARROLL ENGINEERING, INC 215 SCHILLING CIRCLE, STE 102 HUNT VALLEY, MD 21031 T: 410.785.7423

LANDSCAPE ARCHITECT:
ROBINSON ANDERSON SUMMERS 28 WEST STATE STREET MEDIA, PA 19063 T: 302.888.1544


<u>STRUCTURAL ENGINEER:</u> STRUCTURAL DESIGN STUDIO, INC 2225 EAST MURRAY HOLLADAY RD SALT LAKE CITY, UT 84117 T: 801.274.3950

MEP ENGINEER: KOVACS, WHITNEY & ASSOCIATES 190 WEST OSTEND ST, STE 300 BALTIMORE, MD 21230 T: 410.244.7191

CLIENT:

THE MARYLAND ZOO IN BALTIMORE 1 SAFARI PLACE BALTIMORE, MD 21217

THIS DRAWING IS TO ILLUSTRATE THE WORK TO BE DONE. THE ARCHITECT IS NOT RESPONSIBLE FOR THE MEANS, METHODS, TECHNIQUES, SEQUENCES, AND PROCEDURES USED TO DO THE WORK OR THE SAFETY ASPECTS OF CONSTRUCTION, AND NOTHING ON THIS DRAWING EXPRESSED OR IMPLIED CHANGES THIS CONDITION. CONTRACTOR SHALL BE RESPONSIBLE FOR KNOWING HOW THEY AFFECT THE WORK. SUBMITTAL OF A BID TO PERFORM THIS WORK IS AN ACKNOWLEDGEMENT OF THESE RESPONSIBILITIES, AND THAT THEY HAVE BEEN FULLY CONSIDERED IN PLANNING OF THE WORK, AND THE BID PRICE. NO CLAIMS FOR EXTRA CHARGES DUE TO THESE CONDITIONS WILL BE FORTHCOMING.

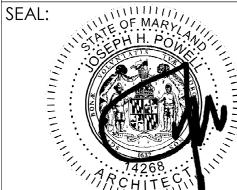


JOSEPH H. POWELL, AIA MD LICENSE: 14268 DATE: JANUARY 14, 2025 PROJECT NO: 2023-10.04 DRAWN BY CHECKED BY SUBMISSION DATE

11/22/2024 PERMIT SET 01/14/2025 BID SET REVISION DATE

DRAWING TITLE:

DOOR & FINISH SCHEDULES, DOOR & FRAME TYPES

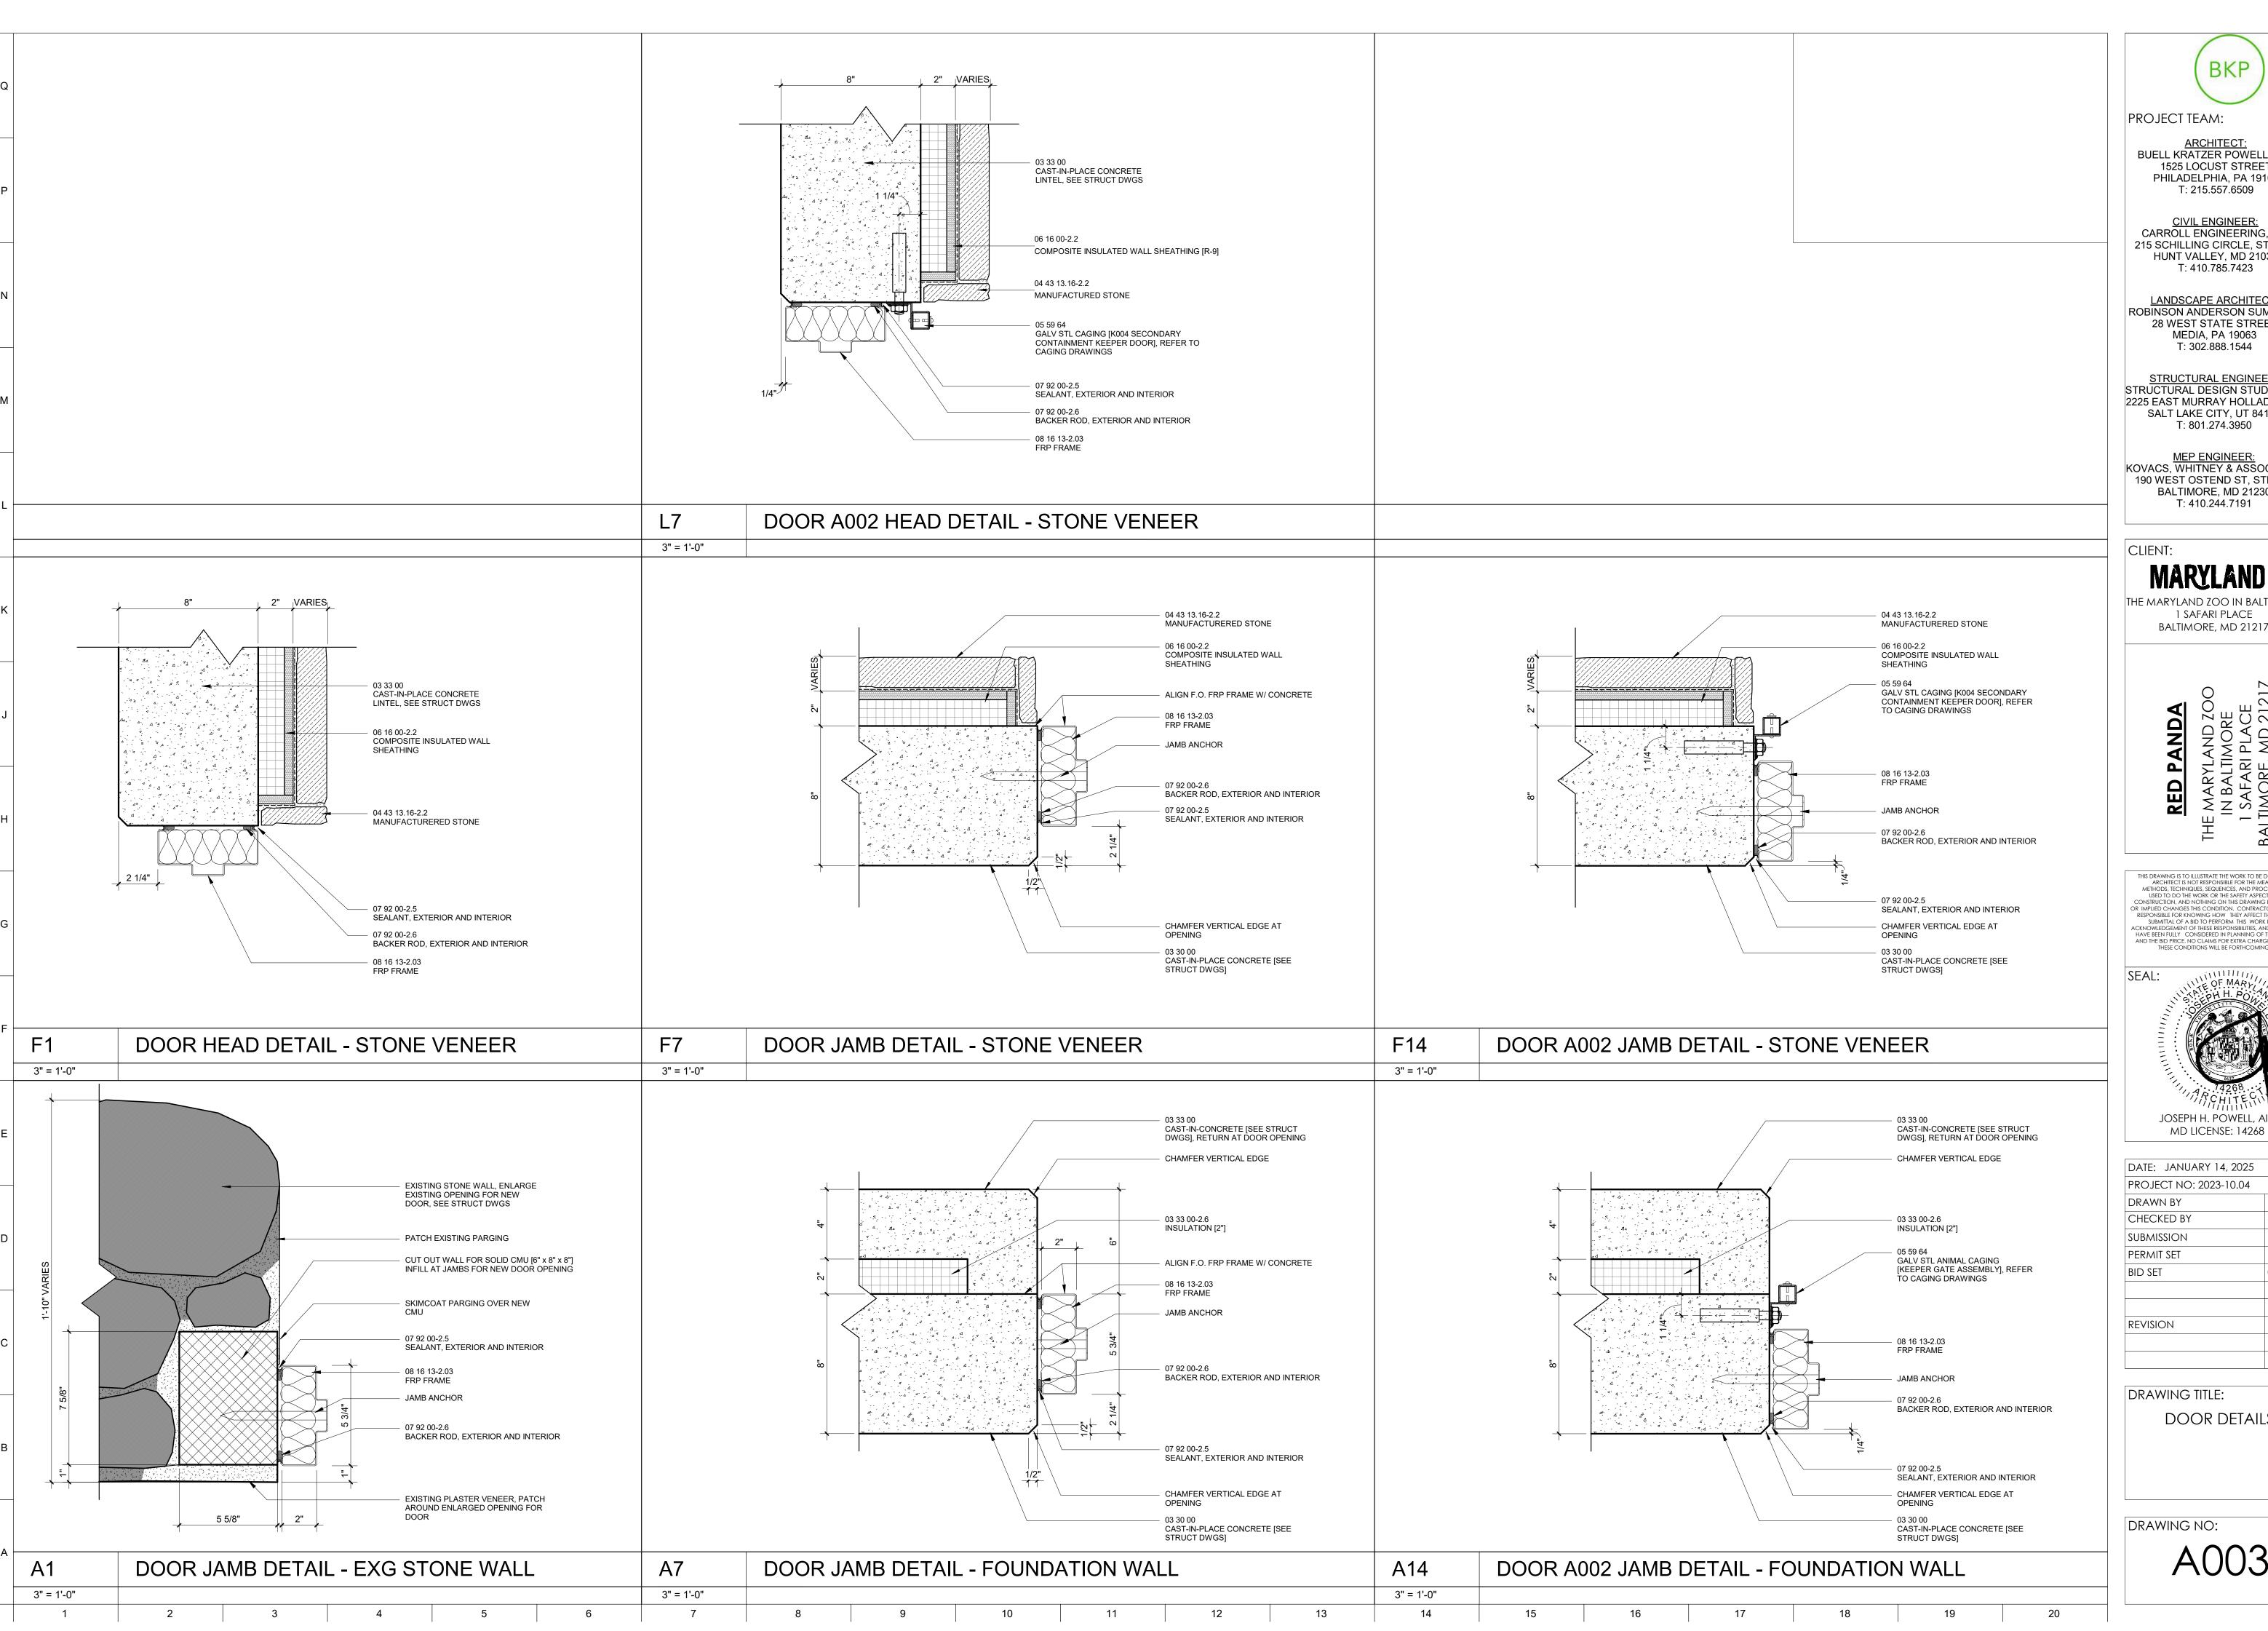



<u>ARCHITECT:</u> BUELL KRATZER POWELL, P.C. 1525 LOCUST STREET PHILADELPHIA, PA 19102

**CIVIL ENGINEER:** CARROLL ENGINEERING, INC 215 SCHILLING CIRCLE, STE 102 HUNT VALLEY, MD 21031

LANDSCAPE ARCHITECT:
ROBINSON ANDERSON SUMMERS 28 WEST STATE STREET MEDIA, PA 19063

STRUCTURAL ENGINEER: STRUCTURAL DESIGN STUDIO, INC 2225 EAST MURRAY HOLLADAY RD SALT LAKE CITY, UT 84117


MEP ENGINEER: KOVACS, WHITNEY & ASSOCIATES 190 WEST OSTEND ST, STE 300 BALTIMORE, MD 21230

THE MARYLAND ZOO IN BALTIMORE 1 SAFARI PLACE BALTIMORE, MD 21217

THIS DRAWING IS TO ILLUSTRATE THE WORK TO BE DONE. THE ARCHITECT IS NOT RESPONSIBLE FOR THE MEANS, METHODS, TECHNIQUES, SEQUENCES, AND PROCEDURES USED TO DO THE WORK OR THE SAFETY ASPECTS OF CONSTRUCTION, AND NOTHING ON THIS DRAWING EXPRESSED OR IMPLIED CHANGES THIS CONDITION, CONTRACTOR SHALL BE RESPONSIBLE FOR KNOWING HOW THEY AFFECT THE WORK. SUBMITTAL OF A BID TO PERFORM THIS WORK IS AN

7712 21321 1021 1 1200	
E: JANUARY 14, 2025	
DJECT NO: 2023-10.04	
WN BY	Author
ECKED BY	Checker
MISSION	DATE
MIT SET	11/22/2024
SET	01/14/2025
ISION	DATE

DOOR DETAILS

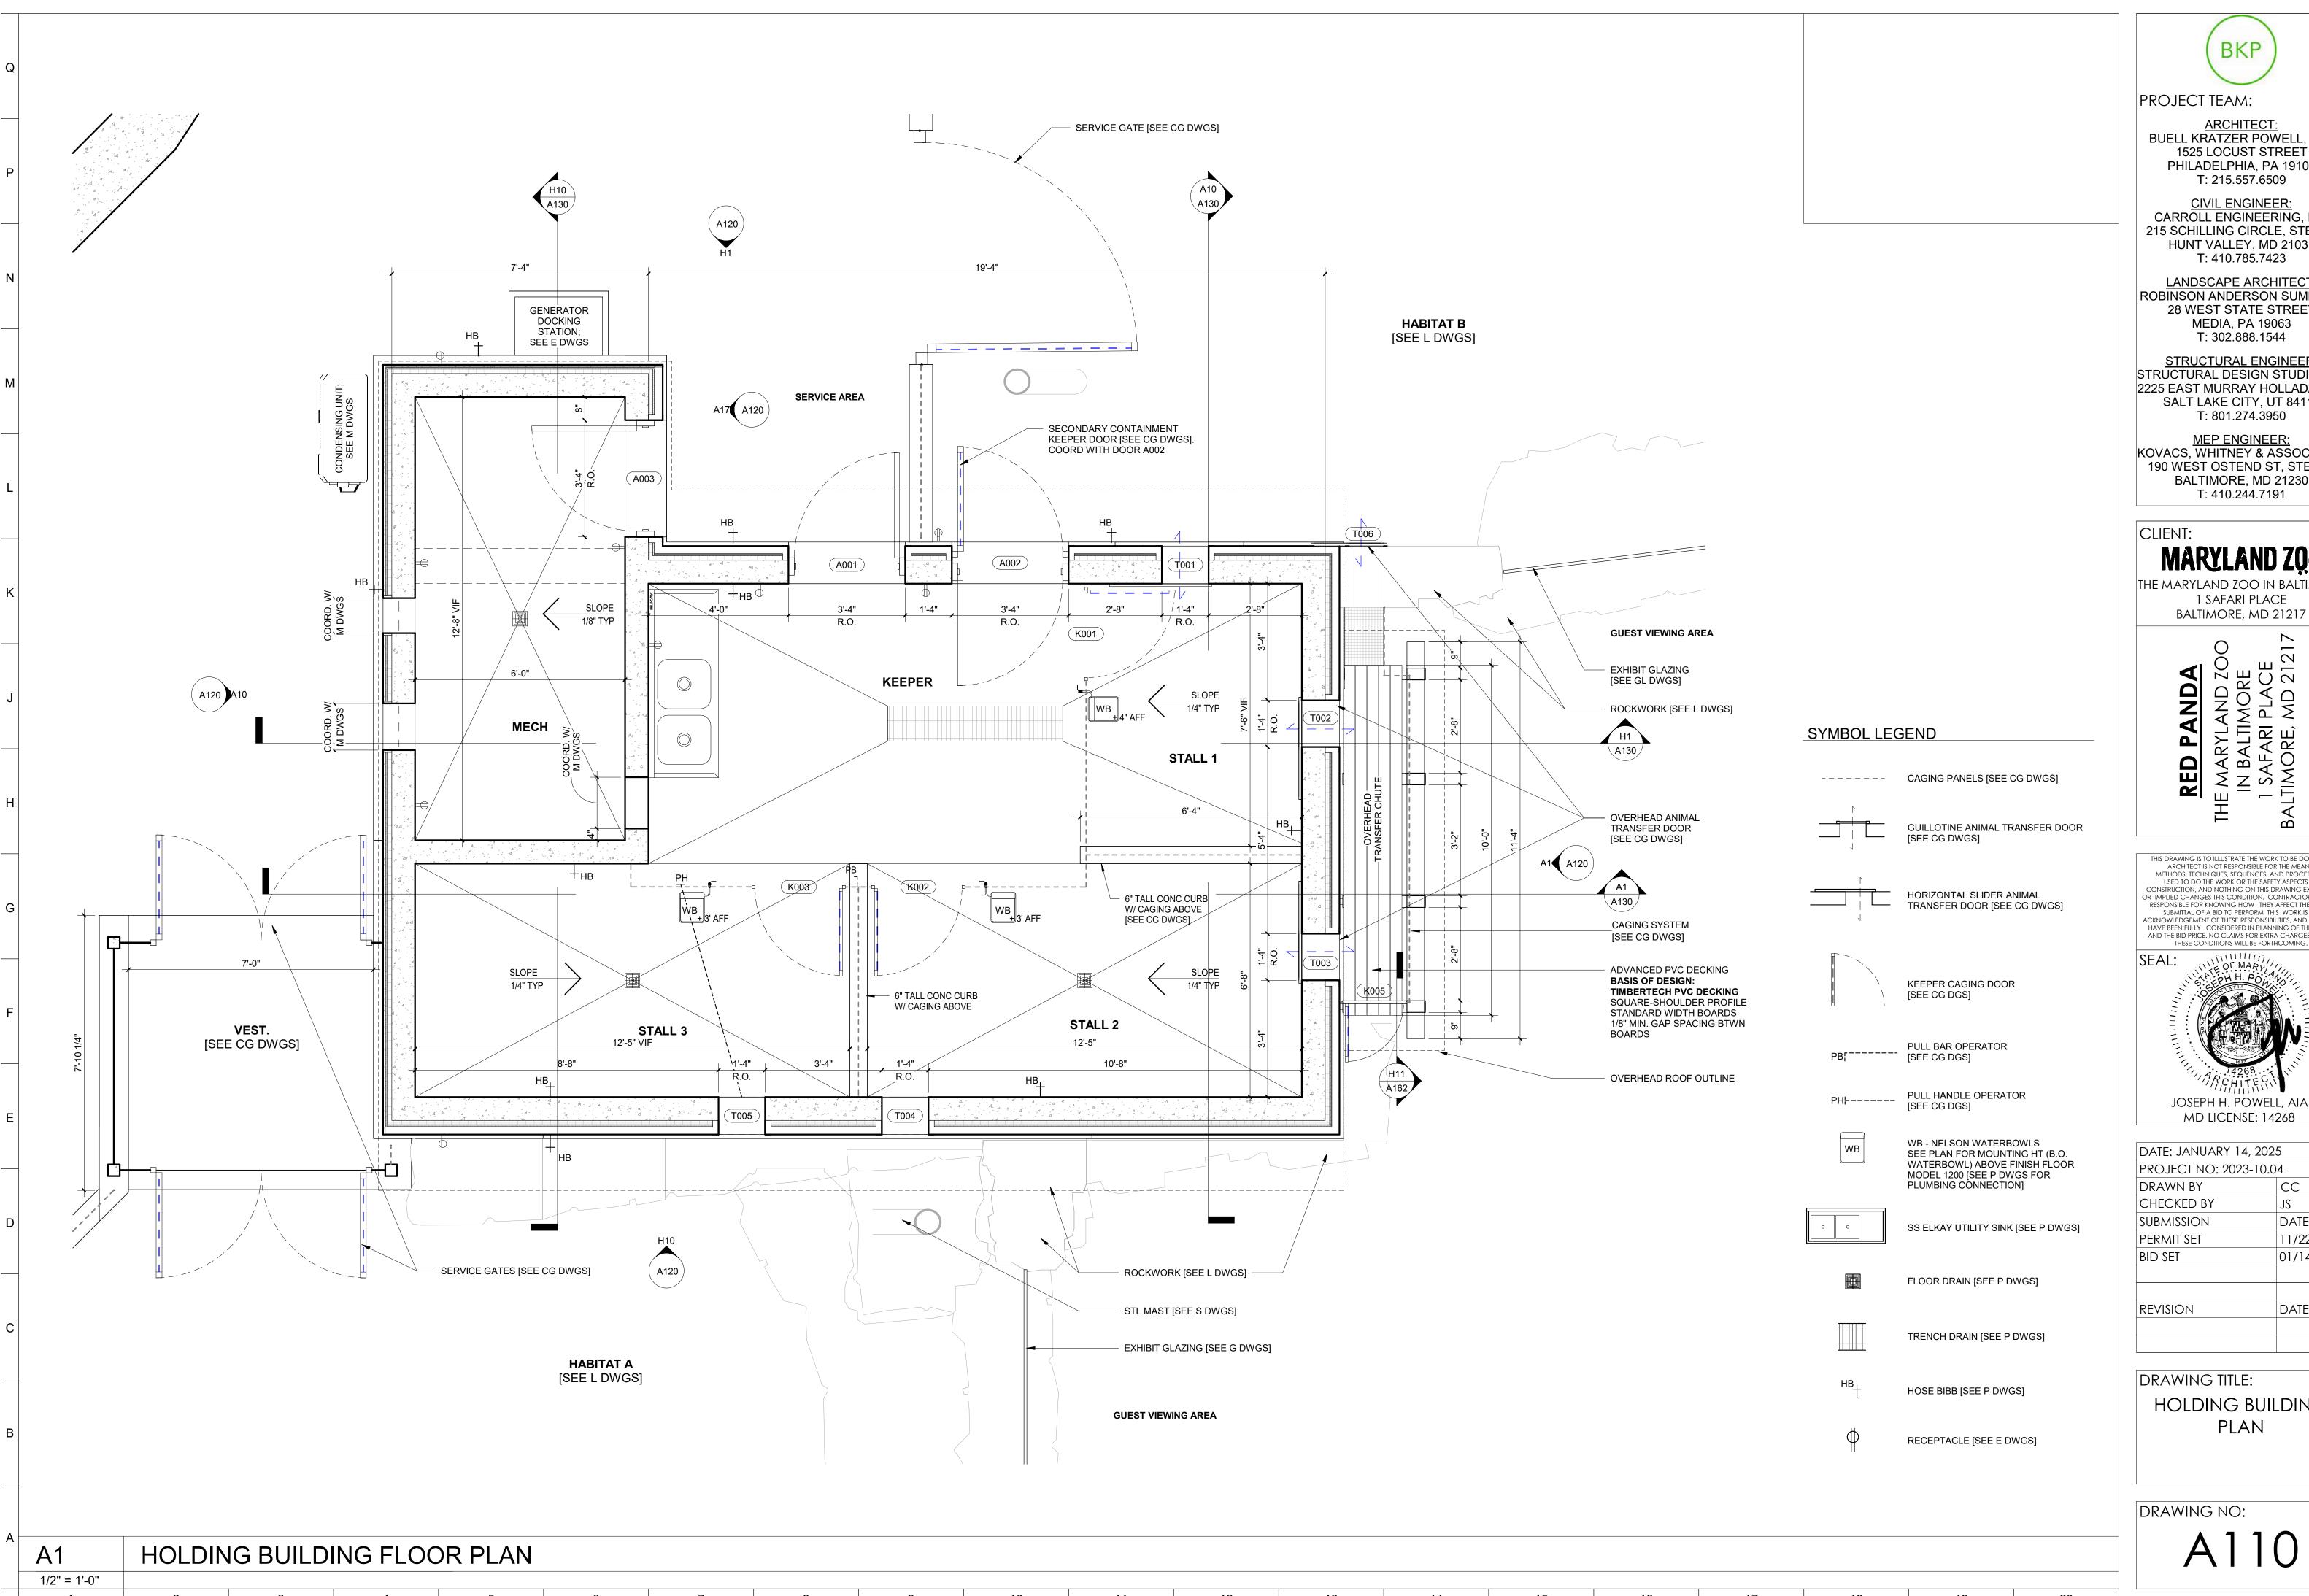



ARCHITECT:
BUELL KRATZER POWELL, P.C. 1525 LOCUST STREET PHILADELPHIA, PA 19102

**CIVIL ENGINEER:** CARROLL ENGINEERING, INC 215 SCHILLING CIRCLE, STE 102 HUNT VALLEY, MD 21031

LANDSCAPE ARCHITECT: ROBINSON ANDERSON SUMMERS 28 WEST STATE STREET MEDIA, PA 19063

STRUCTURAL ENGINEER: STRUCTURAL DESIGN STUDIO, INC 2225 EAST MURRAY HOLLADAY RD SALT LAKE CITY, UT 84117

KOVACS, WHITNEY & ASSOCIATES 190 WEST OSTEND ST, STE 300 BALTIMORE, MD 21230


THE MARYLAND ZOO IN BALTIMORE 1 SAFARI PLACE BALTIMORE, MD 21217

THIS DRAWING IS TO ILLUSTRATE THE WORK TO BE DONE. THE ARCHITECT IS NOT RESPONSIBLE FOR THE MEANS, USED TO DO THE WORK OR THE SAFETY ASPECTS OF CONSTRUCTION, AND NOTHING ON THIS DRAWING EXPRESSED OR IMPLIED CHANGES THIS CONDITION. CONTRACTOR SHALL BE RESPONSIBLE FOR KNOWING HOW THEY AFFECT THE WORK. SUBMITTAL OF A BID TO PERFORM THIS WORK IS AN ACKNOWLEDGEMENT OF THESE RESPONSIBILITIES, AND THAT THEY HAVE BEEN FULLY CONSIDERED IN PLANNING OF THE WORK, AND THE BID PRICE, NO CLAIMS FOR EXTRA CHARGES DUE TO

MD LICENSE: 14268 DATE: JANUARY 14, 2025 PROJECT NO: 2023-10.04 JS DATE 11/22/2024 01/14/2025

DATE

HOLDING BUILDING PLAN

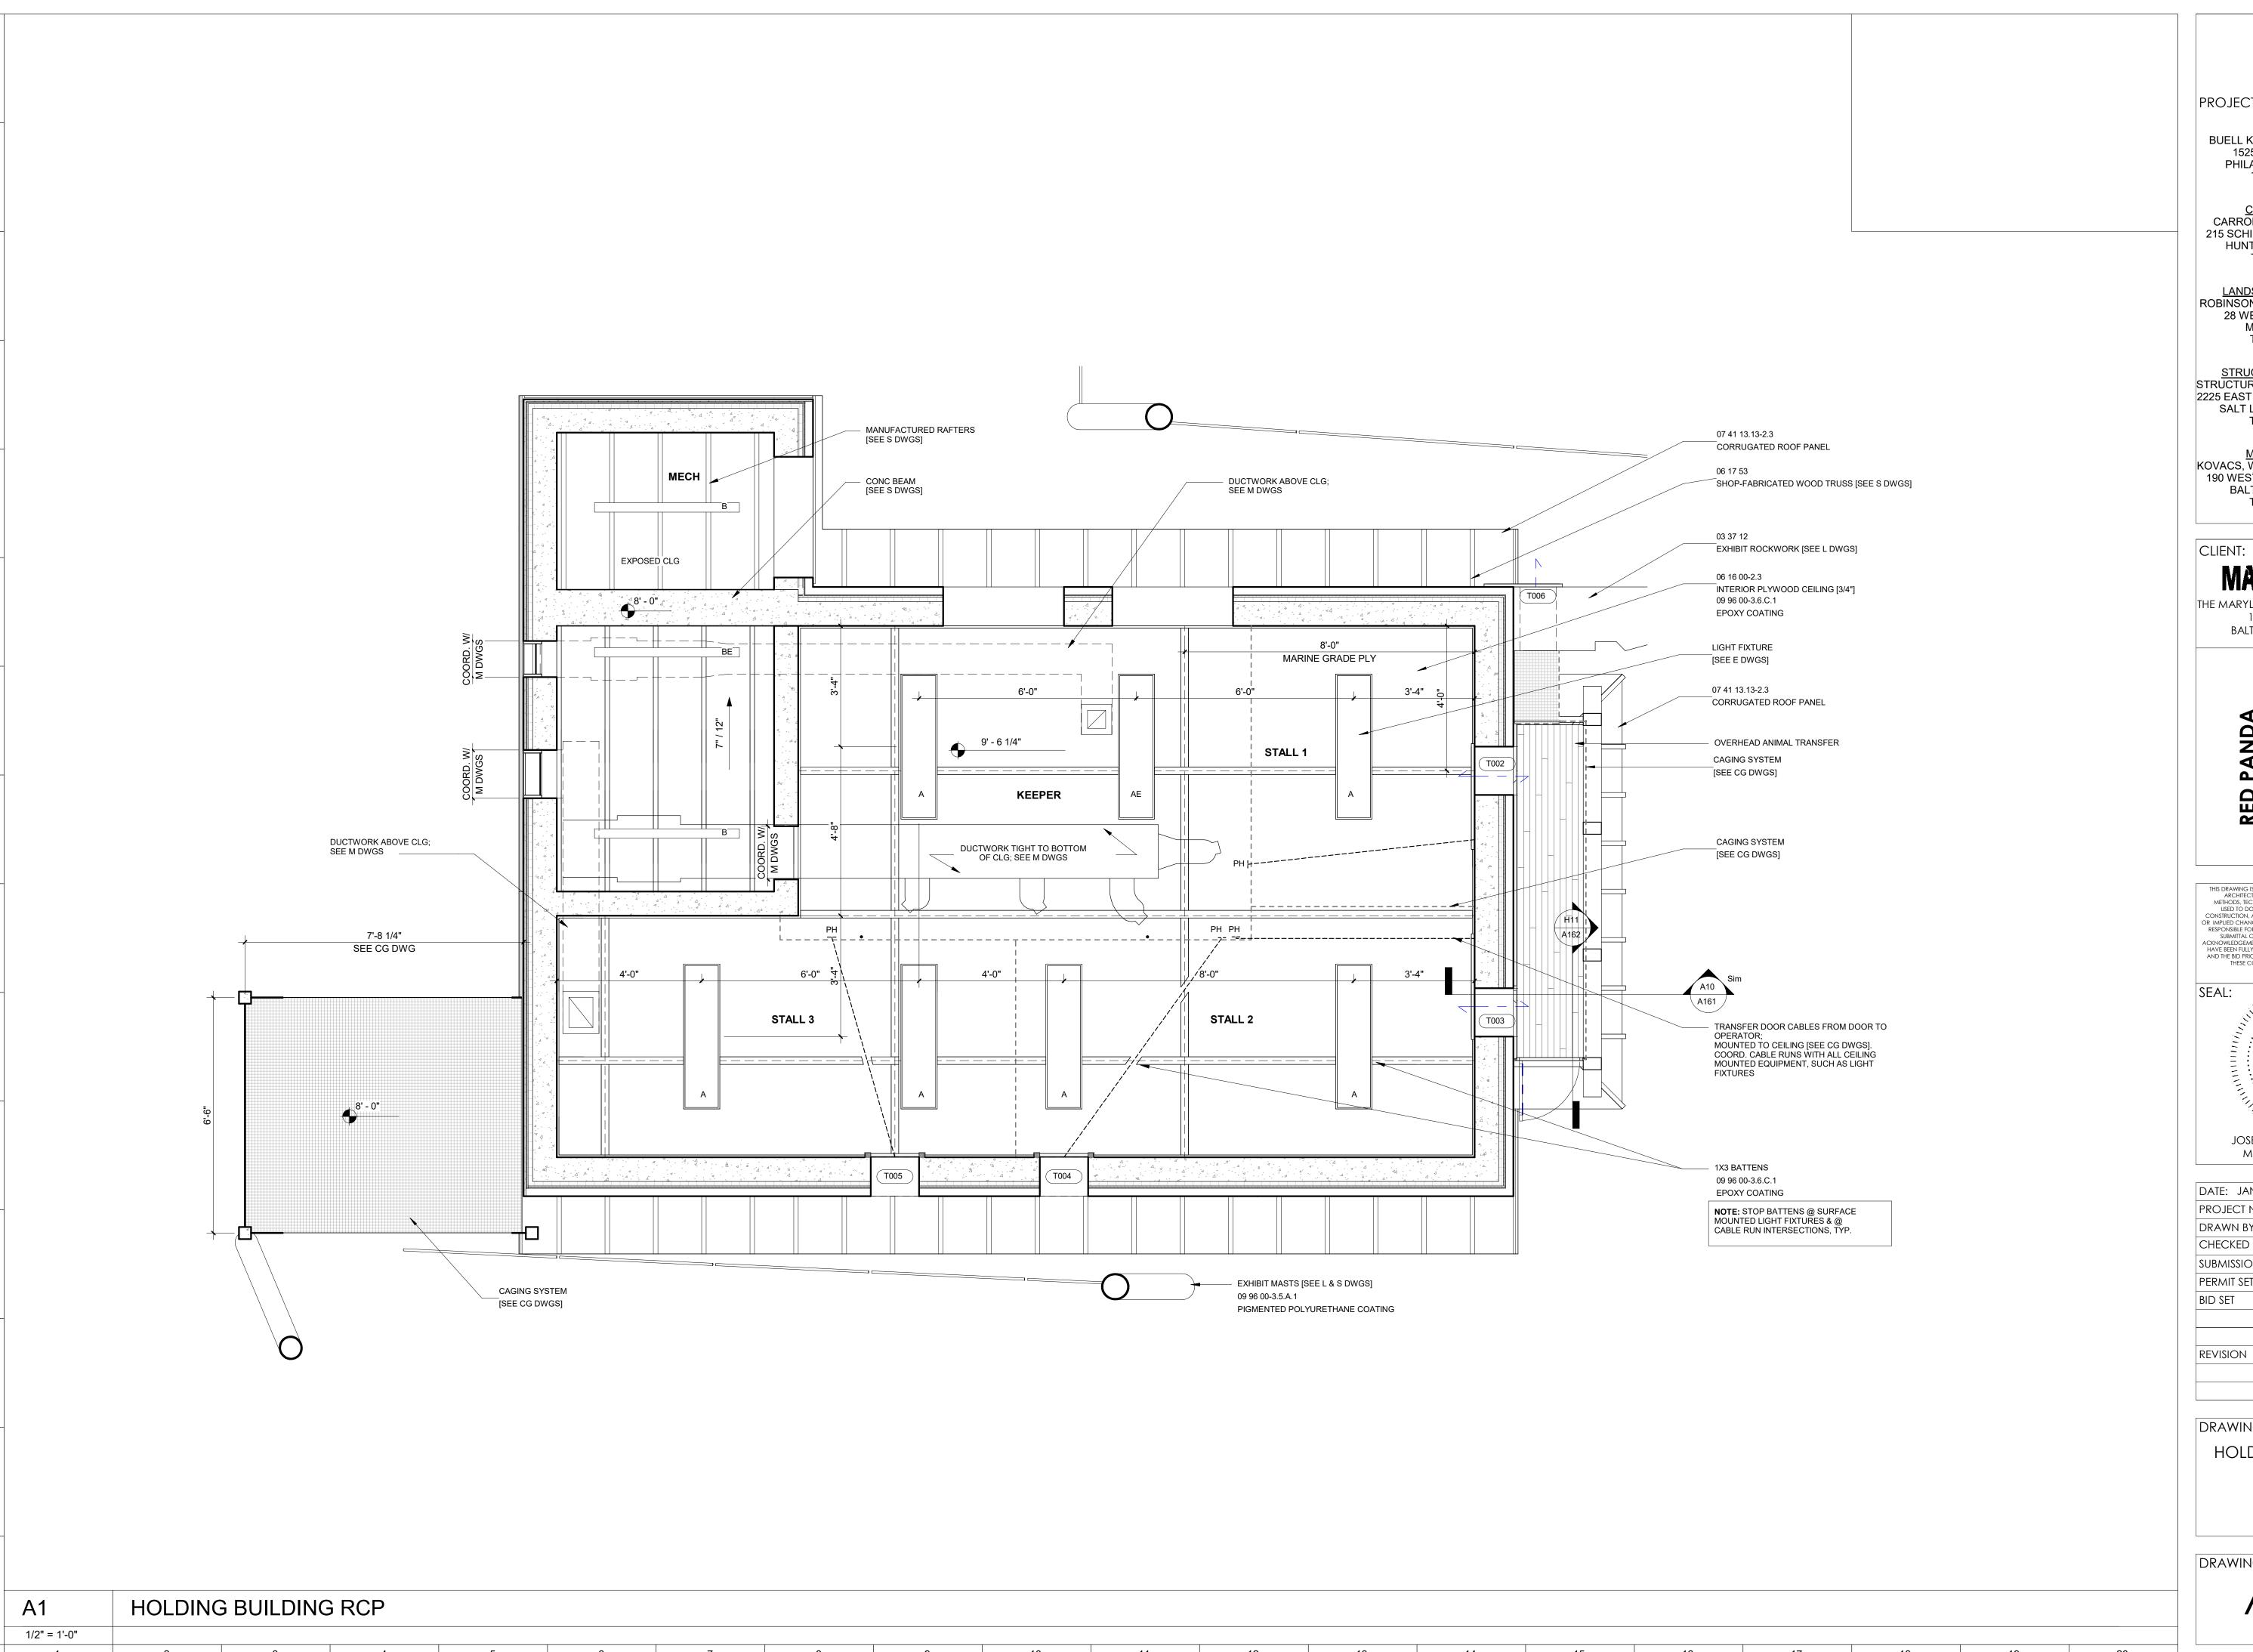



<u>ARCHITECT:</u> BUELL KRATZER POWELL, P.C. 1525 LOCUST STREET PHILADELPHIA, PA 19102 T: 215.557.6509

<u>CIVIL ENGINEER:</u> CARROLL ENGINEERING, INC 215 SCHILLING CIRCLE, STE 102 HUNT VALLEY, MD 21031 T: 410.785.7423


LANDSCAPE ARCHITECT:
ROBINSON ANDERSON SUMMERS 28 WEST STATE STREET MEDIA, PA 19063 T: 302.888.1544

<u>STRUCTURAL ENGINEER:</u> STRUCTURAL DESIGN STUDIO, INC 2225 EAST MURRAY HOLLADAY RD SALT LAKE CITY, UT 84117 T: 801.274.3950

MEP ENGINEER: KOVACS, WHITNEY & ASSOCIATES 190 WEST OSTEND ST, STE 300 BALTIMORE, MD 21230 T: 410.244.7191

THE MARYLAND ZOO IN BALTIMORE 1 SAFARI PLACE BALTIMORE, MD 21217


THIS DRAWING IS TO ILLUSTRATE THE WORK TO BE DONE. THE ARCHITECT IS NOT RESPONSIBLE FOR THE MEANS, METHODS, TECHNIQUES, SEQUENCES, AND PROCEDURES USED TO DO THE WORK OR THE SAFETY ASPECTS OF CONSTRUCTION, AND NOTHING ON THIS DRAWING EXPRESSED OR IMPLIED CHANGES THIS CONDITION, CONTRACTOR SHALL BE RESPONSIBLE FOR KNOWING HOW THEY AFFECT THE WORK. SUBMITTAL OF A BID TO PERFORM THIS WORK IS AN ACKNOWLEDGEMENT OF THESE RESPONSIBILITIES, AND THAT THEY HAVE BEEN FULLY CONSIDERED IN PLANNING OF THE WORK, AND THE BID PRICE. NO CLAIMS FOR EXTRA CHARGES DUE TO THESE CONDITIONS WILL BE FORTHCOMING.

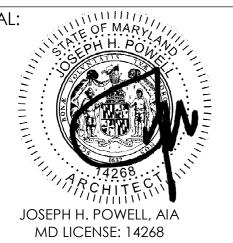

DATE: JANUARY 14, 2025	5
PROJECT NO: 2023-10.04	
DRAWN BY	CC
CHECKED BY	JS
SUBMISSION	DATE
PERMIT SET	11/22/2024
BID SET	01/14/2025
REVISION	DATE

DRAWING TITLE:

HOLDING BUILDING

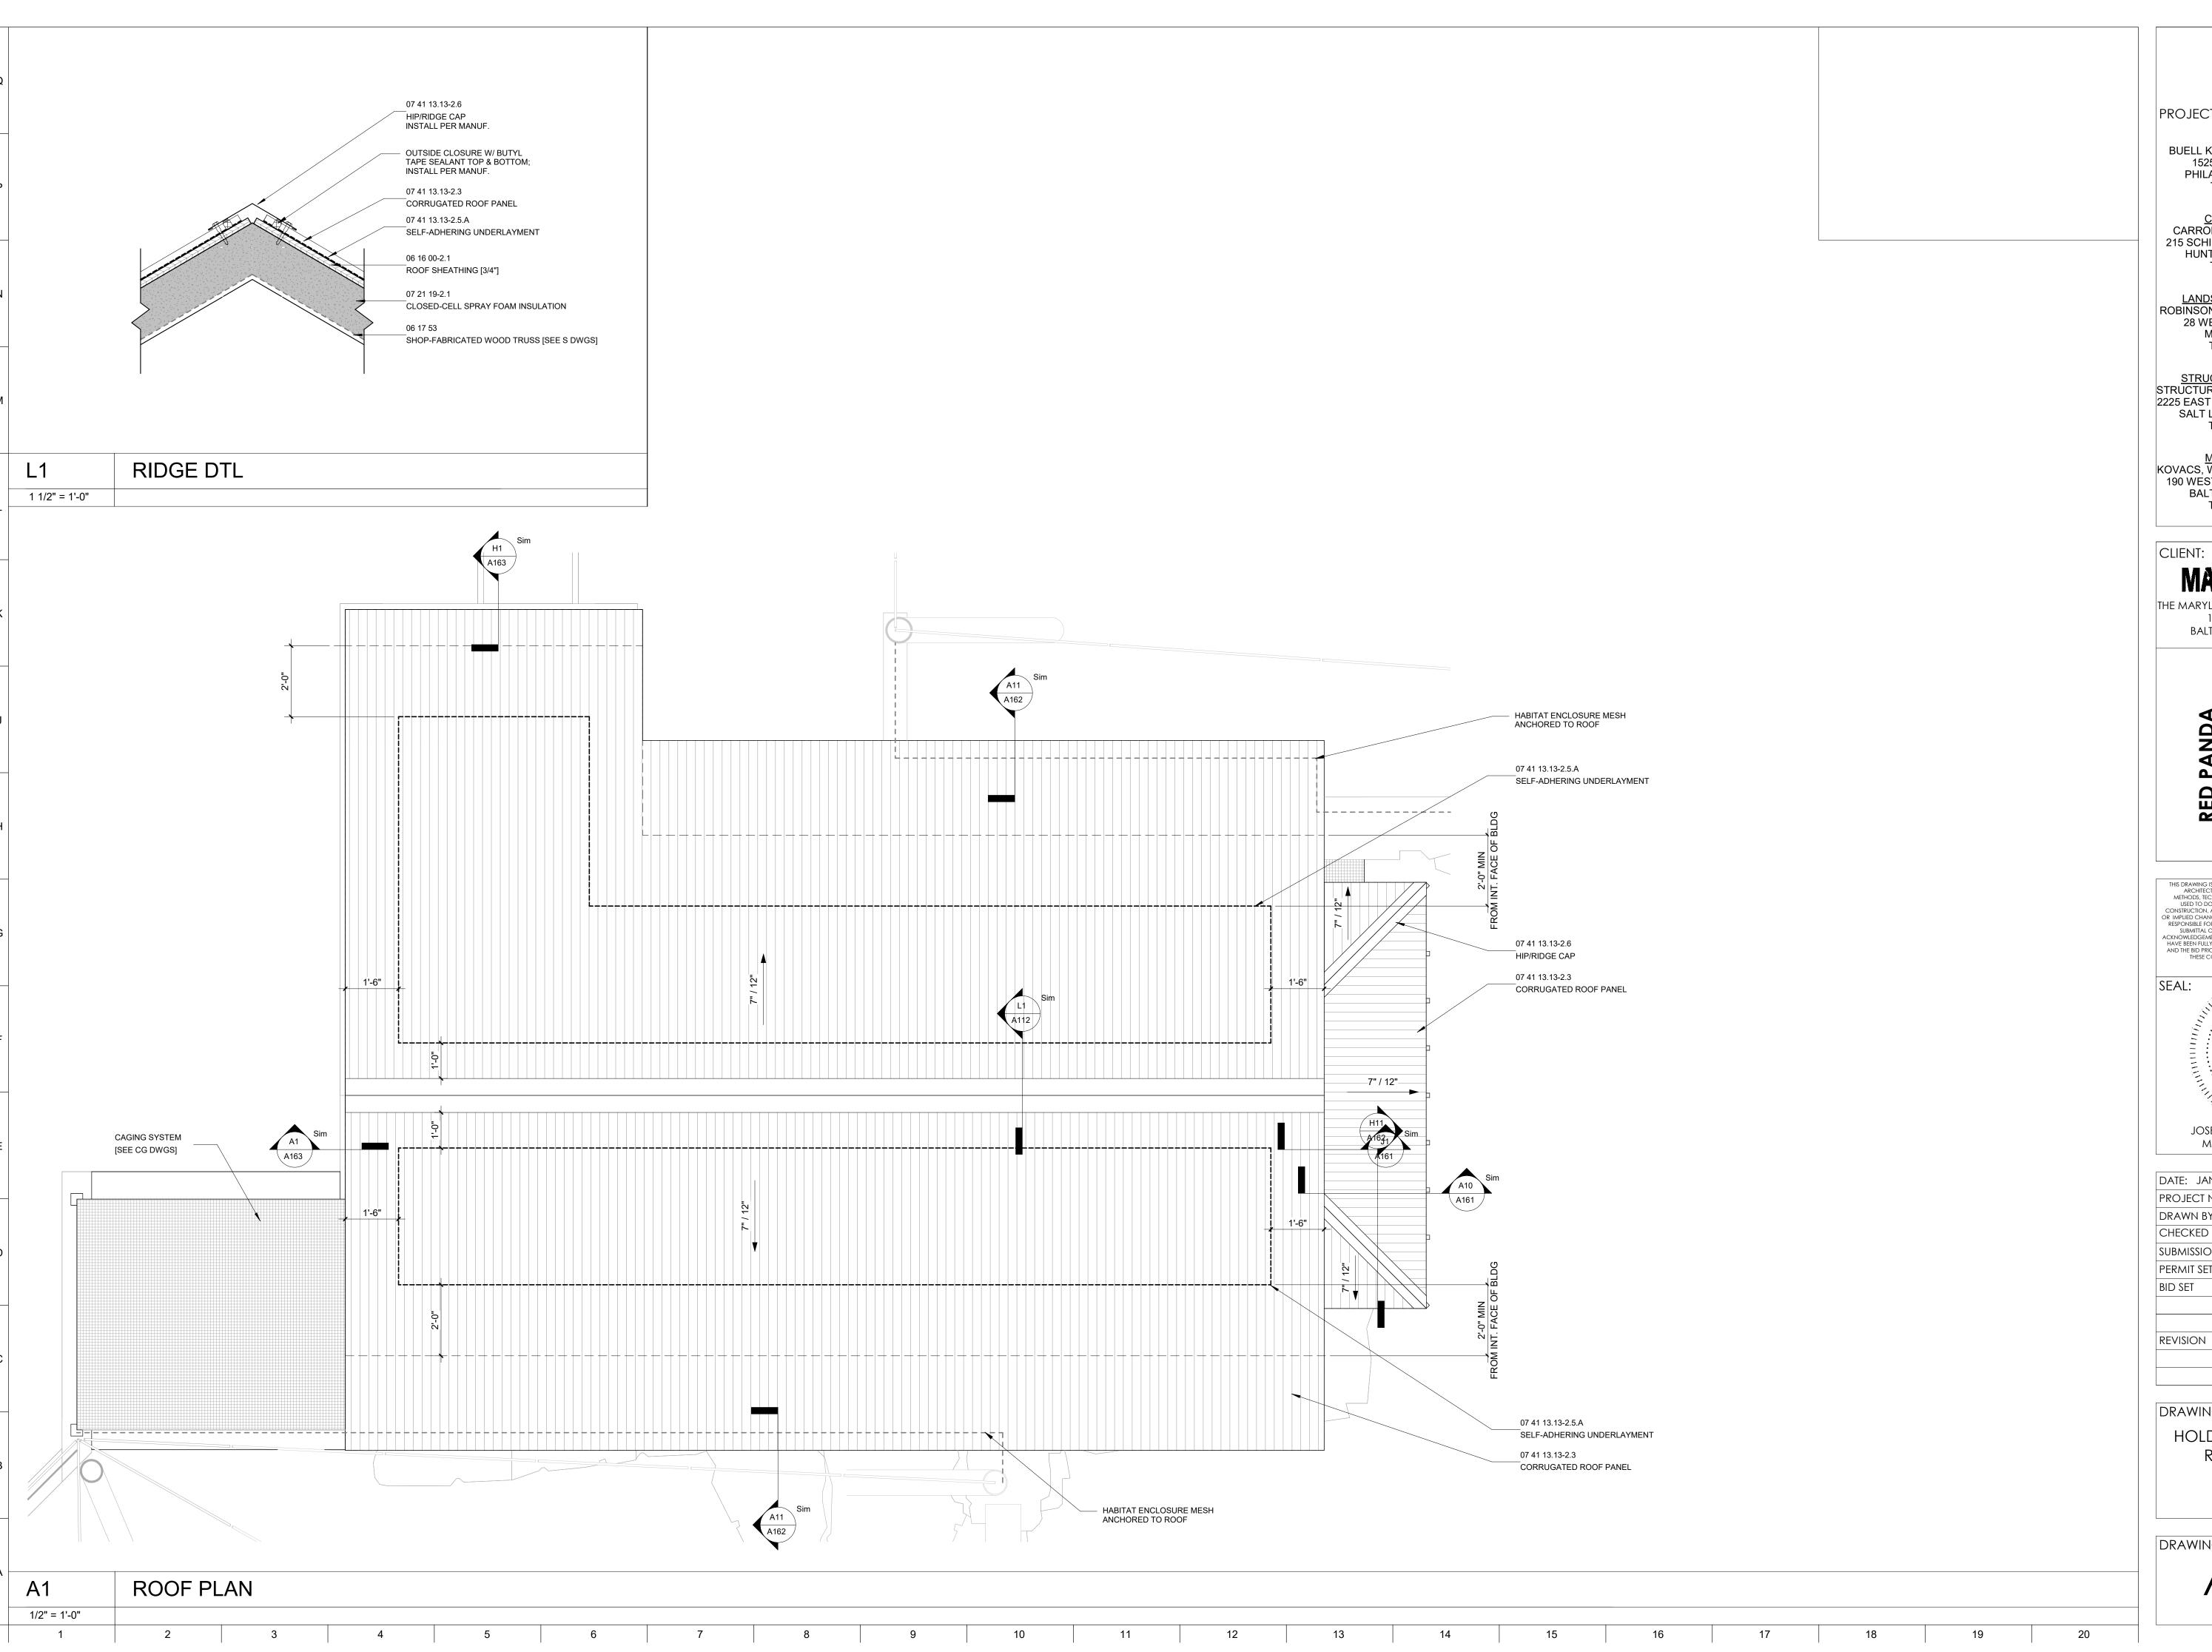



ARCHITECT:
BUELL KRATZER POWELL, P.C.
1525 LOCUST STREET
PHILADELPHIA, PA 19102 T: 215.557.6509

<u>CIVIL ENGINEER:</u> CARROLL ENGINEERING, INC 215 SCHILLING CIRCLE, STE 102 HUNT VALLEY, MD 21031 T: 410.785.7423

LANDSCAPE ARCHITECT:
ROBINSON ANDERSON SUMMERS 28 WEST STATE STREET MEDIA, PA 19063 T: 302.888.1544

<u>STRUCTURAL ENGINEER:</u> STRUCTURAL DESIGN STUDIO, INC 2225 EAST MURRAY HOLLADAY RD SALT LAKE CITY, UT 84117 T: 801.274.3950

MEP ENGINEER: KOVACS, WHITNEY & ASSOCIATES 190 WEST OSTEND ST, STE 300 BALTIMORE, MD 21230 T: 410.244.7191

THE MARYLAND ZOO IN BALTIMORE 1 SAFARI PLACE BALTIMORE, MD 21217


THIS DRAWING IS TO ILLUSTRATE THE WORK TO BE DONE, THE ARCHITECT IS NOT RESPONSIBLE FOR THE MEANS, METHODS, TECHNIQUES, SEQUENCES, AND PROCEDURES USED TO DO THE WORK OR THE SAFETY ASPECTS OF CONSTRUCTION, AND NOTHING ON THIS DRAWING EXPRESSED OR IMPLIED CHANGES THIS CONDITION. CONTRACTOR SHALL BE RESPONSIBLE FOR KNOWING HOW THEY AFFECT THE WORK. SUBMITTAL OF A BID TO PERFORM THIS WORK IS AN ACKNOWLEDGEMENT OF THESE RESPONSIBILITIES, AND THAT THEY HAVE BEEN FULLY. CONSIDERED IN PLANNING OF THE WORK, AND THE BID PRICE. NO CLAIMS FOR EXTRA CHARGES DUE TO THESE CONDITIONS WILL BE FORTHCOMING.

JOSEPH H. POWELL, AIA MD LICENSE: 14268

DATE: JANUARY 14, 2025	
PROJECT NO: 2023-10.04	
DRAWN BY	CC
CHECKED BY	JS
SUBMISSION	DATE
PERMIT SET	11/22/2024
BID SET	01/14/2025
REVISION	DATE

DRAWING TITLE:

HOLDING BUILDING **ROOF PLAN** 

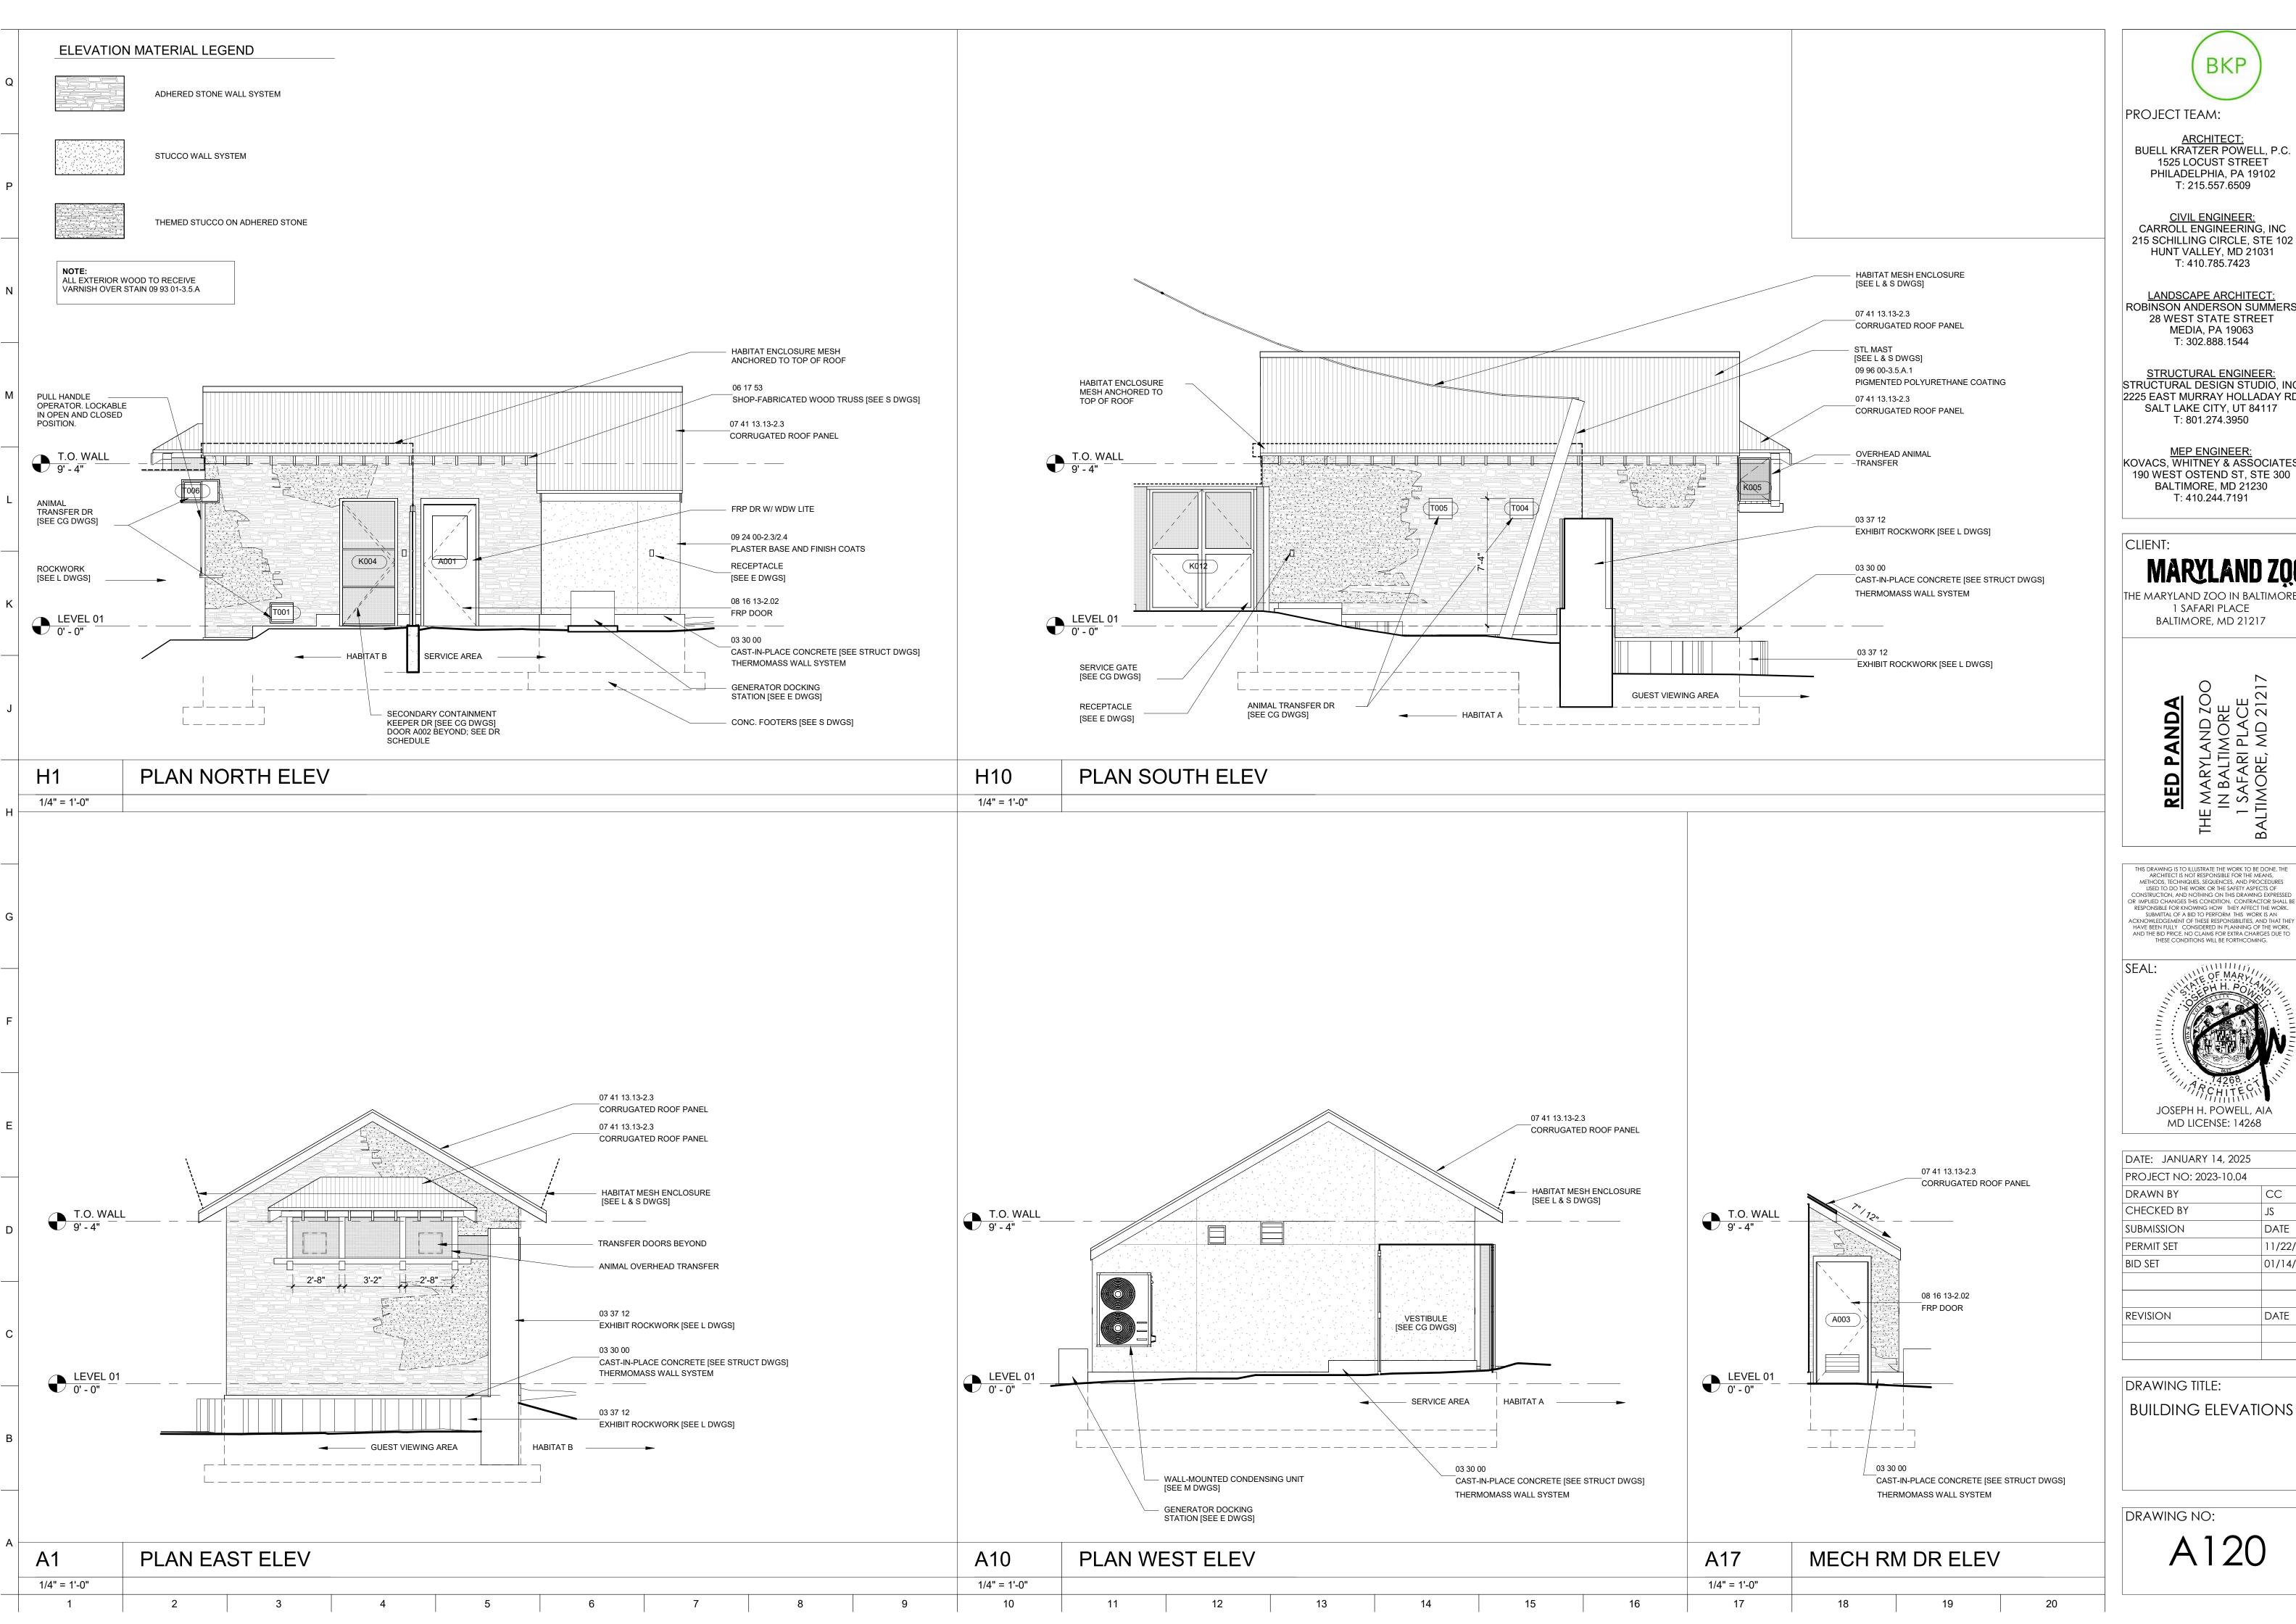



1525 LOCUST STREET PHILADELPHIA, PA 19102

<u>CIVIL ENGINEER:</u> CARROLL ENGINEERING, INC 215 SCHILLING CIRCLE, STE 102 HUNT VALLEY, MD 21031


LANDSCAPE ARCHITECT: ROBINSON ANDERSON SUMMERS 28 WEST STATE STREET MEDIA, PA 19063

<u>STRUCTURAL ENGINEER:</u> STRUCTURAL DESIGN STUDIO, INC 2225 EAST MURRAY HOLLADAY RD

MEP ENGINEER: KOVACS, WHITNEY & ASSOCIATES 190 WEST OSTEND ST, STE 300 BALTIMORE, MD 21230


THE MARYLAND ZOO IN BALTIMORE 1 SAFARI PLACE BALTIMORE, MD 21217

THIS DRAWING IS TO ILLUSTRATE THE WORK TO BE DONE, THE ARCHITECT IS NOT RESPONSIBLE FOR THE MEANS, METHODS, TECHNIQUES, SEQUENCES, AND PROCEDURES USED TO DO THE WORK OR THE SAFETY ASPECTS OF CONSTRUCTION, AND NOTHING ON THIS DRAWING EXPRESSED OR IMPLIED CHANGES THIS CONDITION. CONTRACTOR SHALL BE RESPONSIBLE FOR KNOWING HOW THEY AFFECT THE WORK. SUBMITTAL OF A BID TO PERFORM THIS WORK IS AN ACKNOWLEDGEMENT OF THESE RESPONSIBILITIES, AND THAT THEY HAVE BEEN FULLY CONSIDERED IN PLANNING OF THE WORK, AND THE BID PRICE. NO CLAIMS FOR EXTRA CHARGES DUE TO THESE CONDITIONS WILL BE FORTHCOMING.

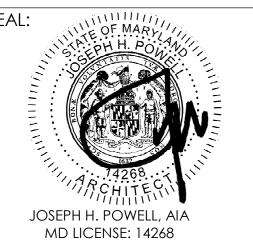

DATE: JANUARY 14, 2025	
PROJECT NO: 2023-10.04	
DRAWN BY	CC
CHECKED BY	JS
SUBMISSION	DATE
PERMIT SET	11/22/2024
BID SET	01/14/2025
REVISION	DATE

BUILDING ELEVATIONS

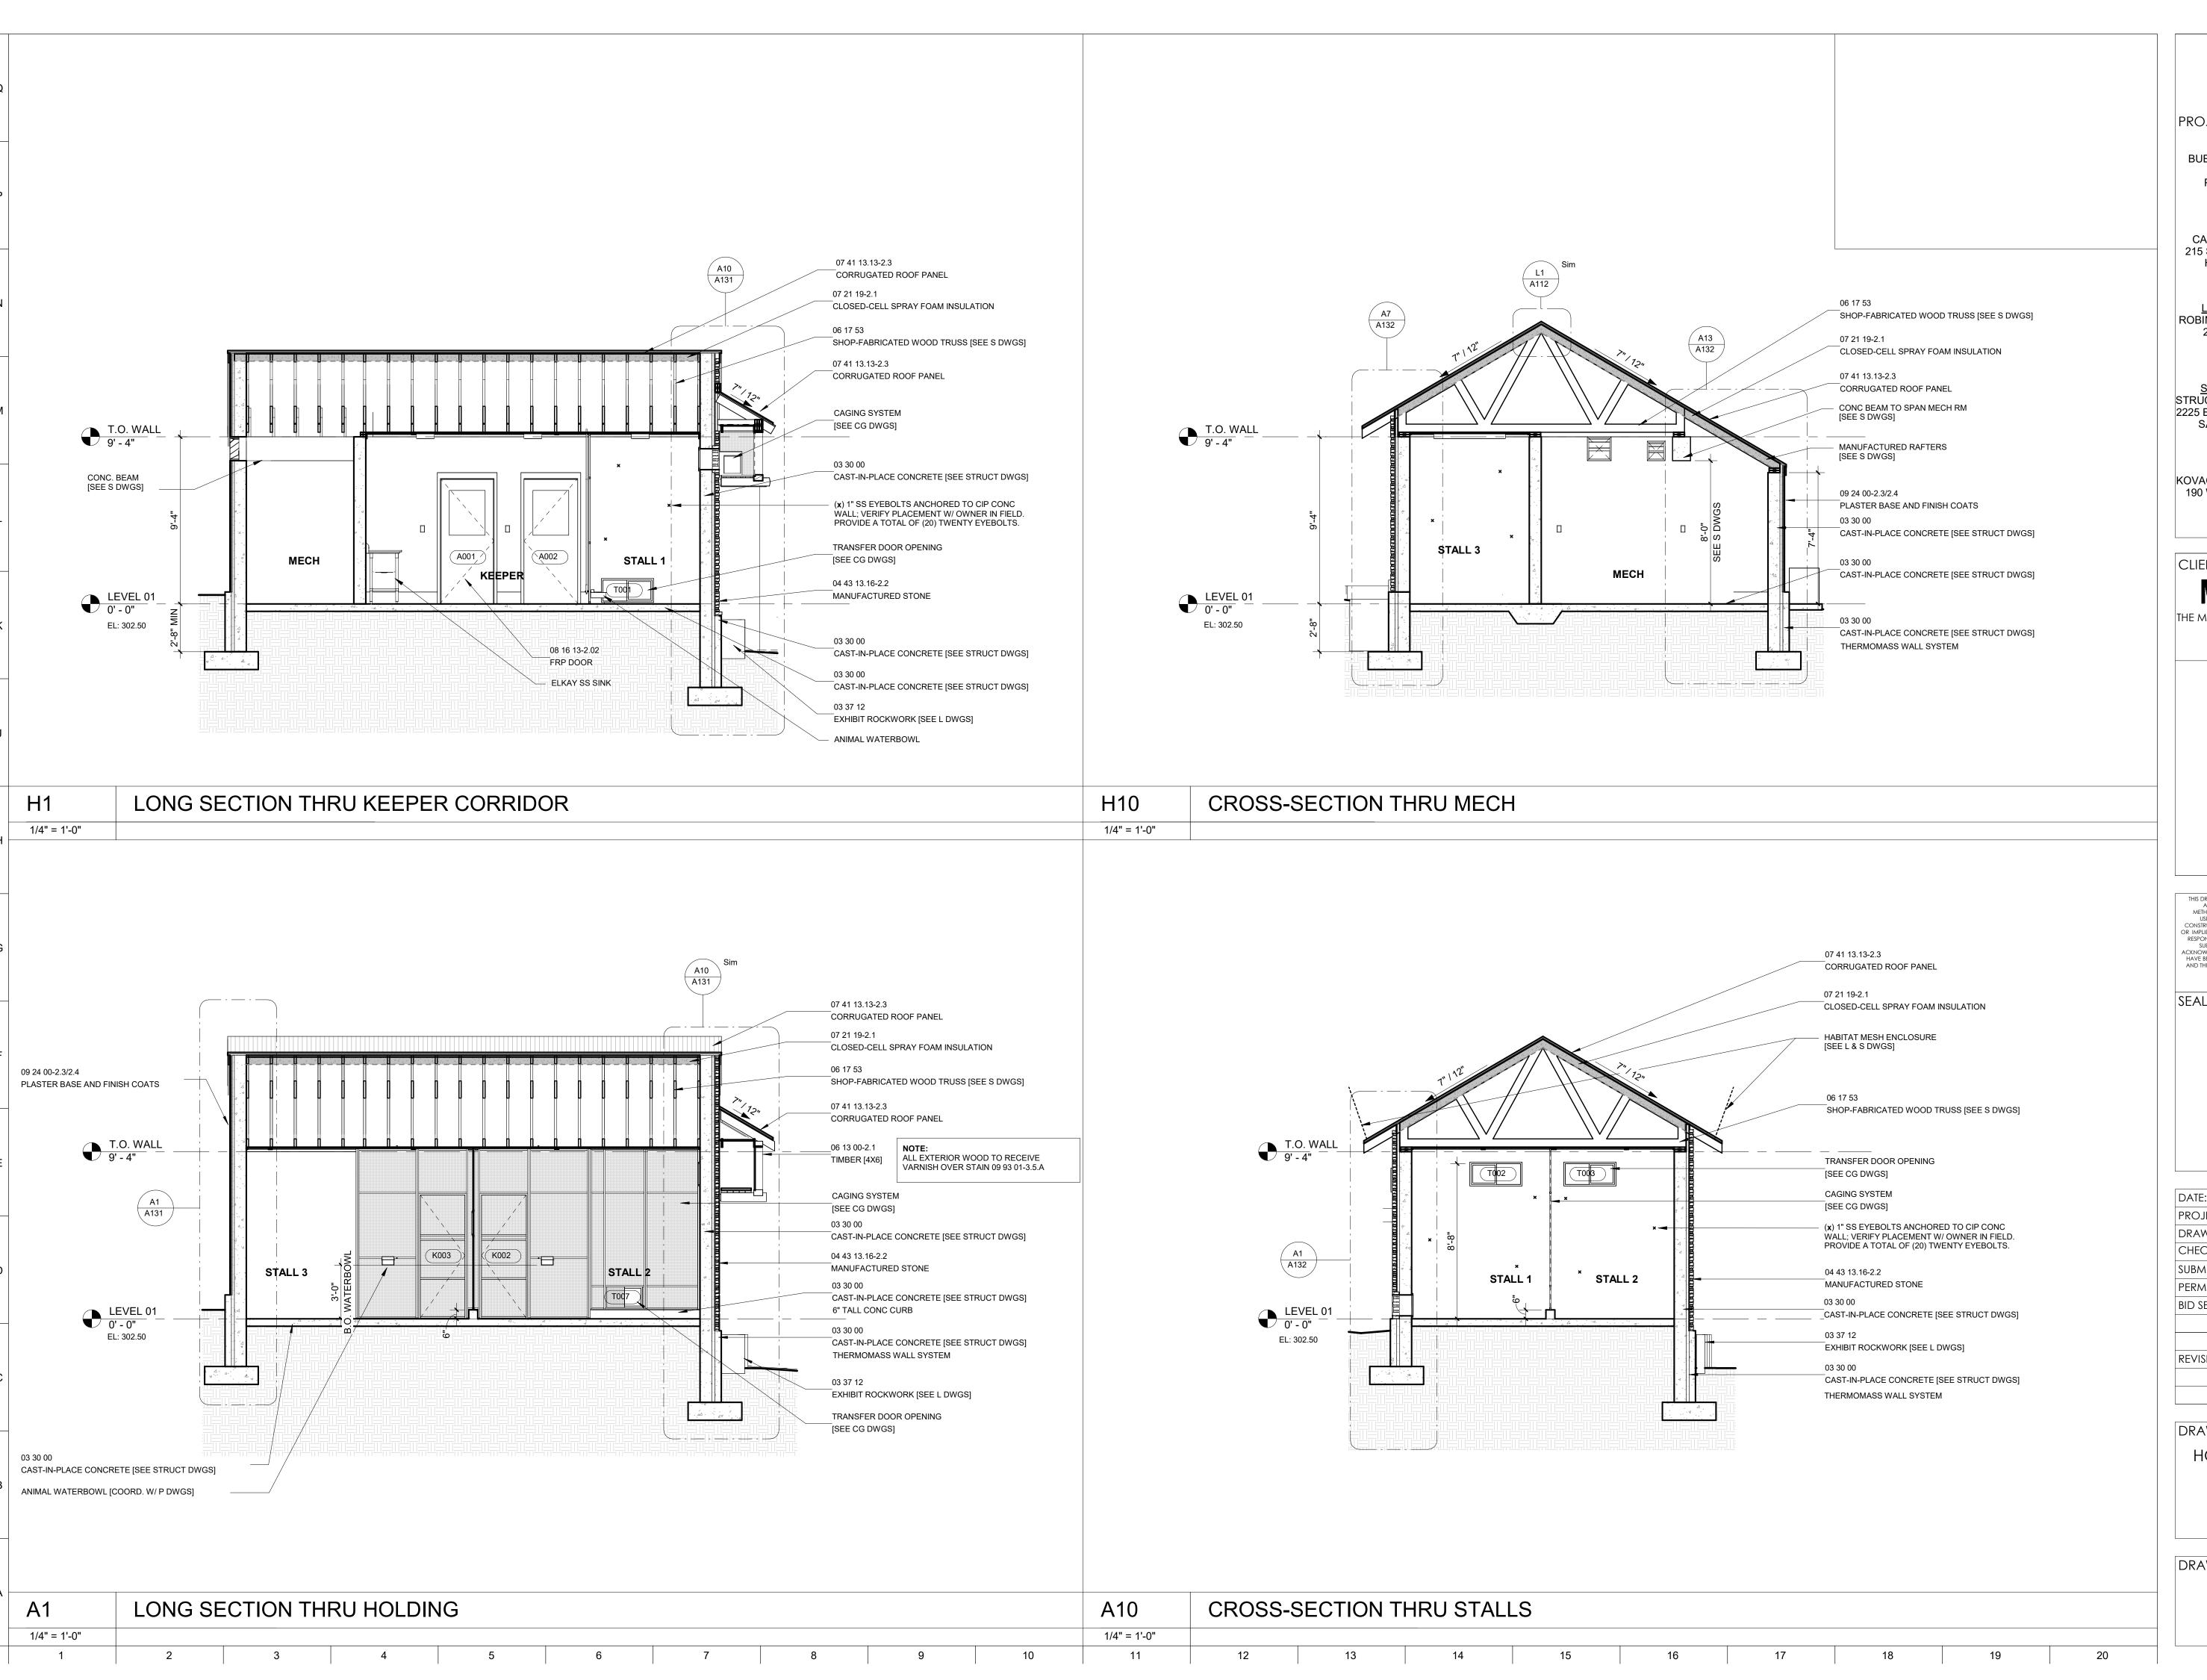



ARCHITECT:
BUELL KRATZER POWELL, P.C.
1525 LOCUST STREET
PHILADELPHIA, PA 19102
T: 215.557.6509

CIVIL ENGINEER:
CARROLL ENGINEERING, INC
215 SCHILLING CIRCLE, STE 102
HUNT VALLEY, MD 21031 T: 410.785.7423


LANDSCAPE ARCHITECT: ROBINSON ANDERSON SUMMERS 28 WEST STATE STREET MEDIA, PA 19063 T: 302.888.1544

<u>STRUCTURAL ENGINEER:</u> STRUCTURAL DESIGN STUDIO, INC 2225 EAST MURRAY HOLLADAY RD SALT LAKE CITY, UT 84117 T: 801.274.3950

MEP ENGINEER: KOVACS, WHITNEY & ASSOCIATES 190 WEST OSTEND ST, STE 300 BALTIMORE, MD 21230 T: 410.244.7191


THE MARYLAND ZOO IN BALTIMORE
1 SAFARI PLACE
BALTIMORE, MD 21217

THIS DRAWING IS TO ILLUSTRATE THE WORK TO BE DONE. THE ARCHITECT IS NOT RESPONSIBLE FOR THE MEANS, METHODS, TECHNIQUES, SEQUENCES, AND PROCEDURES USED TO DO THE WORK OR THE SAFETY ASPECTS OF CONSTRUCTION, AND NOTHING ON THIS DRAWING EXPRESSED OR IMPLIED CHANGES THIS CONDITION. CONTRACTOR SHALL BE RESPONSIBLE FOR KNOWING HOW THEY AFFECT THE WORK. SUBMITTAL OF A BID TO PERFORM THIS WORK IS AN ACKNOWLEDGEMENT OF THESE RESPONSIBILITIES, AND THAT THEY HAVE BEEN FULLY CONSIDERED IN PLANNING OF THE WORK, AND THE BID PRICE. NO CLAIMS FOR EXTRA CHARGES DUE TO THESE CONDITIONS WILL BE FORTHCOMING.

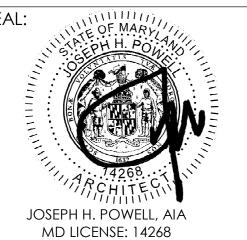

DATE: JANUARY 14, 2025	
PROJECT NO: 2023-10.04	
DRAWN BY	CC
CHECKED BY	JS
SUBMISSION	DATE
PERMIT SET	11/22/2024
BID SET	01/14/2025
REVISION	DATE

DRAWING TITLE: HOLDING BUILDING SECTIONS

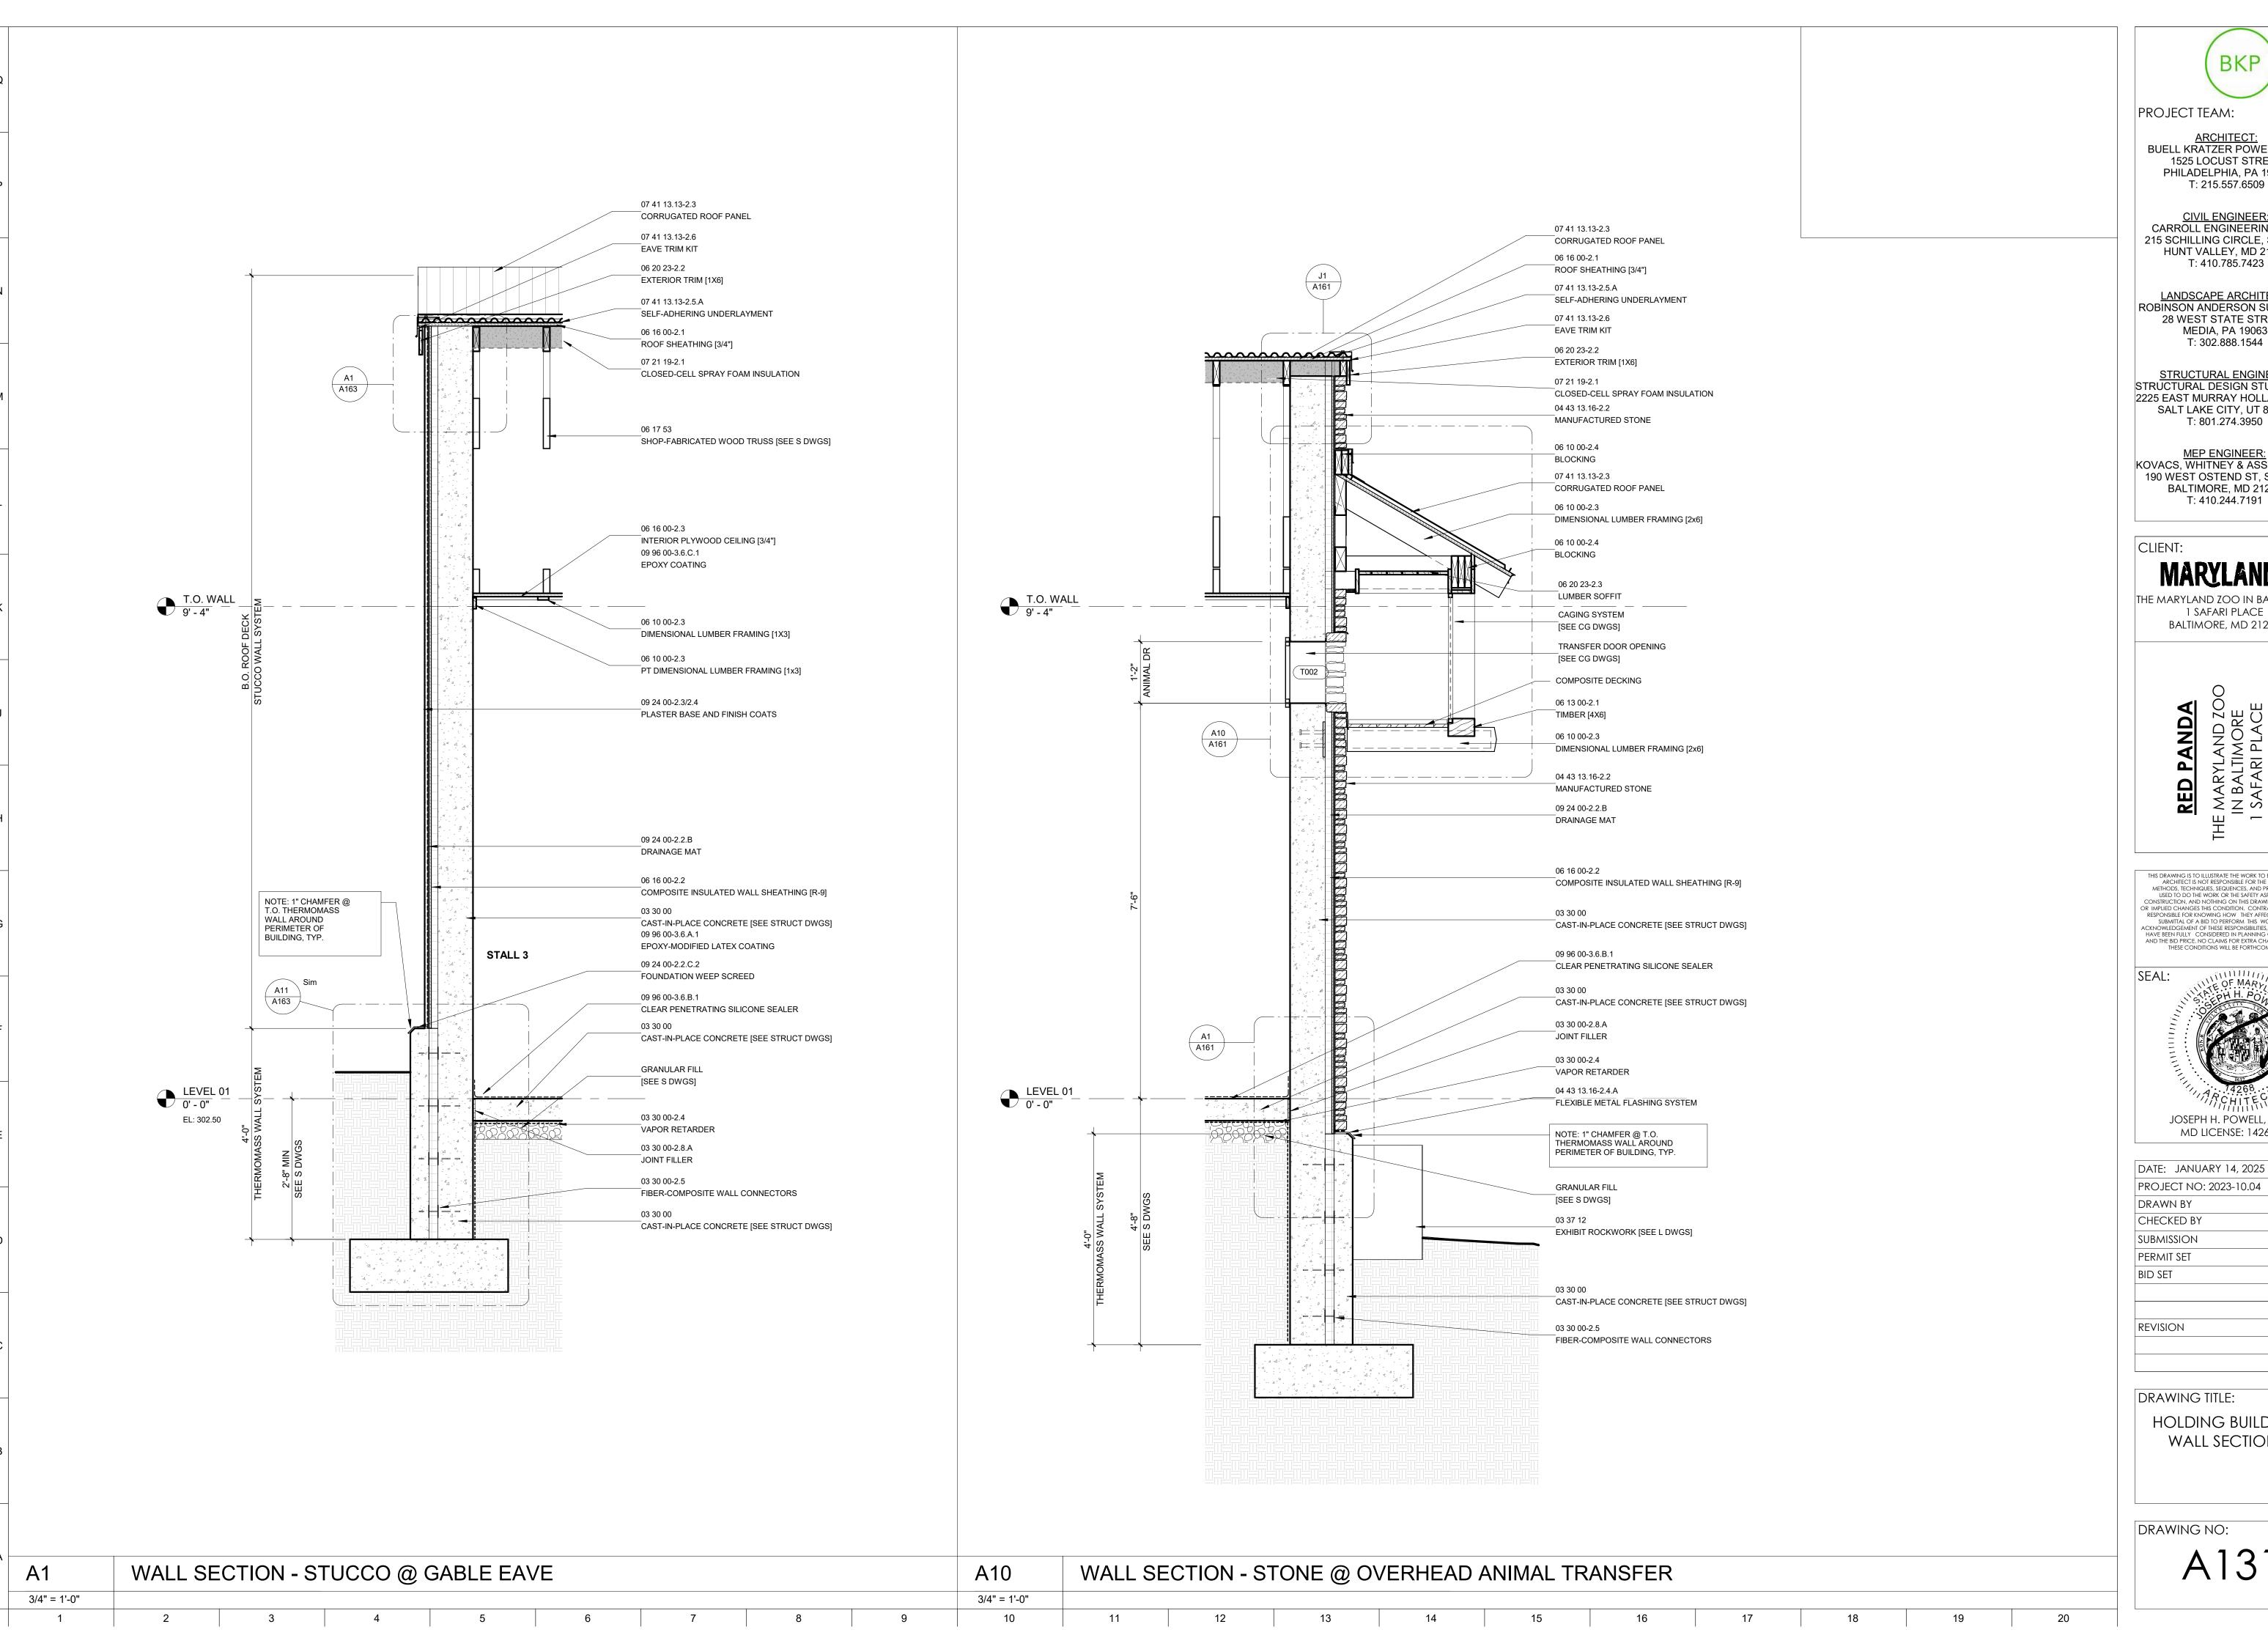



<u>ARCHITECT:</u> BUELL KRATZER POWELL, P.C. 1525 LOCUST STREET
PHILADELPHIA, PA 19102
T: 215.557.6509

<u>CIVIL ENGINEER:</u> CARROLL ENGINEERING, INC 215 SCHILLING CIRCLE, STE 102 HUNT VALLEY, MD 21031 T: 410.785.7423


LANDSCAPE ARCHITECT: ROBINSON ANDERSON SUMMERS 28 WEST STATE STREET MEDIA, PA 19063

<u>STRUCTURAL ENGINEER:</u> STRUCTURAL DESIGN STUDIO, INC 2225 EAST MURRAY HOLLADAY RD SALT LAKE CITY, UT 84117 T: 801.274.3950

MEP ENGINEER: KOVACS, WHITNEY & ASSOCIATES 190 WEST OSTEND ST, STE 300 BALTIMORE, MD 21230 T: 410.244.7191

THE MARYLAND ZOO IN BALTIMORE 1 SAFARI PLACE BALTIMORE, MD 21217


THIS DRAWING IS TO ILLUSTRATE THE WORK TO BE DONE. THE ARCHITECT IS NOT RESPONSIBLE FOR THE MEANS, METHODS, TECHNIQUES, SEQUENCES, AND PROCEDURES USED TO DO THE WORK OR THE SAFETY ASPECTS OF CONSTRUCTION, AND NOTHING ON THIS DRAWING EXPRESSED OR IMPLIED CHANGES THIS CONDITION, CONTRACTOR SHALL BE RESPONSIBLE FOR KNOWING HOW THEY AFFECT THE WORK. SUBMITTAL OF A BID TO PERFORM THIS WORK IS AN

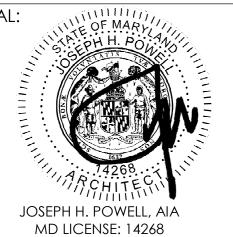

DATE: JANUARY 14, 2025	
PROJECT NO: 2023-10.04	
DRAWN BY	CC
CHECKED BY	JS
SUBMISSION	DATE
PERMIT SET	11/22/2024
BID SET	01/14/2025
REVISION	DATE

DRAWING TITLE:

HOLDING BUILDING WALL SECTIONS

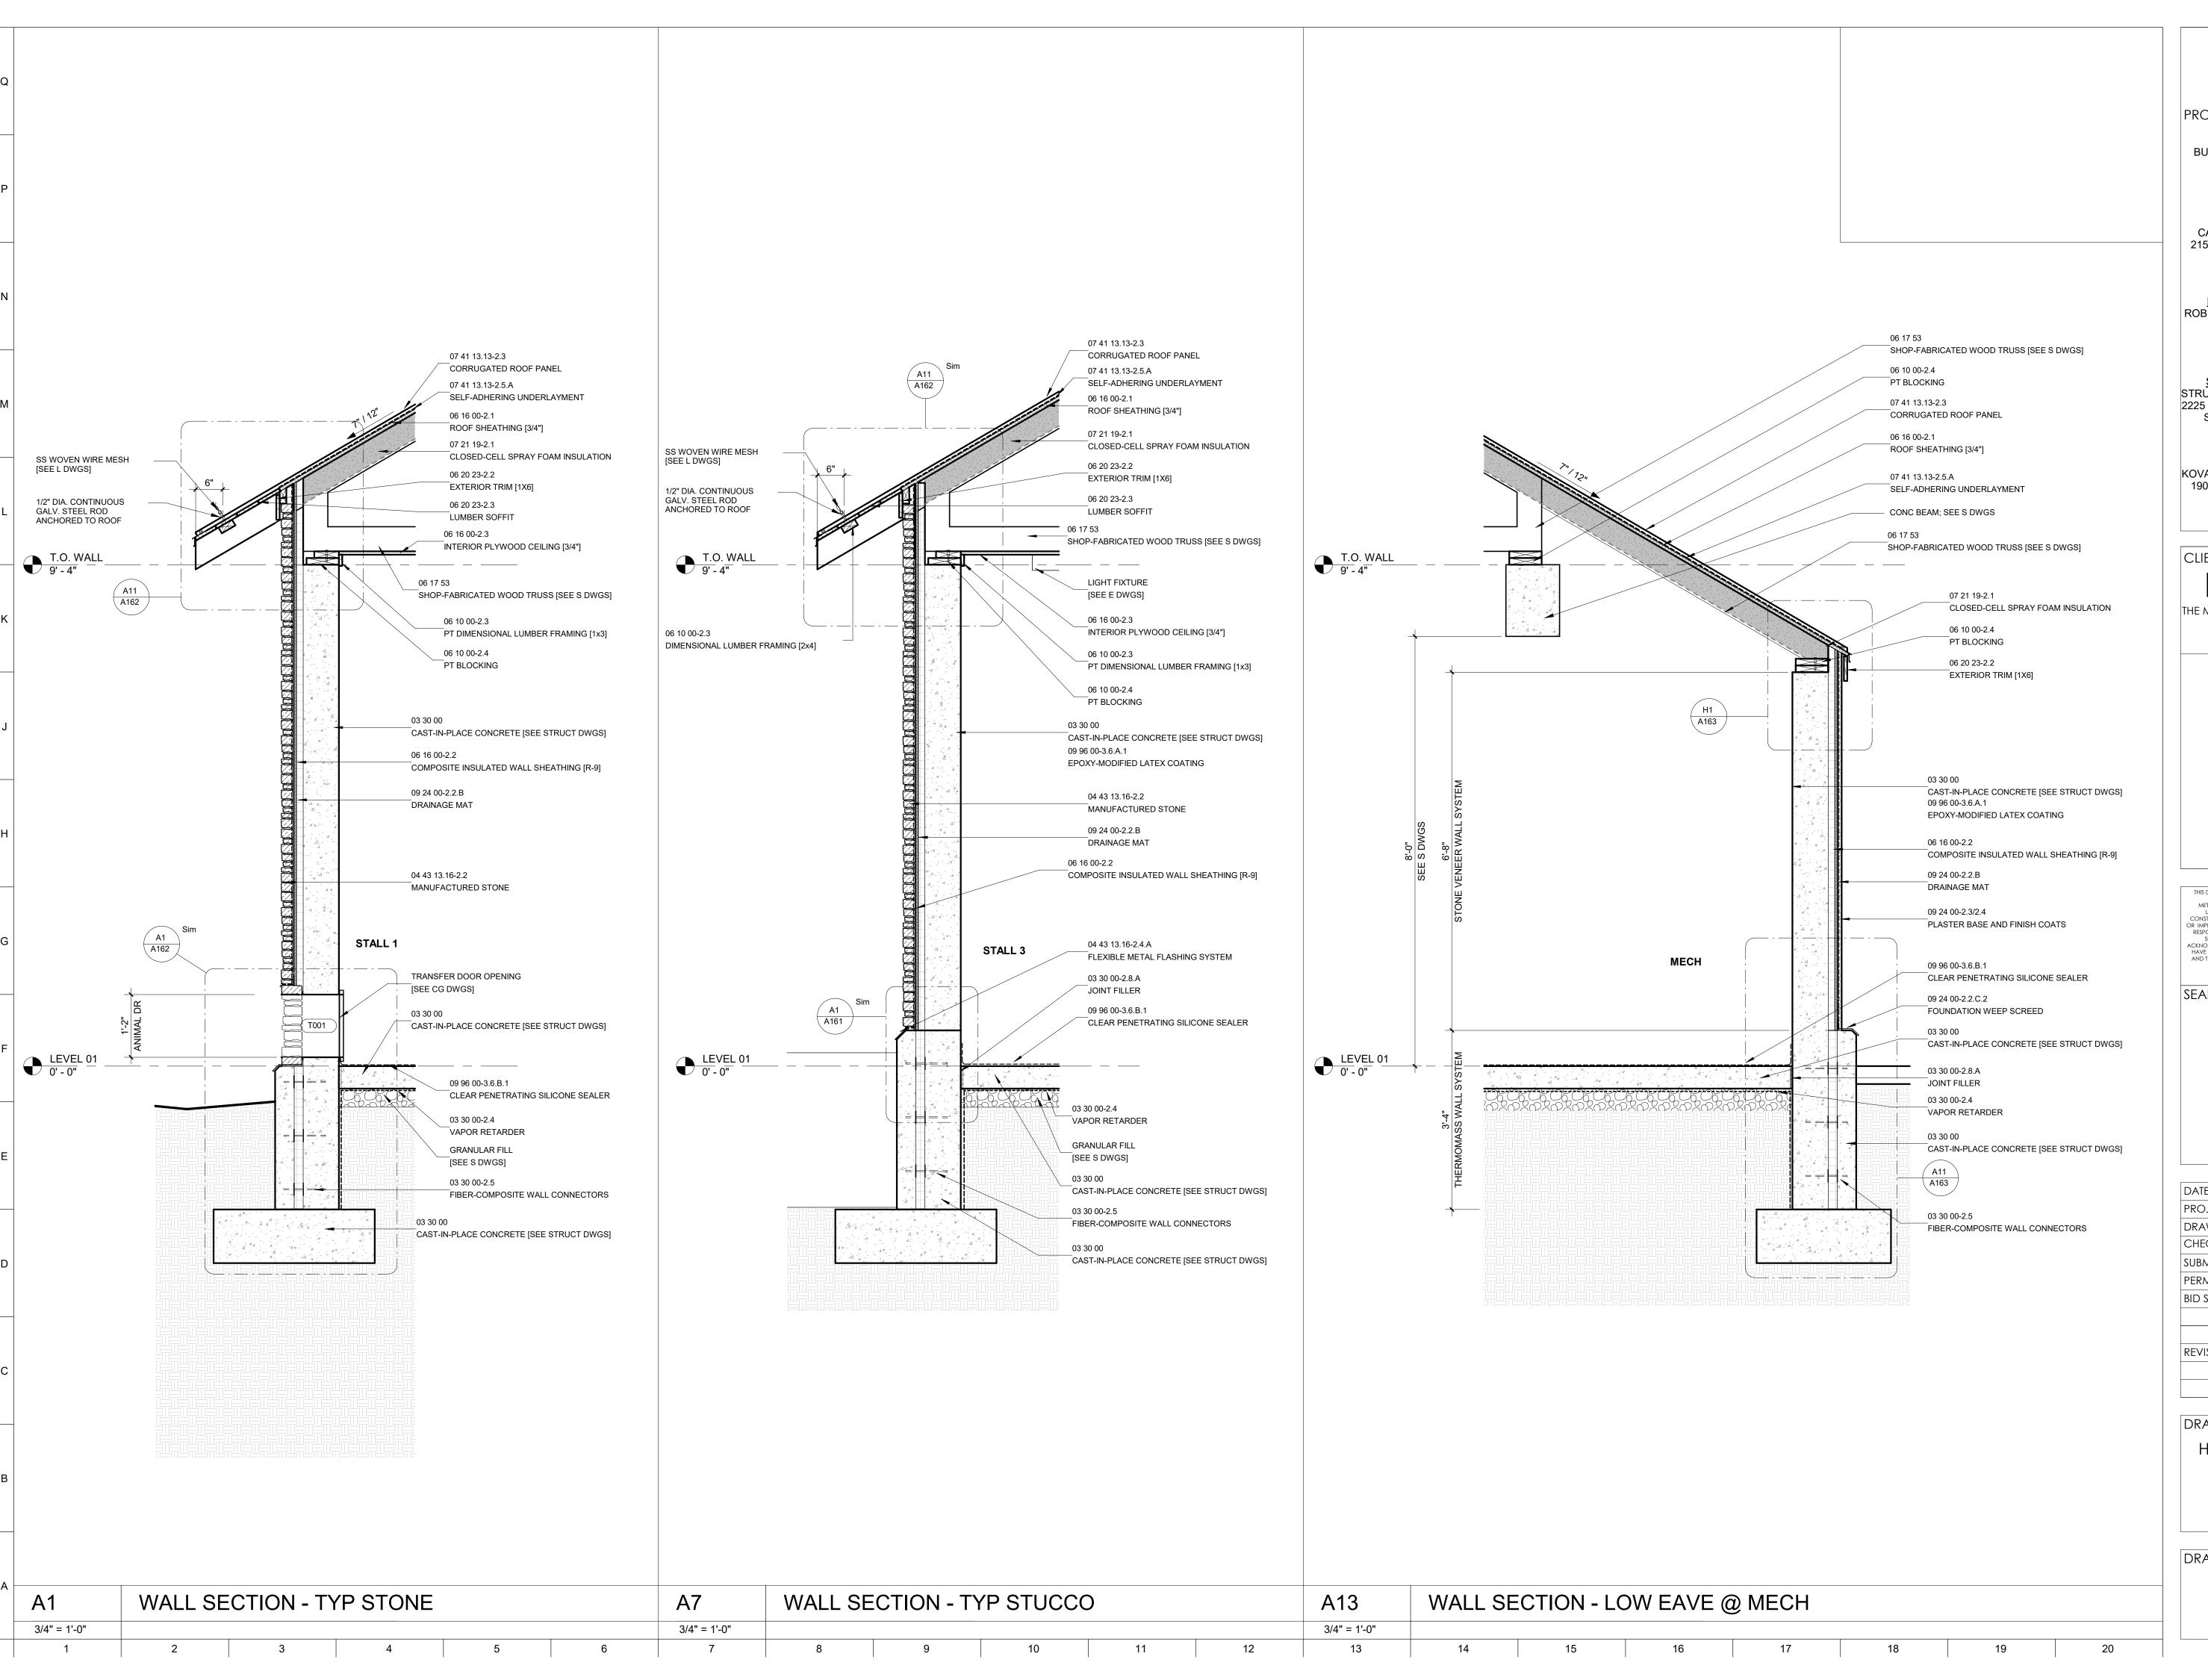



ARCHITECT:
BUELL KRATZER POWELL, P.C.
1525 LOCUST STREET
PHILADELPHIA, PA 19102
T: 215.557.6509

CIVIL ENGINEER: CARROLL ENGINEERING, INC 215 SCHILLING CIRCLE, STE 102 HUNT VALLEY, MD 21031 T: 410.785.7423

LANDSCAPE ARCHITECT:
ROBINSON ANDERSON SUMMERS
28 WEST STATE STREET
MEDIA, PA 19063

T: 302.888.1544

STRUCTURAL ENGINEER: STRUCTURAL DESIGN STUDIO, INC 2225 EAST MURRAY HOLLADAY RD SALT LAKE CITY, UT 84117 T: 801.274.3950

MEP ENGINEER:
KOVACS, WHITNEY & ASSOCIATES
190 WEST OSTEND ST, STE 300
BALTIMORE, MD 21230
T: 410.244.7191

MARYI AND 700


THE MARYLAND ZOO IN BALTIMORE

1 SAFARI PLACE

BALTIMORE, MD 21217

THE MARYLAND 200
IN BALTIMORE
1 SAFARI PLACE
BALTIMORE, MD 21217

THIS DRAWING IS TO ILLUSTRATE THE WORK TO BE DONE. THE
ARCHITECT IS NOT RESPONSIBLE FOR THE MEANS,
METHODS, TECHNIQUES, SEQUENCES, AND PROCEDURES
USED TO DO THE WORK OR THE SAFETY ASPECTS OF
CONSTRUCTION, AND NOTHINS ON THIS DRAWING EXPRESSED
OR IMPLIED CHANGES THIS CONDITION. CONTRACTOR SHALL BE
RESPONSIBLE FOR KNOWING HOW THEY AFFECT THE WORK.
SUBMITTAL OF A BID TO PERFORM THIS WORK IS AN
ACKNOWLEDGEMENT OF THESE RESPONSIBILITIES, AND THAT THEY
HAVE BEEN FULLY CONSIDERED IN PLANNING OF THE WORK,
AND THE RID PRICE NO CLI AIMS FOR EXTRA CHARGES DIE TO

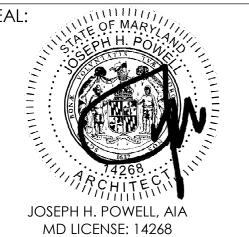


DATE: JANUARY 14, 2025	
PROJECT NO: 2023-10.04	
DRAWN BY	СС
CHECKED BY	JS
SUBMISSION	DATE
PERMIT SET	11/22/2024
BID SET	01/14/2025
REVISION	DATE

DRAWING TITLE:

HOLDING BUILDING WALL SECTIONS

DRAWING NO:

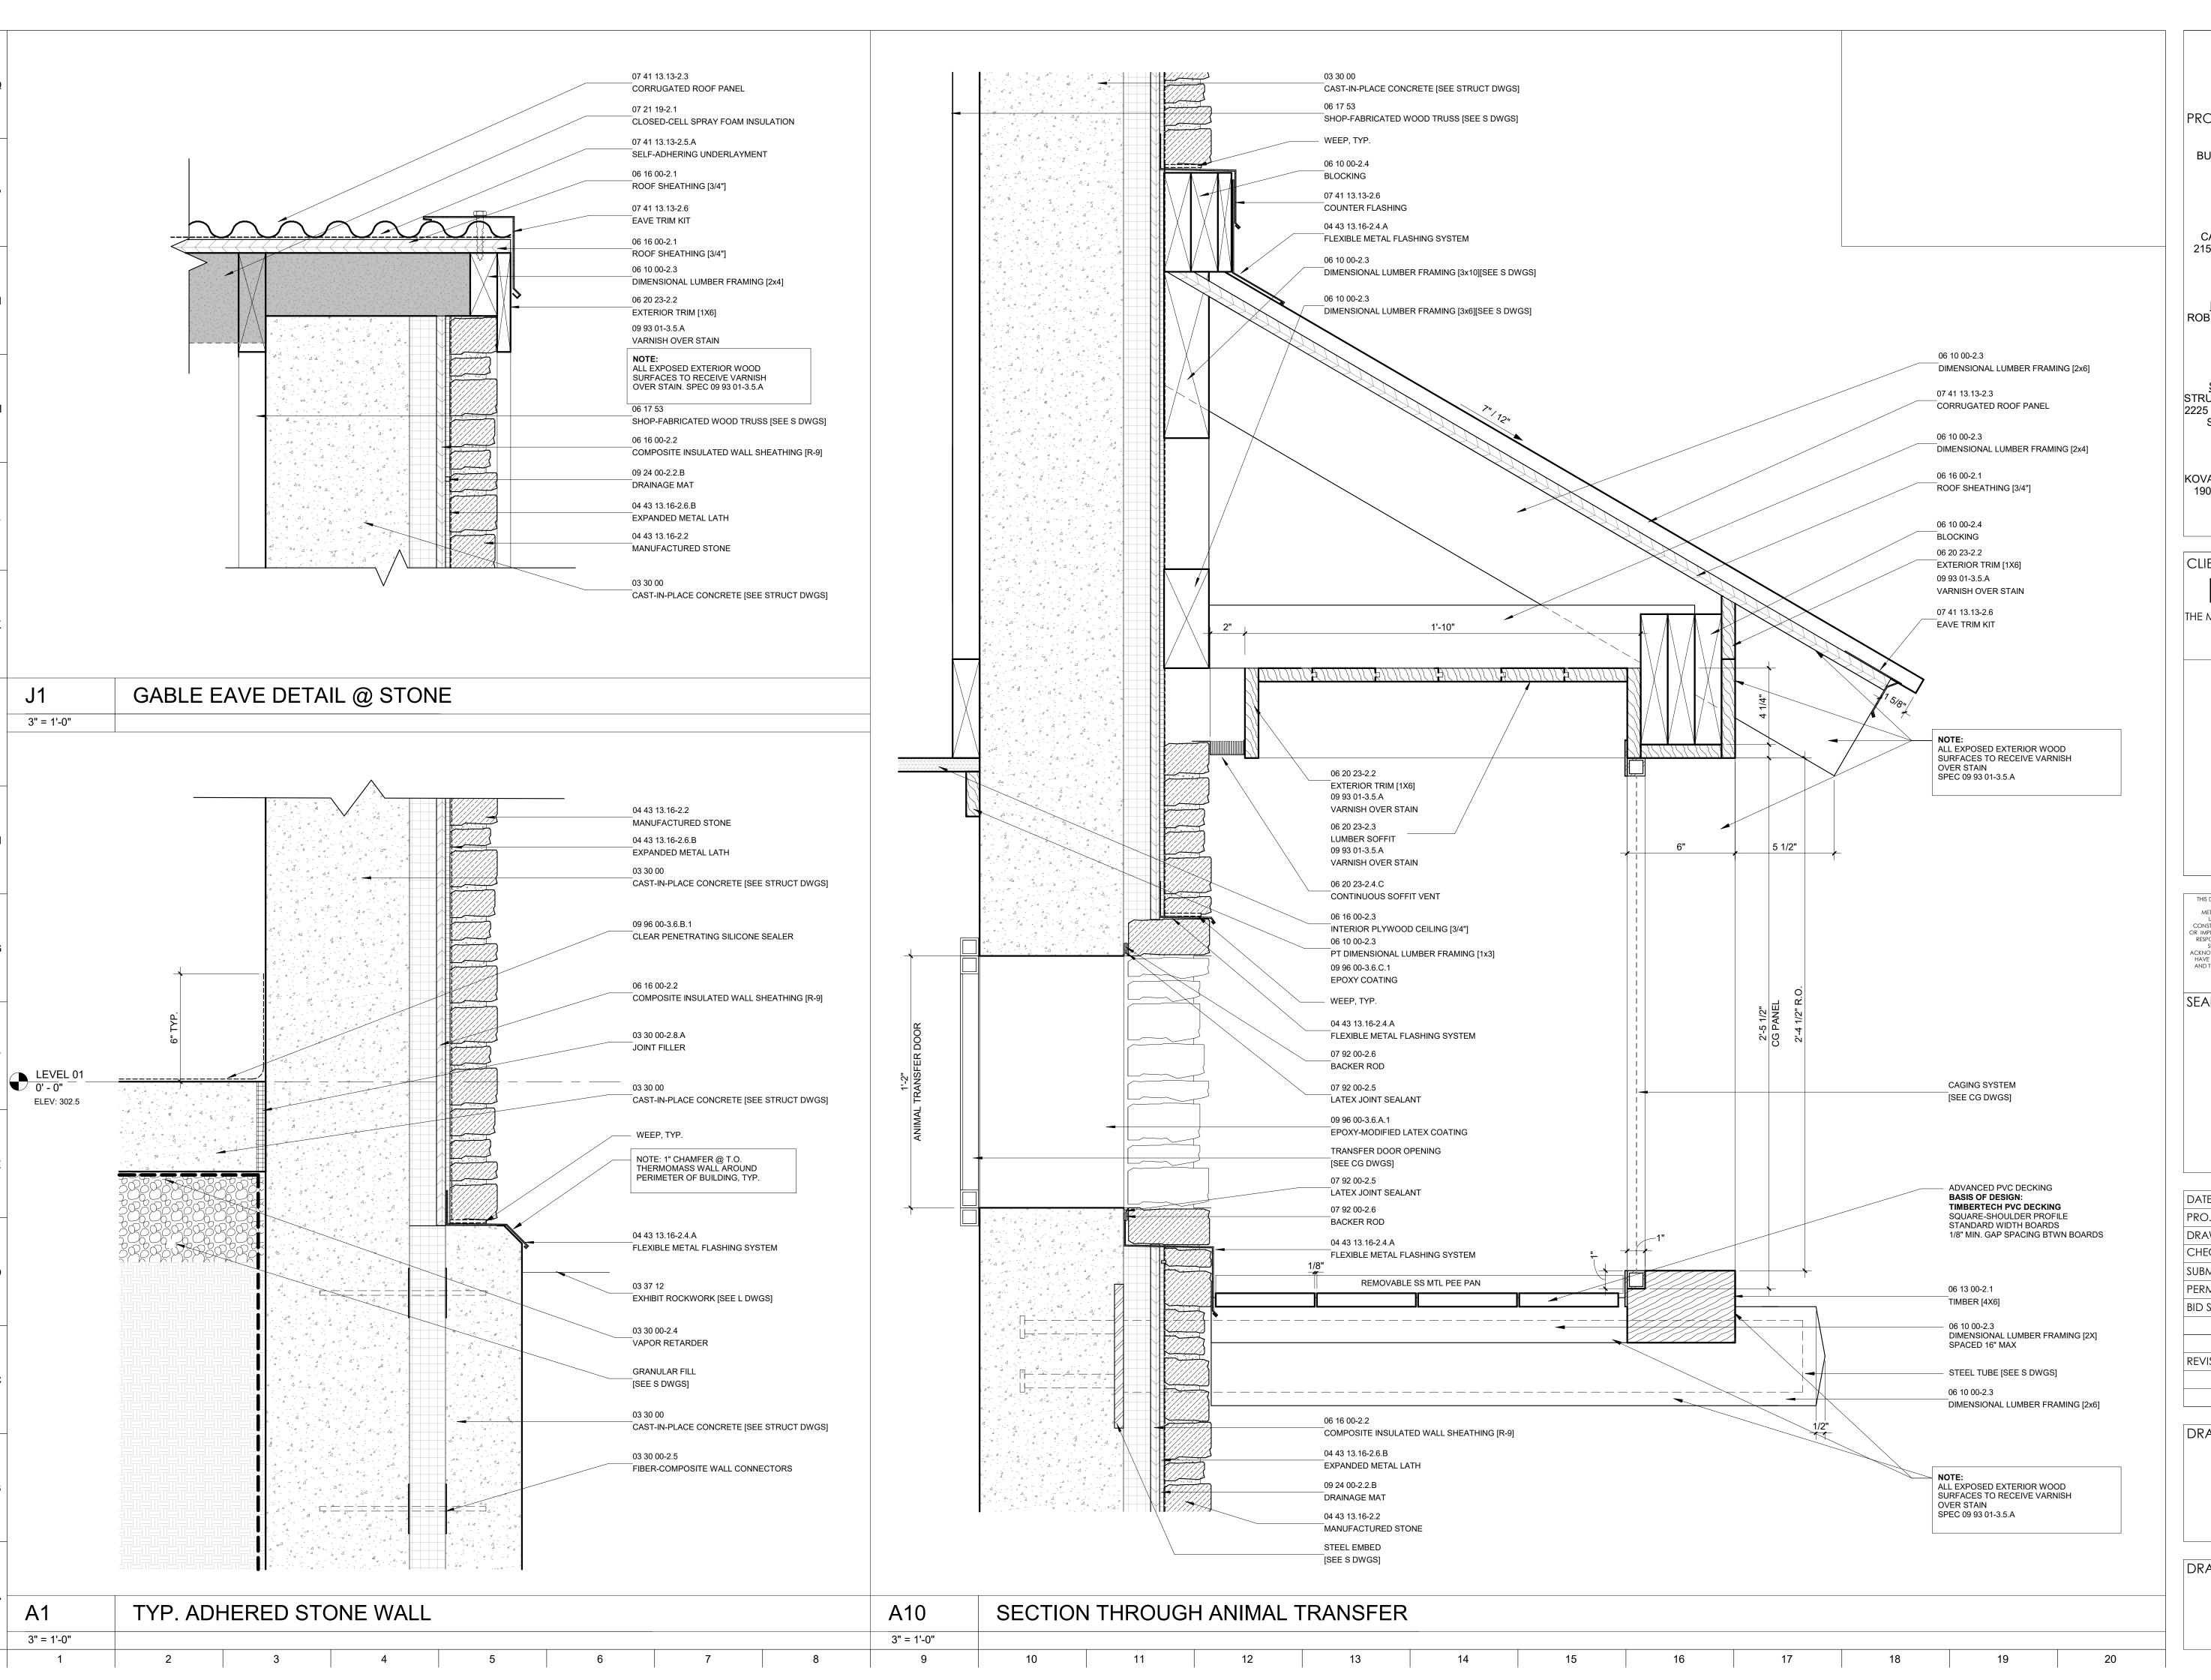



ARCHITECT:
BUELL KRATZER POWELL, P.C.
1525 LOCUST STREET
PHILADELPHIA, PA 19102
T: 215.557.6509

CIVIL ENGINEER:
CARROLL ENGINEERING, INC
215 SCHILLING CIRCLE, STE 102
HUNT VALLEY, MD 21031
T: 410.785.7423

LANDSCAPE ARCHITECT:
ROBINSON ANDERSON SUMMERS
28 WEST STATE STREET
MEDIA, PA 19063

T: 302.888.1544

STRUCTURAL ENGINEER: STRUCTURAL DESIGN STUDIO, INC 2225 EAST MURRAY HOLLADAY RD SALT LAKE CITY, UT 84117 T: 801.274.3950

MEP ENGINEER:
KOVACS, WHITNEY & ASSOCIATES
190 WEST OSTEND ST, STE 300
BALTIMORE, MD 21230
T: 410.244.7191

CLIENT:

## MARYLAND ZOO

THE MARYLAND ZOO IN BALTIMORE


1 SAFARI PLACE

BALTIMORE, MD 21217

RED PANDA

THE MARYLAND ZOO
IN BALTIMORE
1 SAFARI PLACE
ALTIMORE, MD 21217

THIS DRAWING IS TO ILLUSTRATE THE WORK TO BE DONE. THE
ARCHITECT IS NOT RESPONSIBLE FOR THE MEANS,
METHODS, TECHNIQUES, SEQUENCES, AND PROCEDURES
USED TO DO THE WORK OR THE SAFETY ASPECTS OF
CONSTRUCTION, AND NOTHING ON THIS DRAWING EXPRESSED
OR IMPLIED CHANGES THIS CONDITION. CONTRACTOR SHALL BE
RESPONSIBLE FOR KNOWING HOW THEY AFFECT THE WORK.
SUBMITTAL OF A BID TO PERFORM THIS WORK IS AN
ACKNOWLEDGEMENT OF THESE RESPONSIBILITIES, AND THAT THEY
HAVE BEEN FULLY CONSIDERED IN PLANNING OF THE WORK,
AND THE BID PRICE. NO CLAIMS FOR EXTRA CHARGES DUE TO
THESE CONDITIONS WILL BE FORTHCOMING.

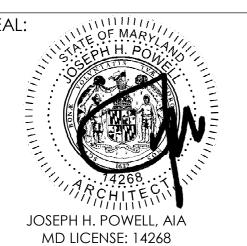


ATE: JANUARY 14, 2025	
ROJECT NO: 2023-10.04	
rawn by	CC
HECKED BY	JS
UBMISSION	DATE
ermit set	11/22/2024
ID SET	01/14/2025
EVISION	DATE

DRAWING TITLE:

CONSTRUCTION

DETAILS

DRAWING NO:

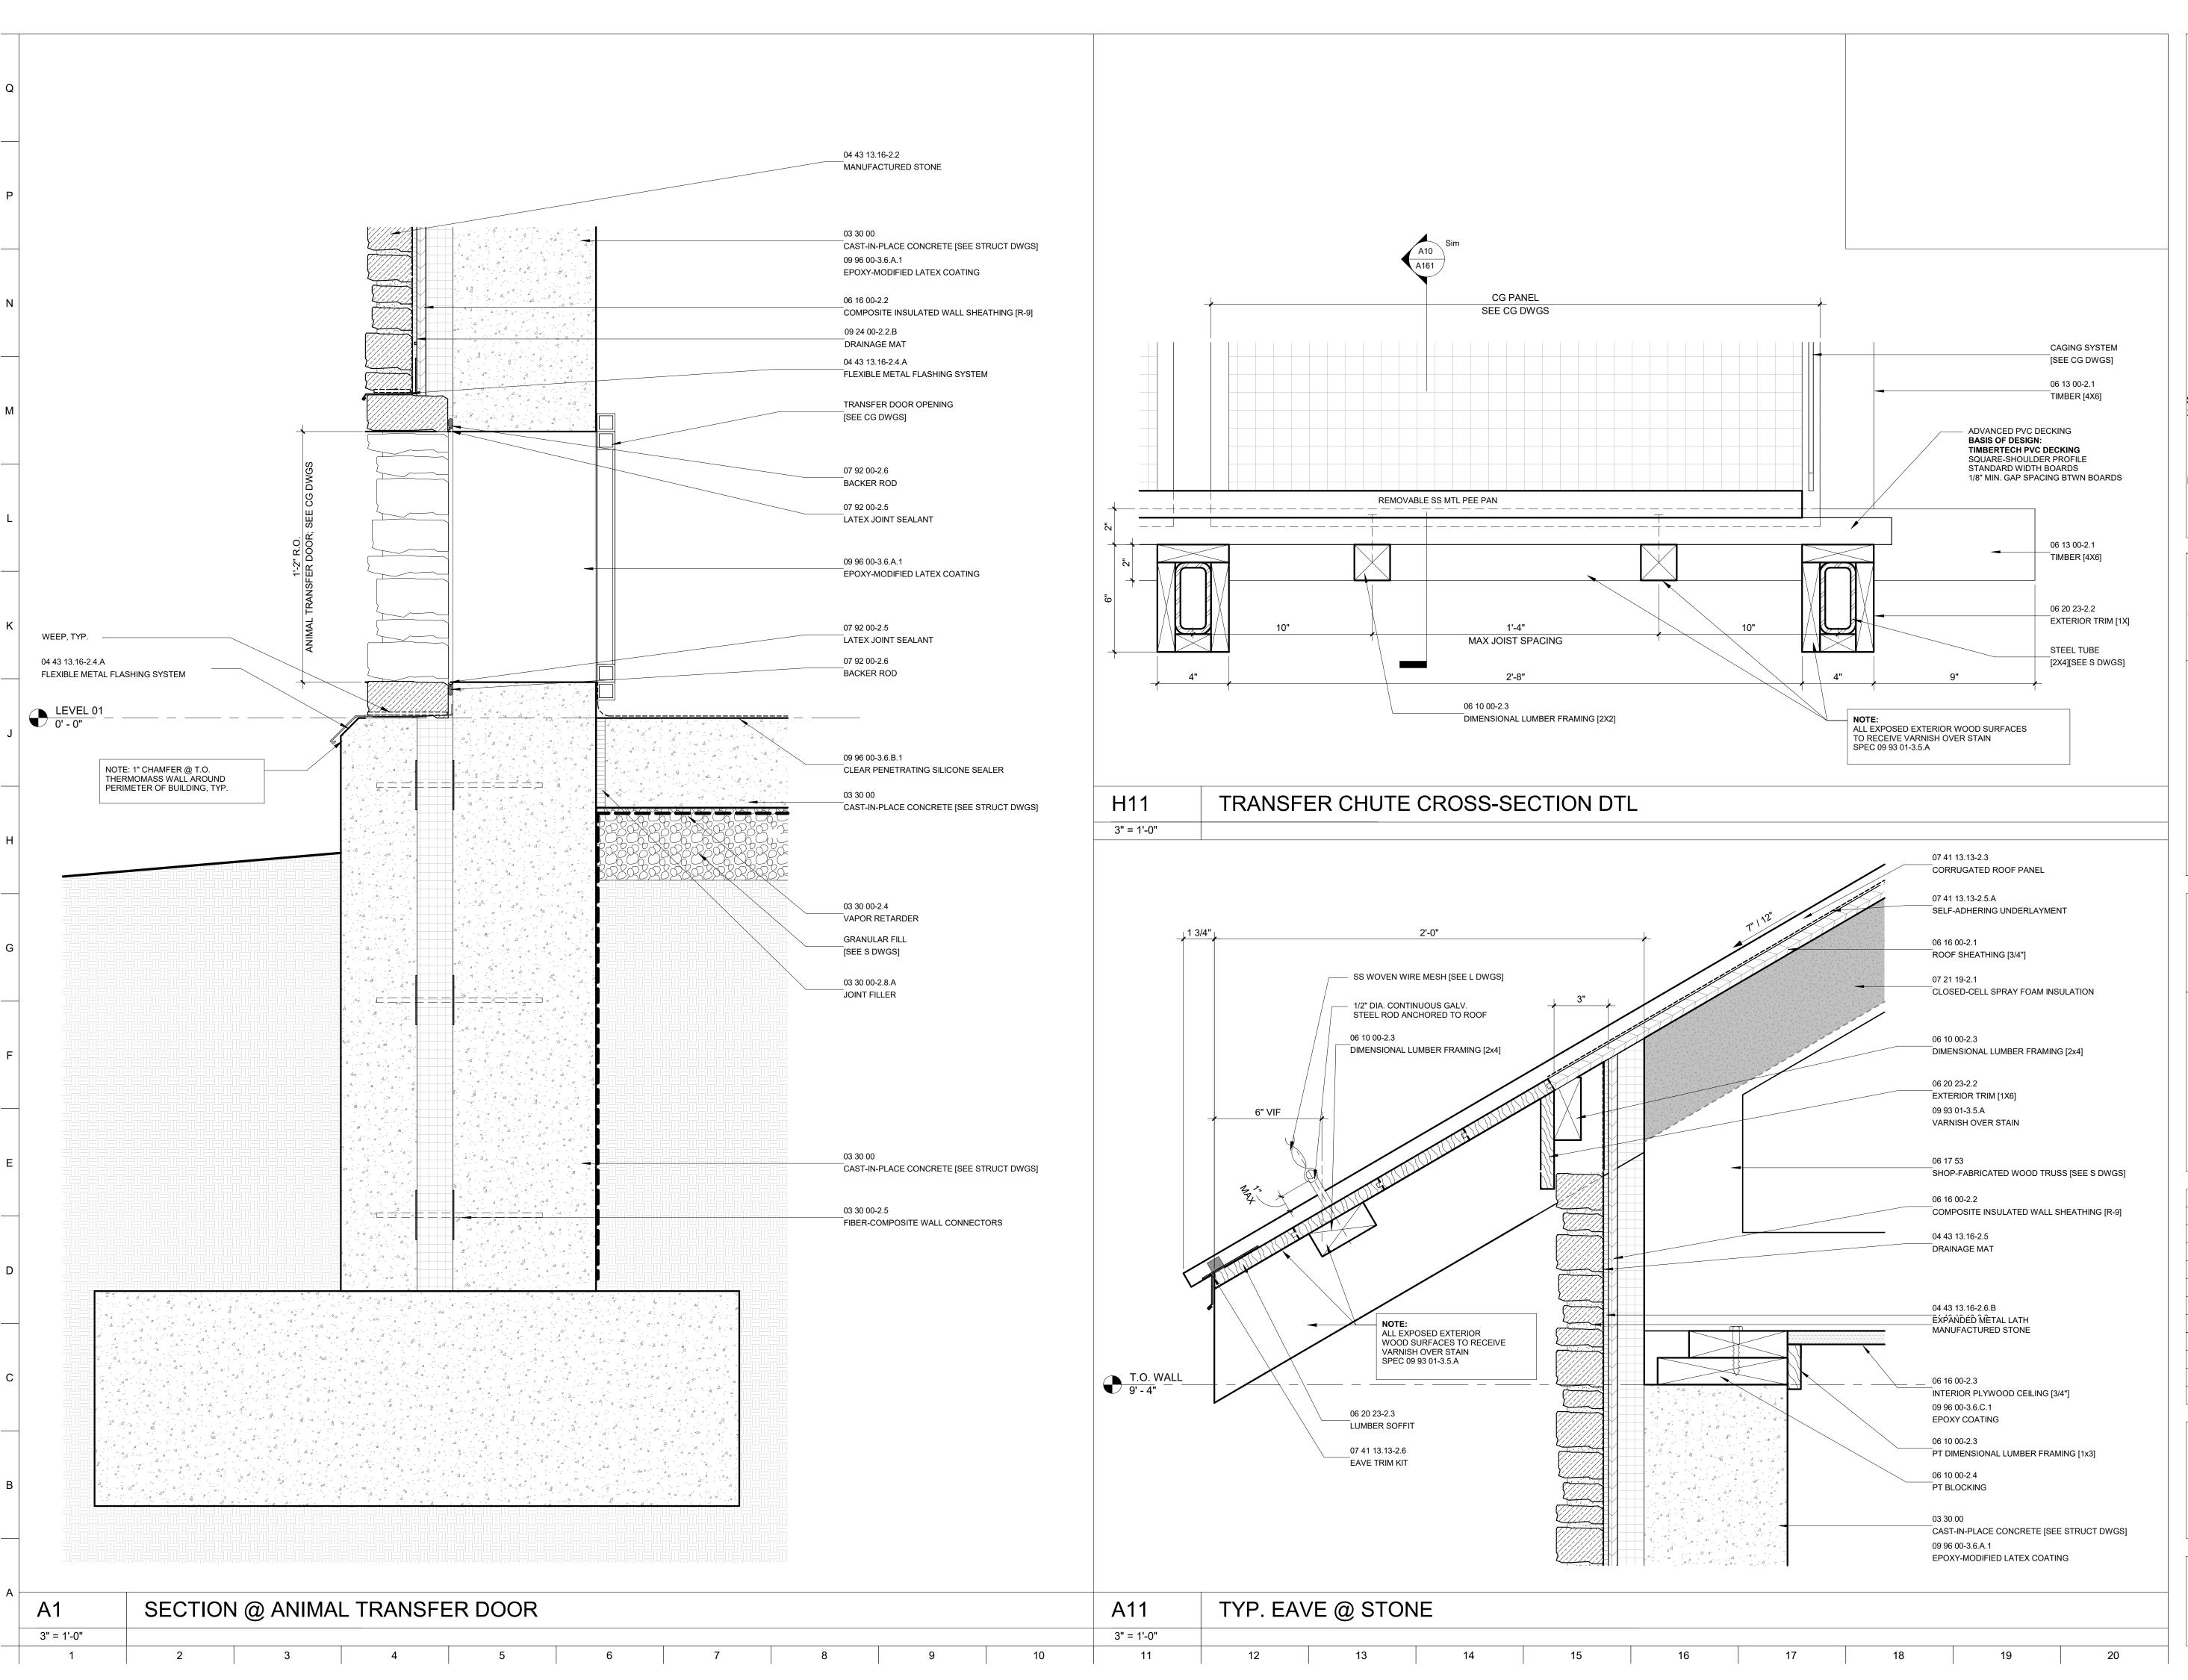



ARCHITECT:
BUELL KRATZER POWELL, P.C.
1525 LOCUST STREET
PHILADELPHIA, PA 19102
T: 215.557.6509

CIVIL ENGINEER: CARROLL ENGINEERING, INC 215 SCHILLING CIRCLE, STE 102 HUNT VALLEY, MD 21031 T: 410.785.7423

LANDSCAPE ARCHITECT:
ROBINSON ANDERSON SUMMERS
28 WEST STATE STREET
MEDIA, PA 19063

T: 302.888.1544

STRUCTURAL ENGINEER: STRUCTURAL DESIGN STUDIO, INC 2225 EAST MURRAY HOLLADAY RD SALT LAKE CITY, UT 84117 T: 801.274.3950

MEP ENGINEER:
KOVACS, WHITNEY & ASSOCIATES
190 WEST OSTEND ST, STE 300
BALTIMORE, MD 21230
T: 410.244.7191

CLIENT:

## MARYI AND 700


THE MARYLAND ZOO IN BALTIMORE

1 SAFARI PLACE

BALTIMORE, MD 21217

THE MARYLAND ZOO IN BALTIMORE 1 SAFARI PLACE BALTIMORE, MD 21217

THIS DRAWING IS TO ILLUSTRATE THE WORK TO BE DONE. THE ARCHITECT IS NOT RESPONSIBLE FOR THE MEANS, METHODS, TECHNIQUES, SEQUENCES, AND PROCEDURES USED TO DO THE WORK OR THE SAFETY ASPECTS OF CONSTRUCTION, AND NOTHING ON THIS DRAWING EXPRESSED OR IMPLIED CHANGES THIS CONDITION. CONTRACTOR SHALL BE RESPONSIBLE FOR KNOWING HOW THEY AFFECT THE WORK. SUBMITTAL OF A BID TO PERFORM THIS WORK IS AN ACKNOWLEDGEMENT OF THESE RESPONSIBILITIES, AND THAT THEY HAVE BEEN FULLY CONSIDERED IN PLANNING OF THE WORK, AND THE RID PRICE NO. CI AIMS FOR EXTRA CHARGES DUILT OF

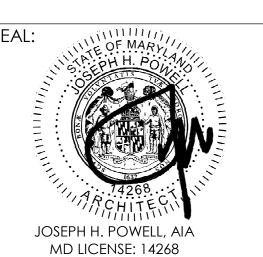


DATE: JANUARY 14, 2025	
PROJECT NO: 2023-10.04	
DRAWN BY	CC
CHECKED BY	JS
SUBMISSION	DATE
PERMIT SET	11/22/2024
BID SET	01/14/2025
REVISION	DATE

DRAWING TITLE:

CONSTRUCTION DETAILS

DRAWING NO:

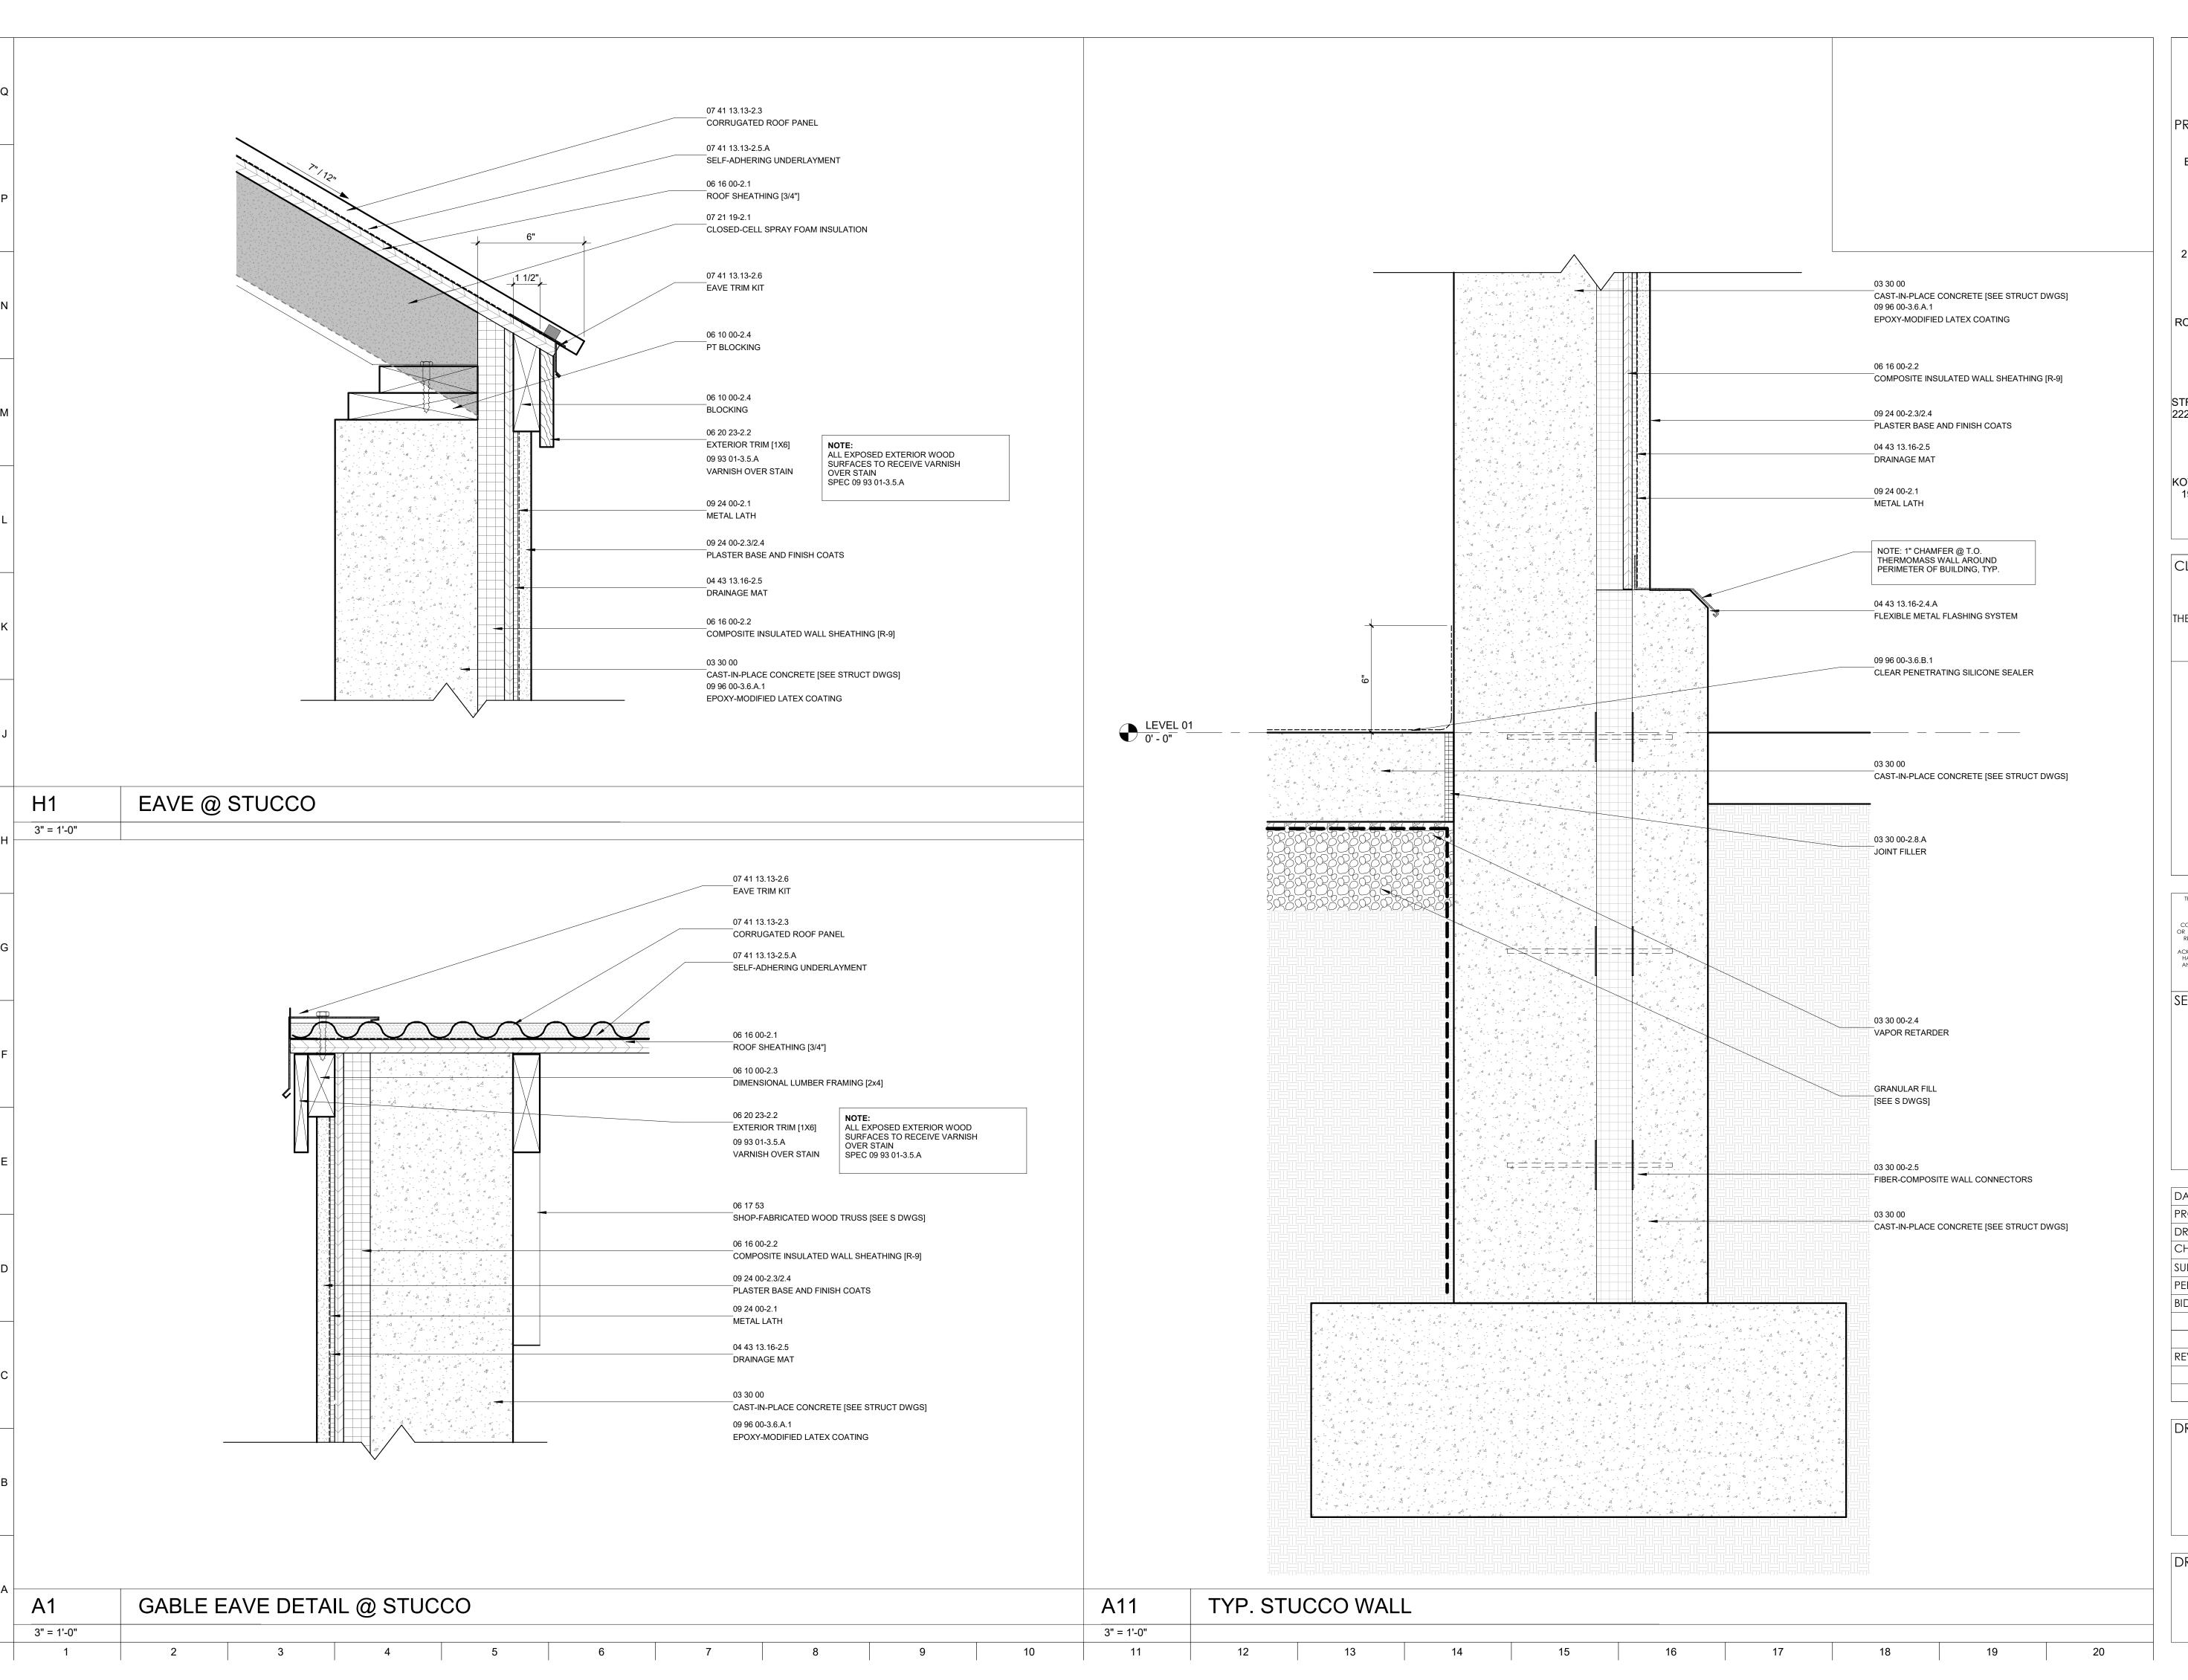



ARCHITECT:
BUELL KRATZER POWELL, P.C.
1525 LOCUST STREET
PHILADELPHIA, PA 19102
T: 215.557.6509

CIVIL ENGINEER: CARROLL ENGINEERING, INC 215 SCHILLING CIRCLE, STE 102 HUNT VALLEY, MD 21031 T: 410.785.7423

LANDSCAPE ARCHITECT:
ROBINSON ANDERSON SUMMERS
28 WEST STATE STREET
MEDIA, PA 19063
T: 302.888.1544

STRUCTURAL ENGINEER: STRUCTURAL DESIGN STUDIO, INC 2225 EAST MURRAY HOLLADAY RD SALT LAKE CITY, UT 84117 T: 801.274.3950

MEP ENGINEER:
KOVACS, WHITNEY & ASSOCIATES
190 WEST OSTEND ST, STE 300
BALTIMORE, MD 21230
T: 410.244.7191

CLIENT:

# MARYLAND ZQO


THE MARYLAND ZOO IN BALTIMORE

1 SAFARI PLACE

BALTIMORE, MD 21217

THE MARYLAND ZOO
IN BALTIMORE
1 SAFARI PLACE
3ALTIMORE, MD 21217

THIS DRAWING IS TO ILLUSTRATE THE WORK TO BE DONE. THE
ARCHITECT IS NOT RESPONSIBLE FOR THE MEANS,
METHODS, TECHNIQUES, SEQUENCES, AND PROCEDURES
USED TO DO THE WORK OR THE SAFETY ASPECTS OF
CONSTRUCTION, AND NOTHING ON THIS DRAWING EXPRESSED
OR IMPLIED CHANGES THIS CONDITION. CONTRACTOR SHALL BE
RESPONSIBLE FOR KNOWING HOW THEY AFFECT THE WORK.
SUBMITTAL OF A BID TO PERFORM THIS WORK IS AN
ACKNOWLEDGEMENT OF THESE RESPONSIBILITIES, AND THAT THEY
HAVE BEEN FULLY CONSIDERED IN PLANNING OF THE WORK,
AND THE BID PRICE. NO CLAIMS FOR EXTRA CHARGES DUE TO
THESE CONDITIONS WILL BE FORTHCOMING.

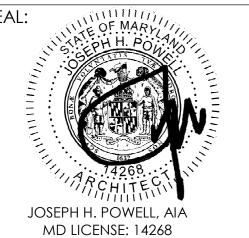

1115 2102110211120	•
DATE: JANUARY 14, 2025	
PROJECT NO: 2023-10.04	
DRAWN BY	CC
CHECKED BY	JS
SUBMISSION	DATE
PERMIT SET	11/22/2024
BID SET	01/14/2025
REVISION	DATE

DRAWING TITLE:

CONSTRUCTION DETAILS

DRAWING NO: