



ARCHITECT: BUELL KRATZER POWELL, P.C. 1525 LOCUST STREET PHILADELPHIA, PA 19102 T: 215.557.6509

CIVIL ENGINEER: CARROLL ENGINEERING, INC 215 SCHILLING CIRCLE, STE 102 HUNT VALLEY, MD 21031 T: 410.785.7423

LANDSCAPE ARCHITECT: ROBINSON ANDERSON SUMMERS 28 WEST STATE STREET MEDIA, PA 19063 T: 302.888.1544

STRUCTURAL ENGINEER: STRUCTURAL DESIGN STUDIO, INC 2225 EAST MURRAY HOLLADAY RD SALT LAKE CITY, UT 84117 T: 801.274.3950

MEP ENGINEER: KOVACS, WHITNEY & ASSOCIATES 190 WEST OSTEND ST, STE 300 BALTIMORE, MD 21230 T: 410.244.7191

THE MARYLAND ZOO IN BALTIMORE 1 SAFARI PLACE BALTIMORE, MD 21217


THIS DRAWING IS TO ILLUSTRATE THE WORK TO BE DONE. THE ARCHITECT IS NOT RESPONSIBLE FOR THE MEANS, USED TO DO THE WORK OR THE SAFETY ASPECTS OF CONSTRUCTION, AND NOTHING ON THIS DRAWING EXPRESSED OR IMPLIED CHANGES THIS CONDITION. CONTRACTOR SHALL BE RESPONSIBLE FOR KNOWING HOW THEY AFFECT THE WORK. SUBMITTAL OF A BID TO PERFORM THIS WORK IS AN ACKNOWLEDGEMENT OF THESE RESPONSIBILITIES, AND THAT THEY HAVE BEEN FULLY CONSIDERED IN PLANNING OF THE WORK, AND THE BID PRICE. NO CLAIMS FOR EXTRA CHARGES DUE TO THESE CONDITIONS WILL BE FORTHCOMING.



MD LICENSE: 14268

DATE: NOVEMBER 22, 2024 PROJECT NO: 2023-10.04 CC DRAWN BY CHECKED BY JS DATE SUBMISSION 11/22/2024 PERMIT SET REVISION DATE

DRAWING TITLE: HOLDING BUILDING

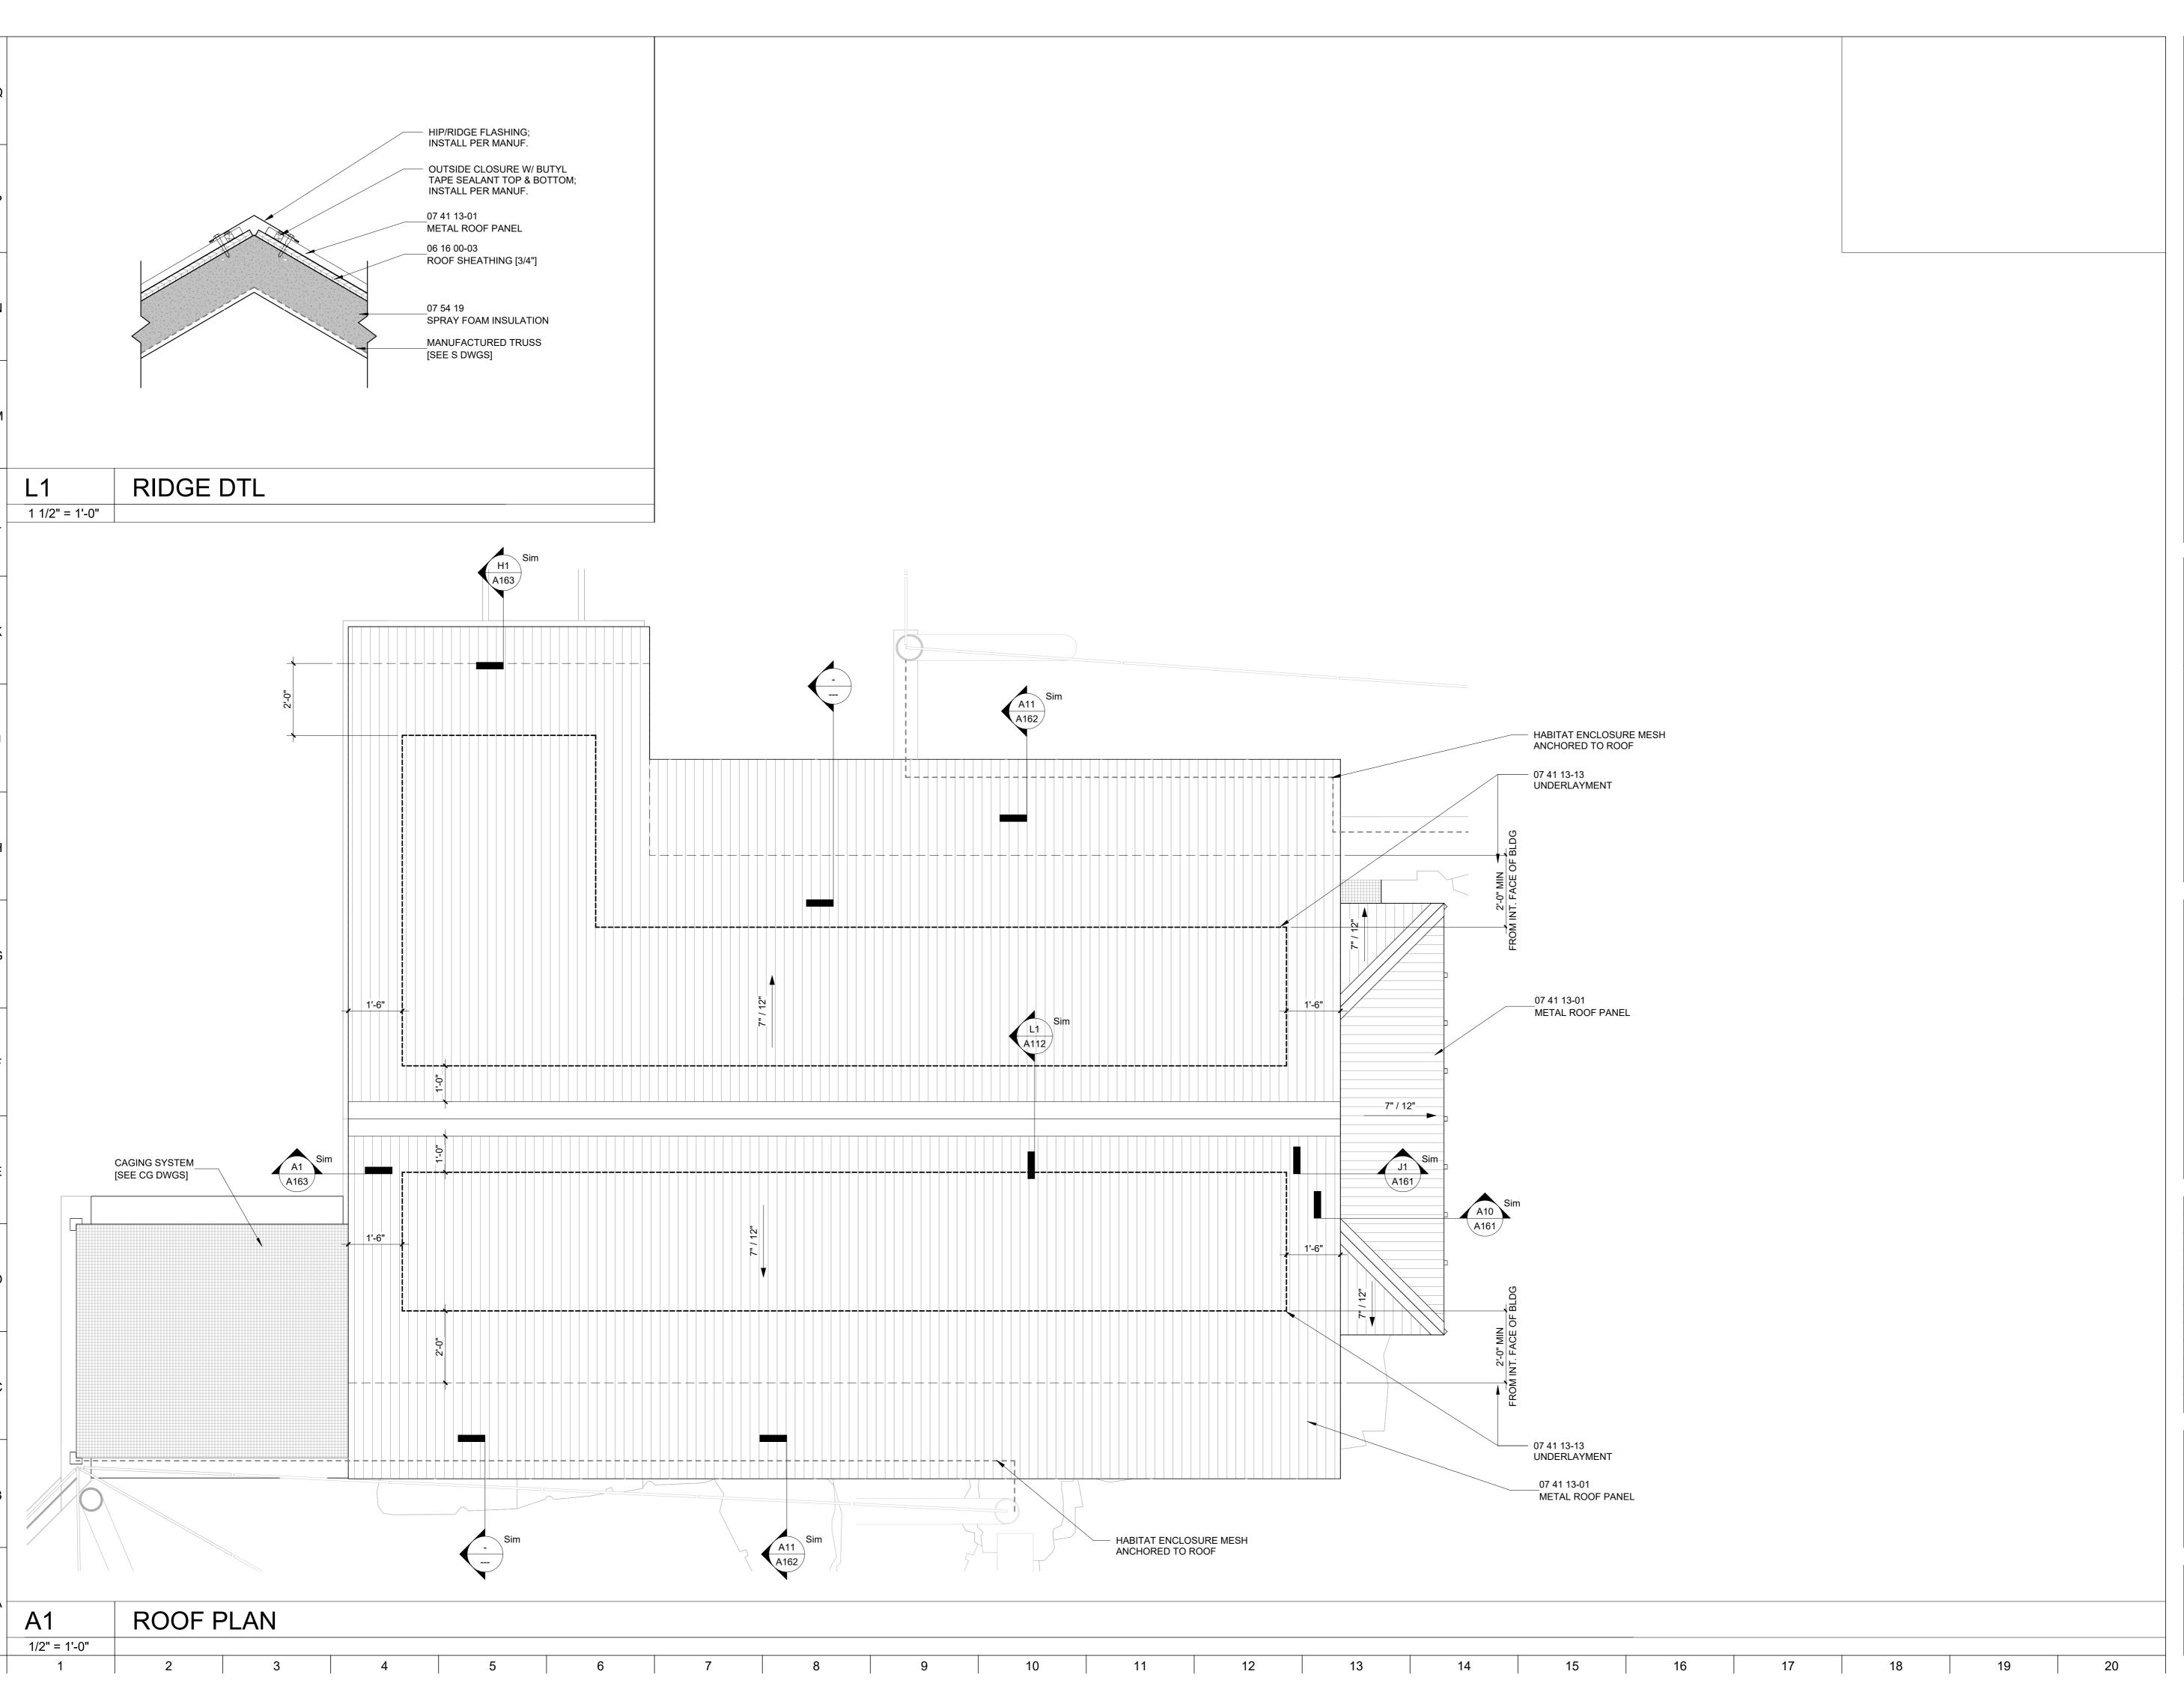



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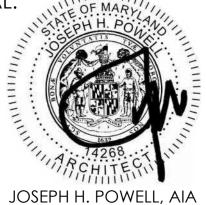
CLIENT:

THE MARYLAND ZOO IN BALTIMORE 1 SAFARI PLACE BALTIMORE, MD 21217

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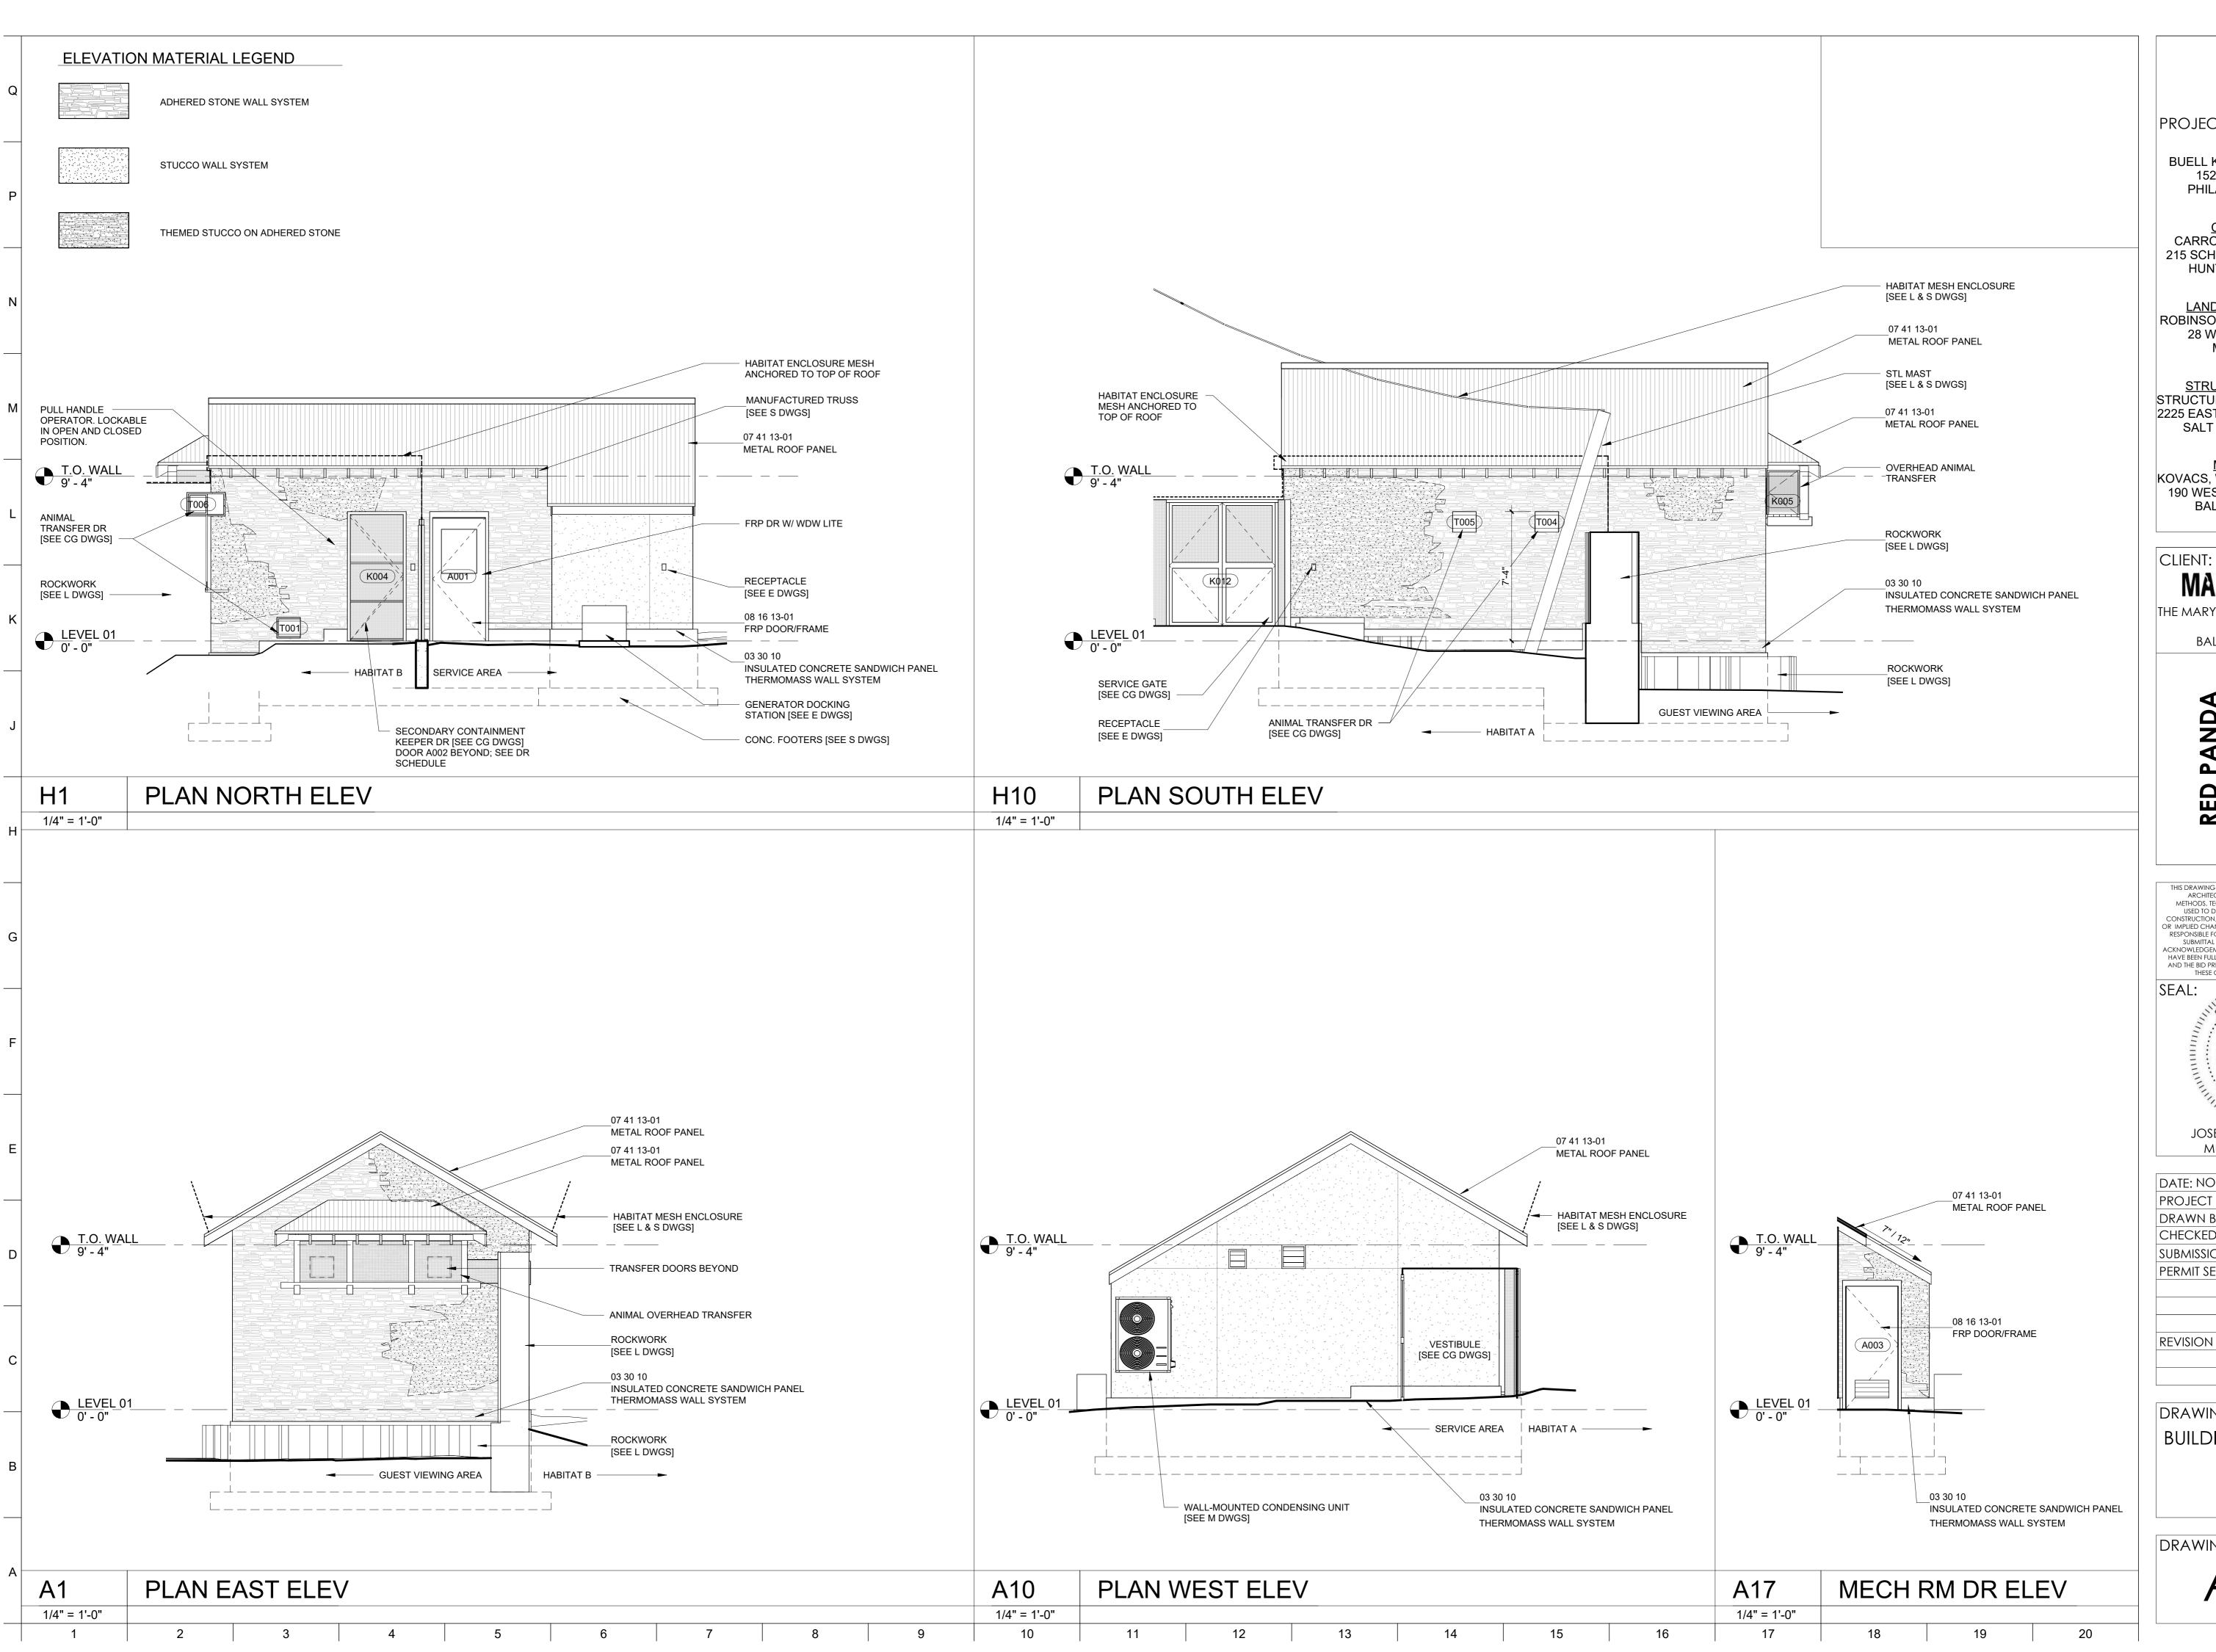




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DRAWING TITLE: HOLDING BUILDING **ROOF PLAN**





ARCHITECT: BUELL KRATZER POWELL, P.C. 1525 LOCUST STREET PHILADELPHIA, PA 19102 T: 215.557.6509

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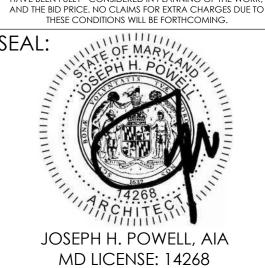
LANDSCAPE ARCHITECT: ROBINSON ANDERSON SUMMERS 28 WEST STATE STREET MEDIA, PA 19063 T: 302.888.1544

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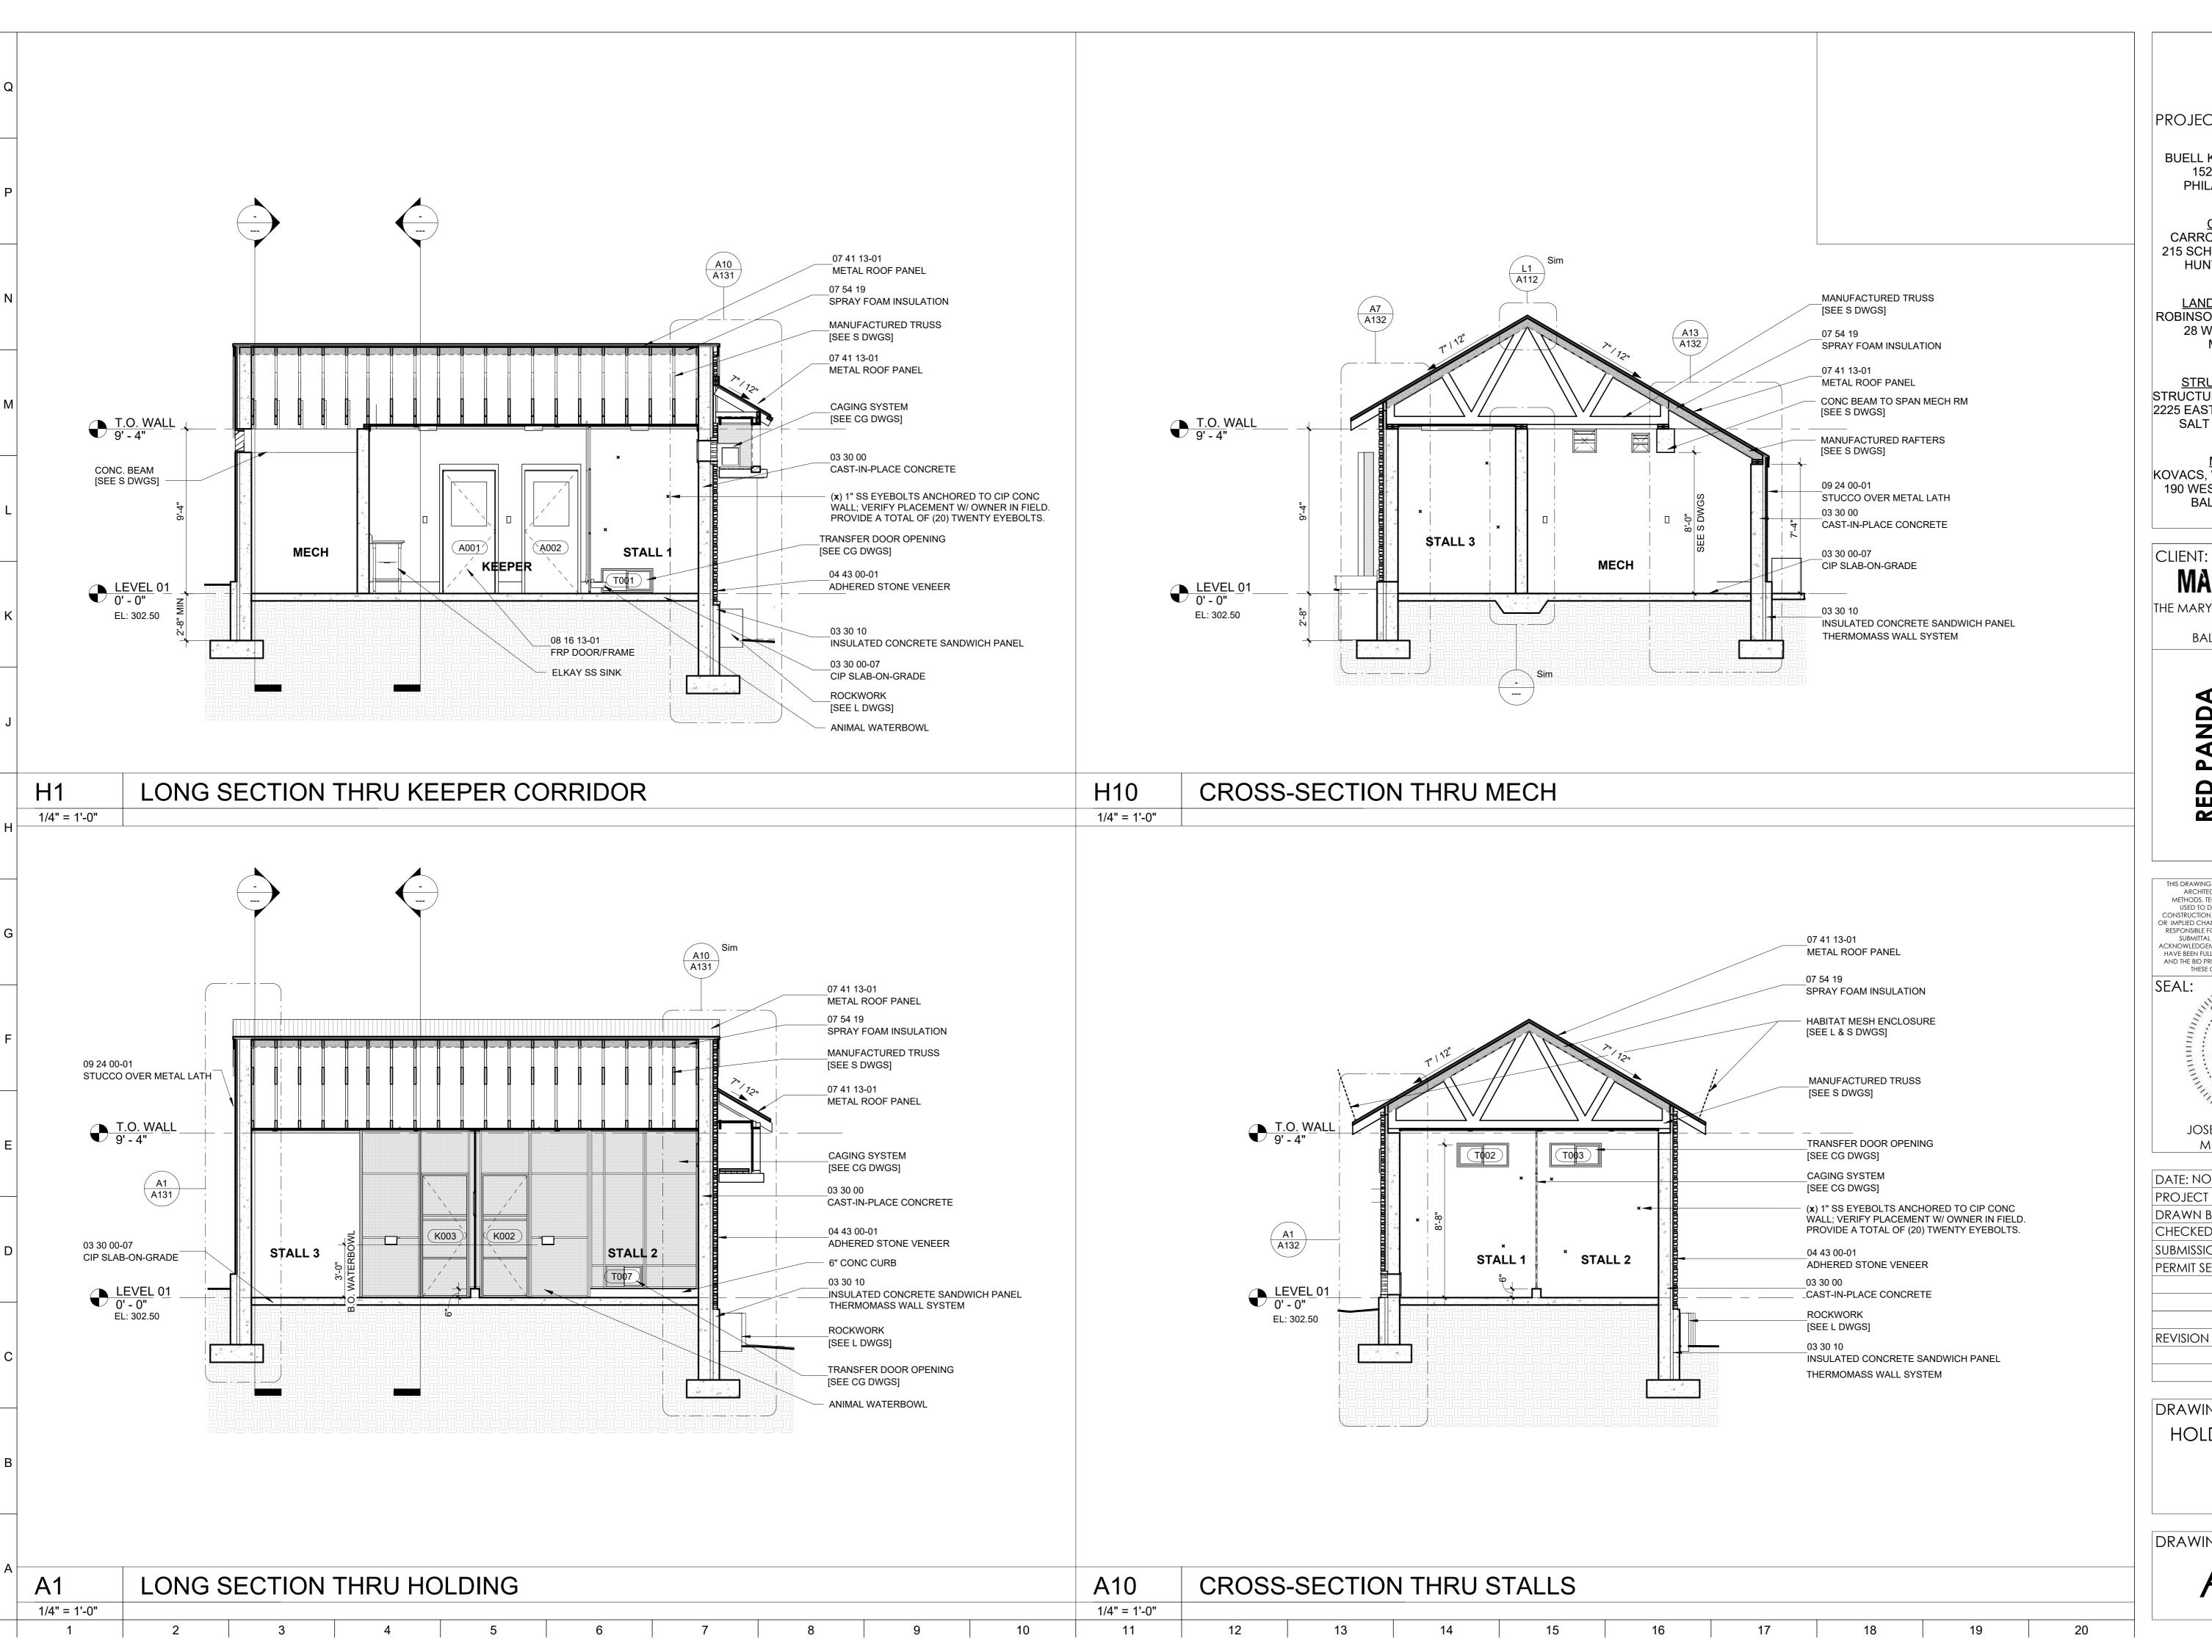
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DRAWING TITLE: BUILDING ELEVATIONS





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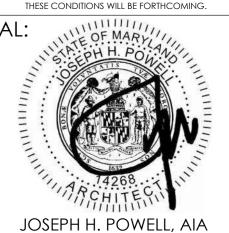
LANDSCAPE ARCHITECT: ROBINSON ANDERSON SUMMERS 28 WEST STATE STREET MEDIA, PA 19063 T: 302.888.1544

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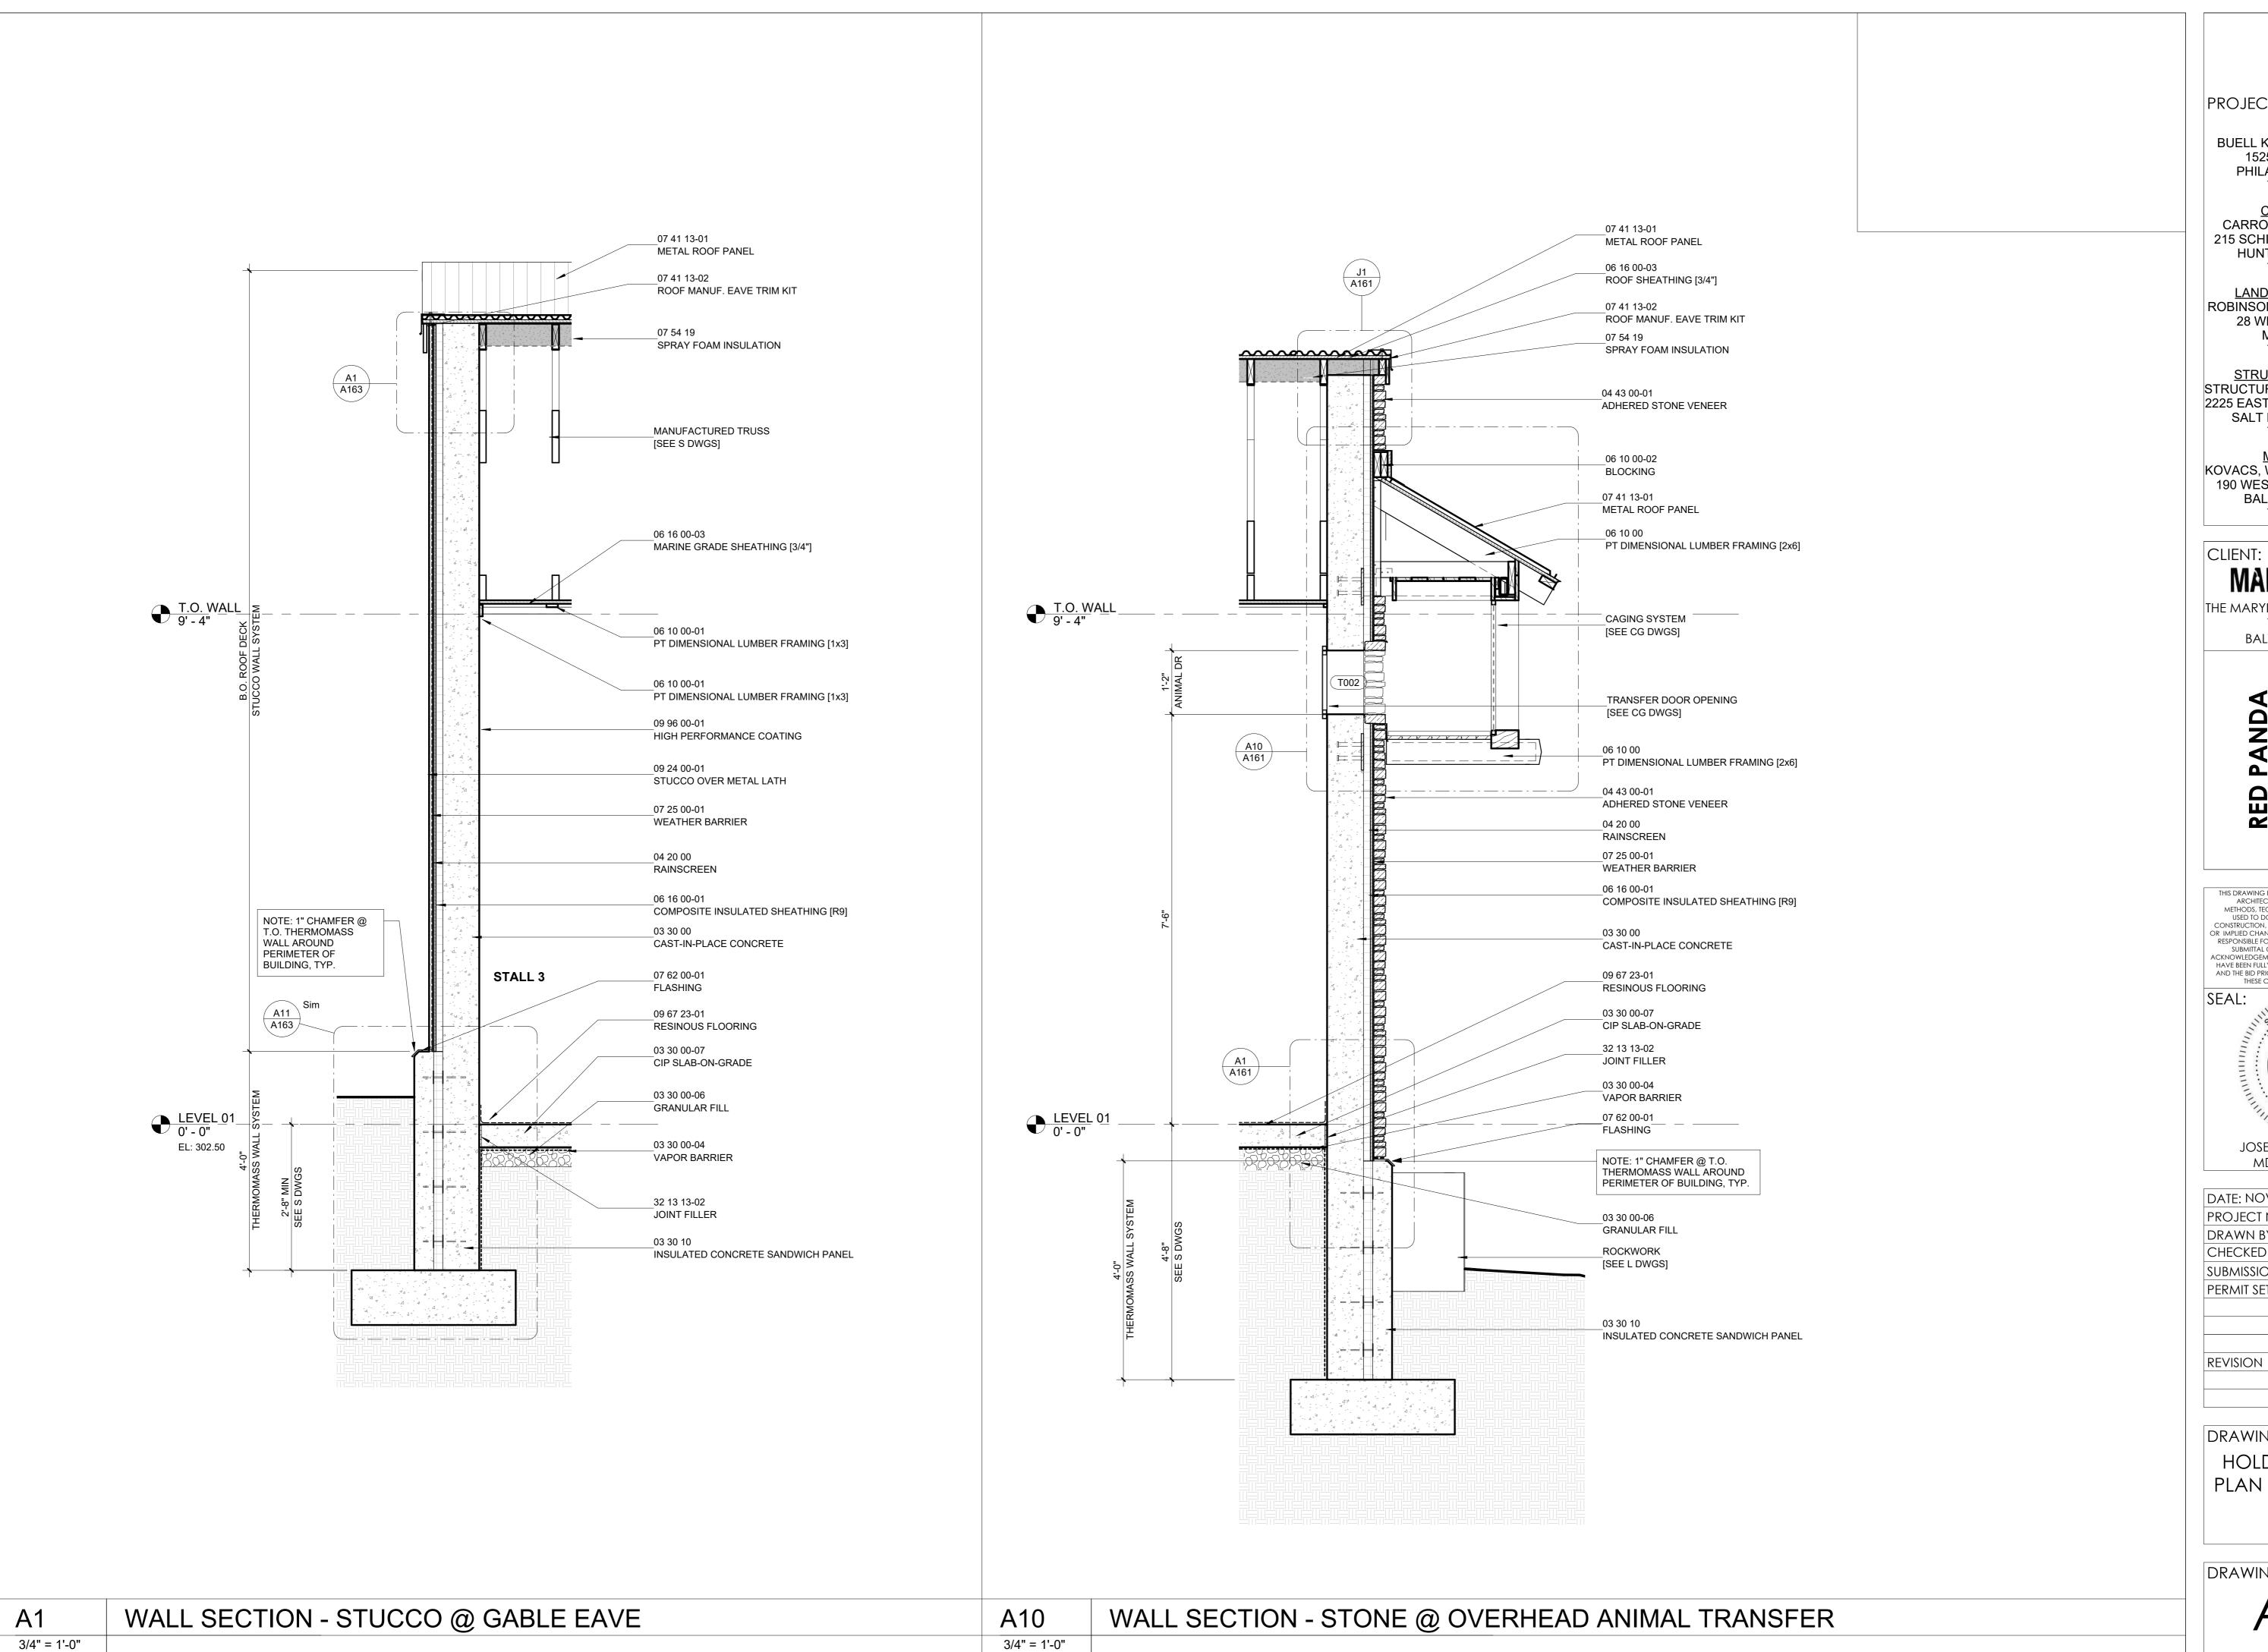
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DRAWING TITLE: HOLDING BUILDING SECTIONS





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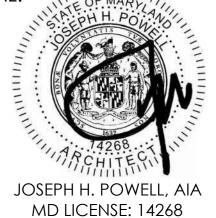
LANDSCAPE ARCHITECT: ROBINSON ANDERSON SUMMERS 28 WEST STATE STREET MEDIA, PA 19063 T: 302.888.1544

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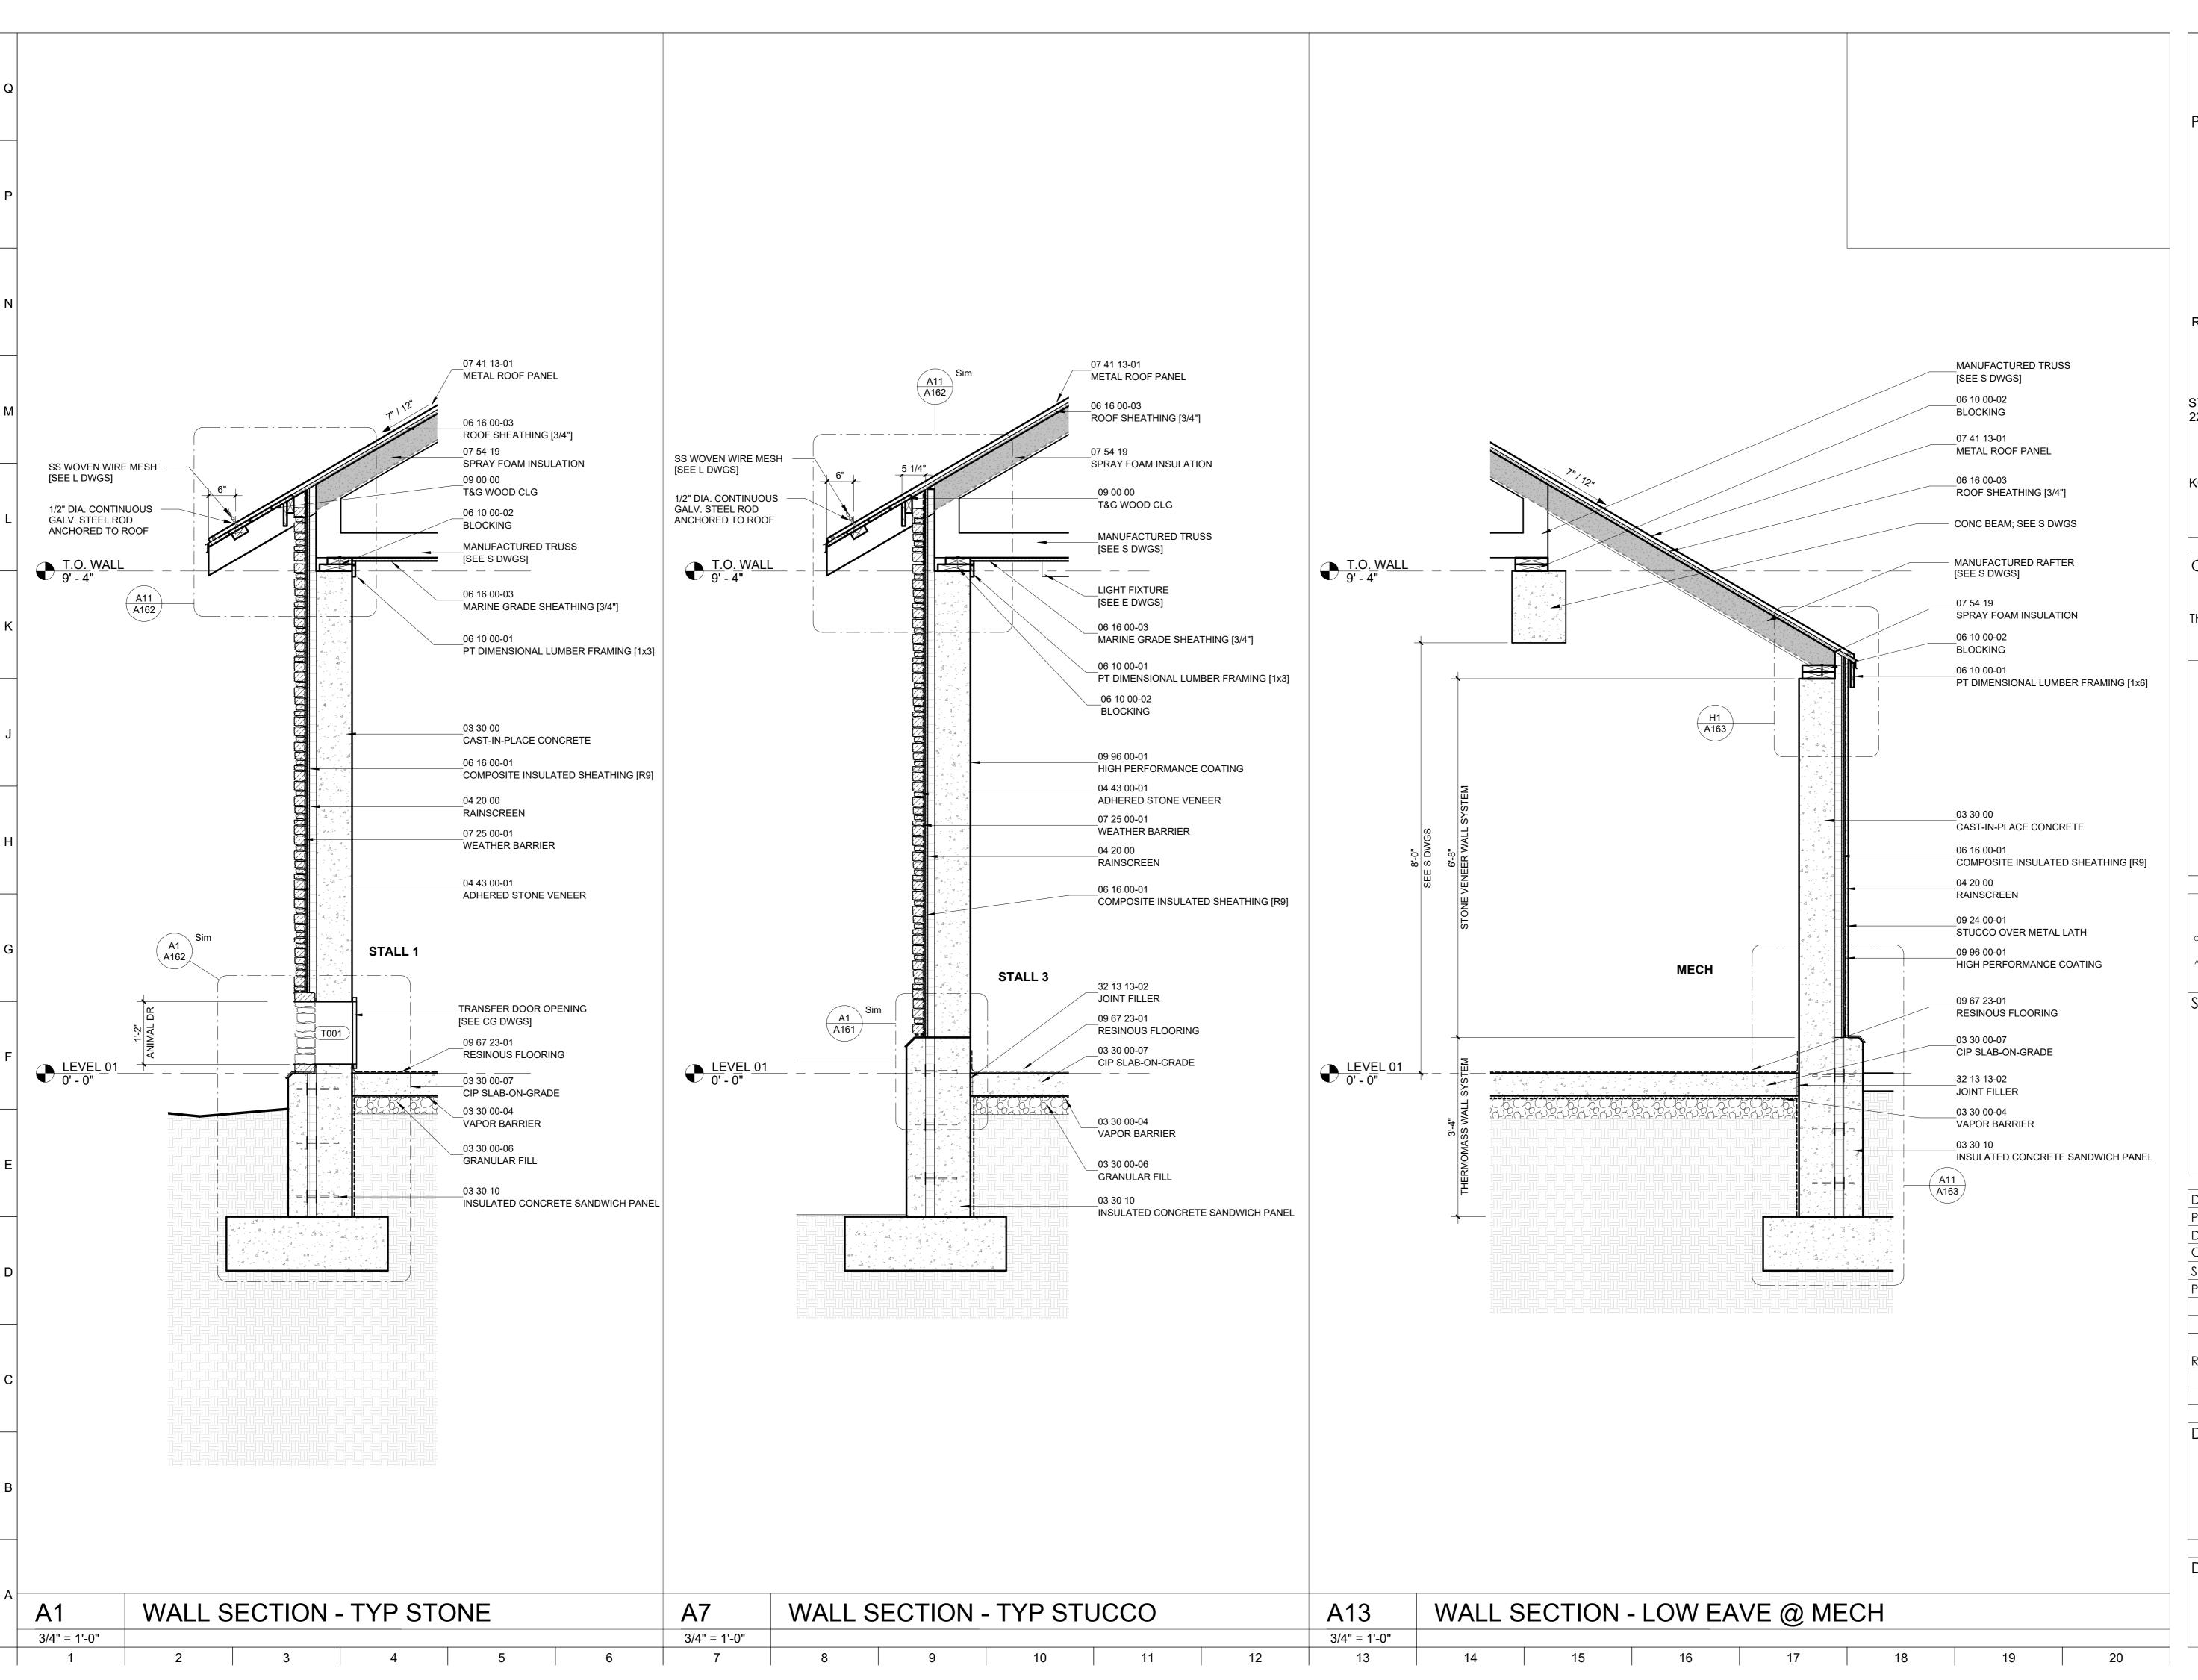
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DRAWING TITLE: HOLDING BUILDING PLAN WALL SECTIONS





ARCHITECT:
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1525 LOCUST STREET
PHILADELPHIA, PA 19102
T: 215.557.6509

CIVIL ENGINEER:
CARROLL ENGINEERING, INC
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HUNT VALLEY, MD 21031
T: 410.785.7423

LANDSCAPE ARCHITECT:
ROBINSON ANDERSON SUMMERS
28 WEST STATE STREET
MEDIA, PA 19063
T: 302.888.1544

STRUCTURAL ENGINEER: STRUCTURAL DESIGN STUDIO, INC 2225 EAST MURRAY HOLLADAY RD SALT LAKE CITY, UT 84117 T: 801.274.3950

MEP ENGINEER:
KOVACS, WHITNEY & ASSOCIATES
190 WEST OSTEND ST, STE 300
BALTIMORE, MD 21230
T: 410.244.7191

CLIENT:
MARYI AND 700

THE MARYLAND ZOO IN BALTIMORE

1 SAFARI PLACE

BALTIMORE, MD 21217

RED PANDA

THE MARYLAND ZOO
IN BALTIMORE
1 SAFARI PLACE
BALTIMORE, MD 21217


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DRAWING TITLE:
HOLDING BUILDING
PLAN WALL SECTIONS

DRAWING NO:





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LANDSCAPE ARCHITECT: ROBINSON ANDERSON SUMMERS 28 WEST STATE STREET MEDIA, PA 19063 T: 302.888.1544
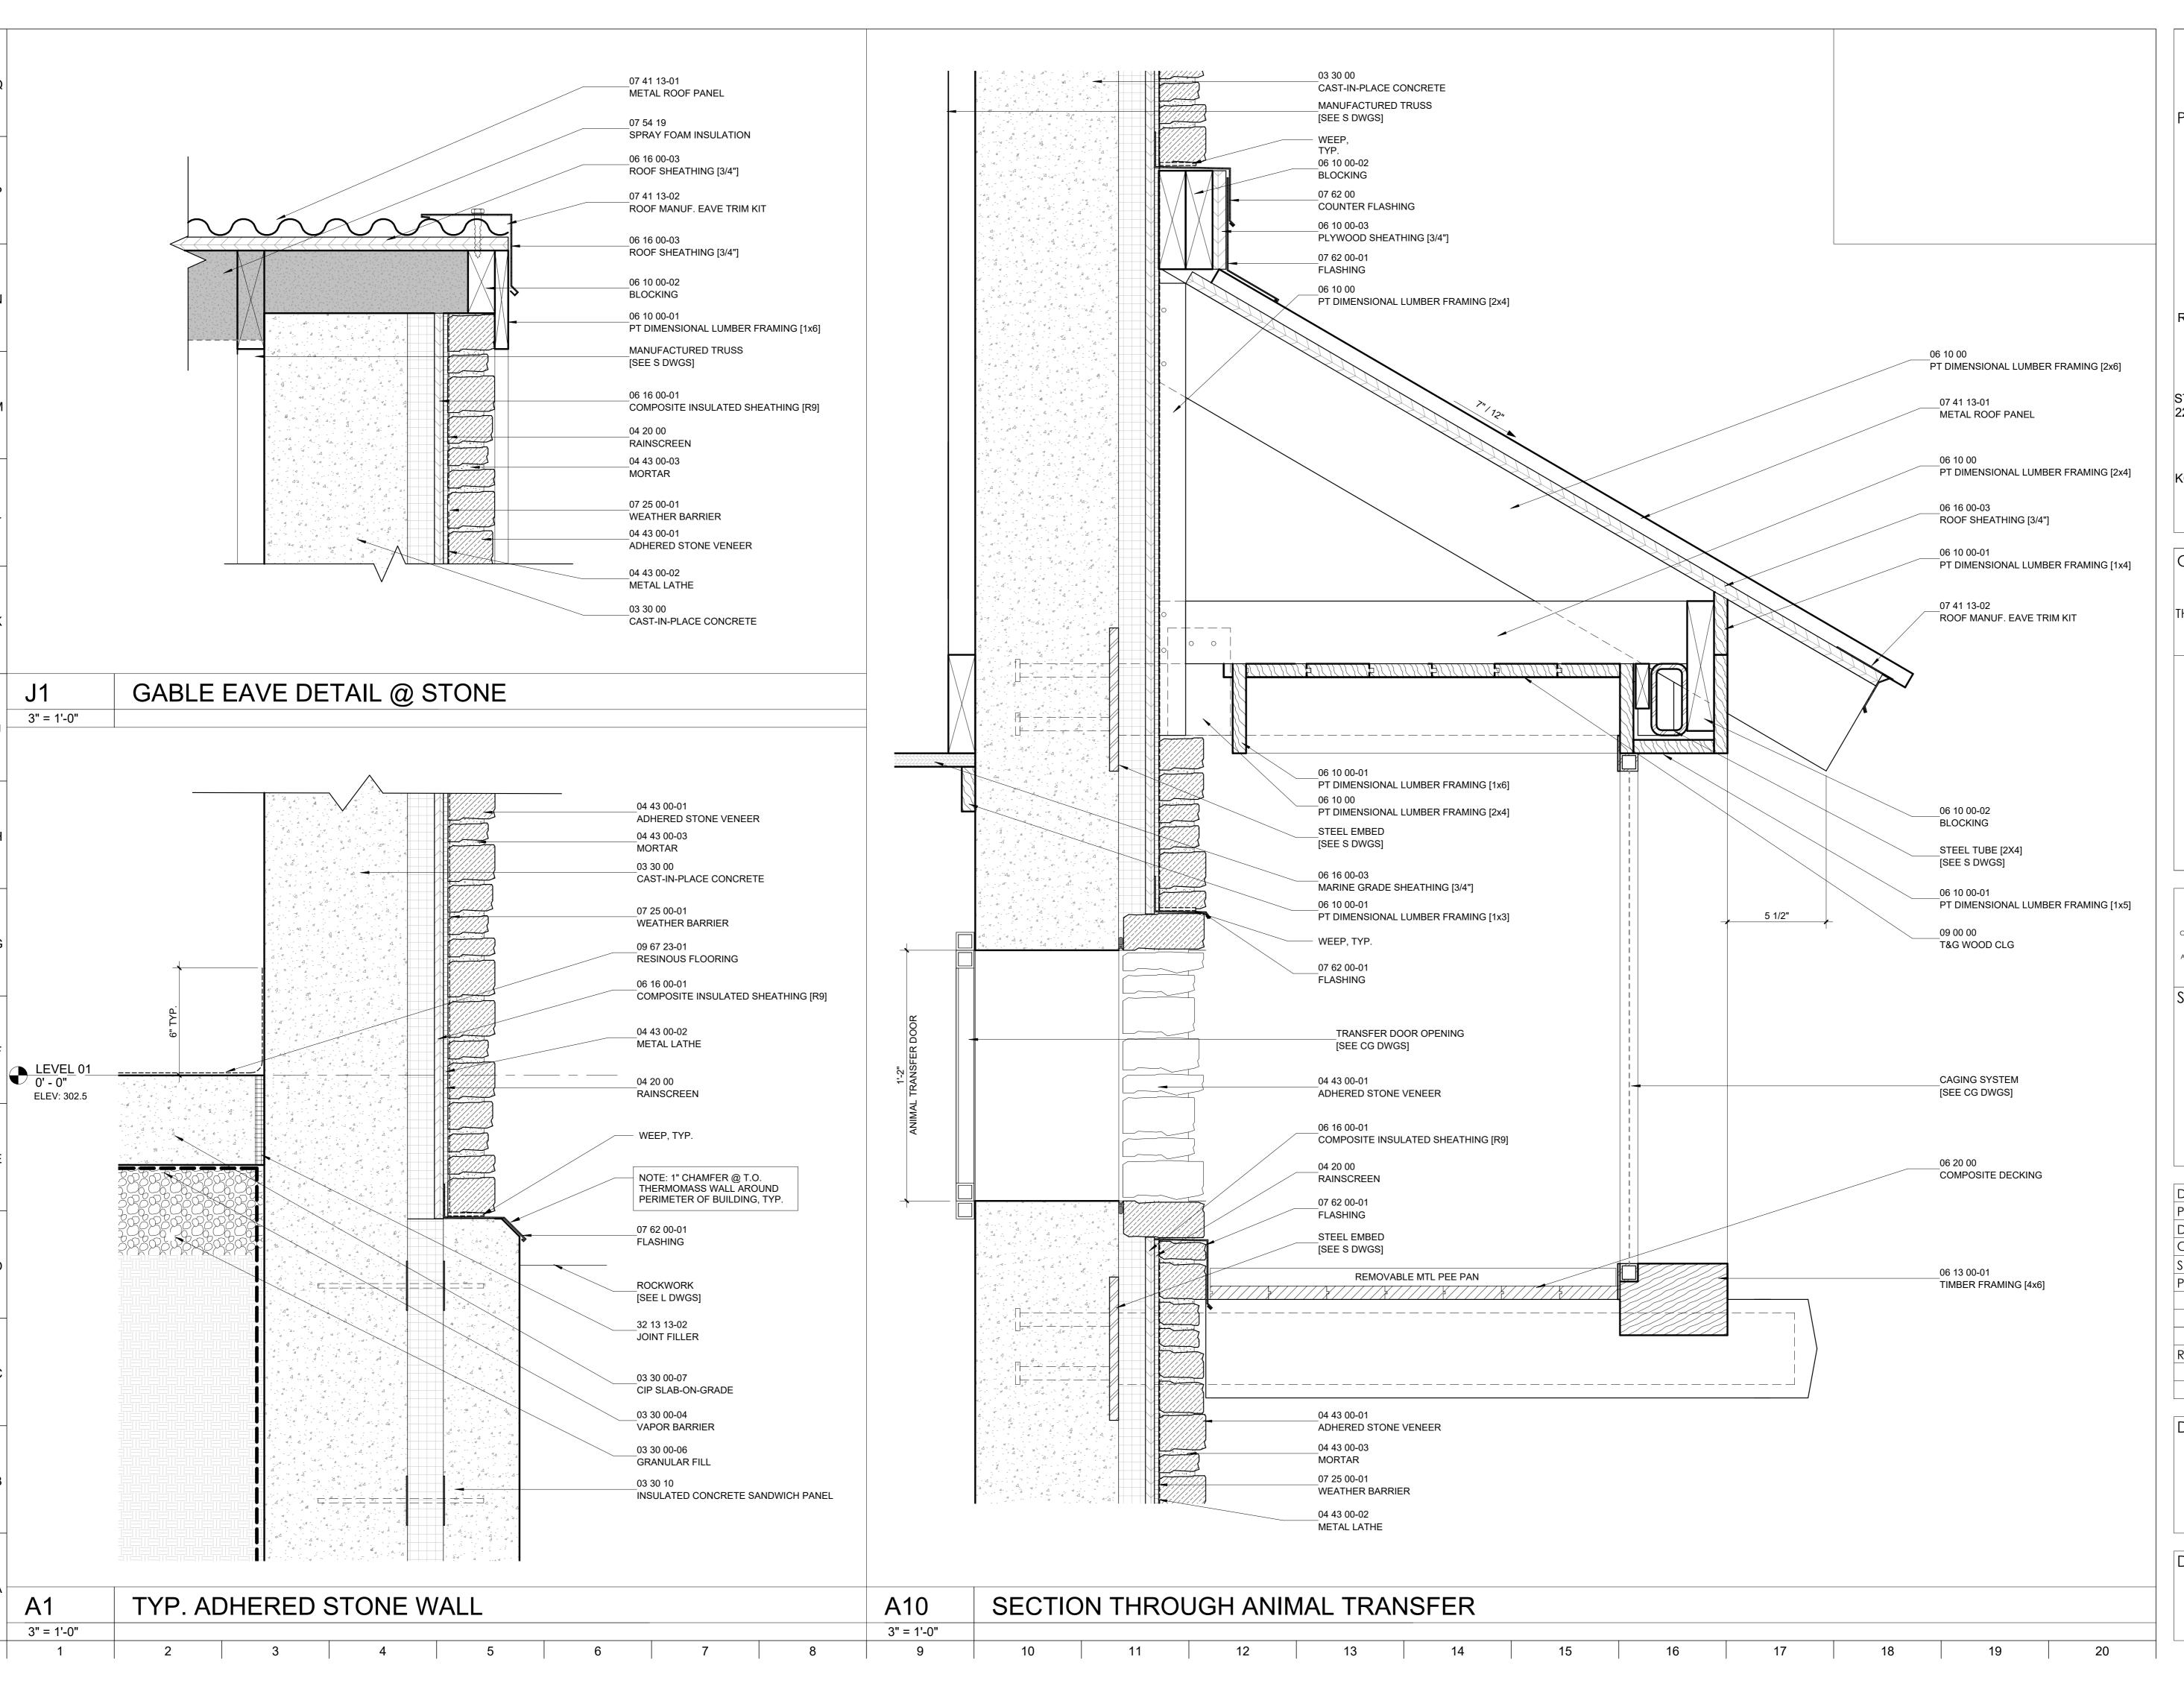
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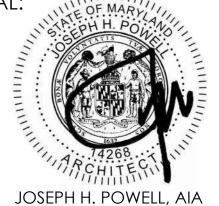
MEP ENGINEER: KOVACS, WHITNEY & ASSOCIATES 190 WEST OSTEND ST, STE 300 BALTIMORE, MD 21230 T: 410.244.7191

CLIENT:

THE MARYLAND ZOO IN BALTIMORE 1 SAFARI PLACE BALTIMORE, MD 21217

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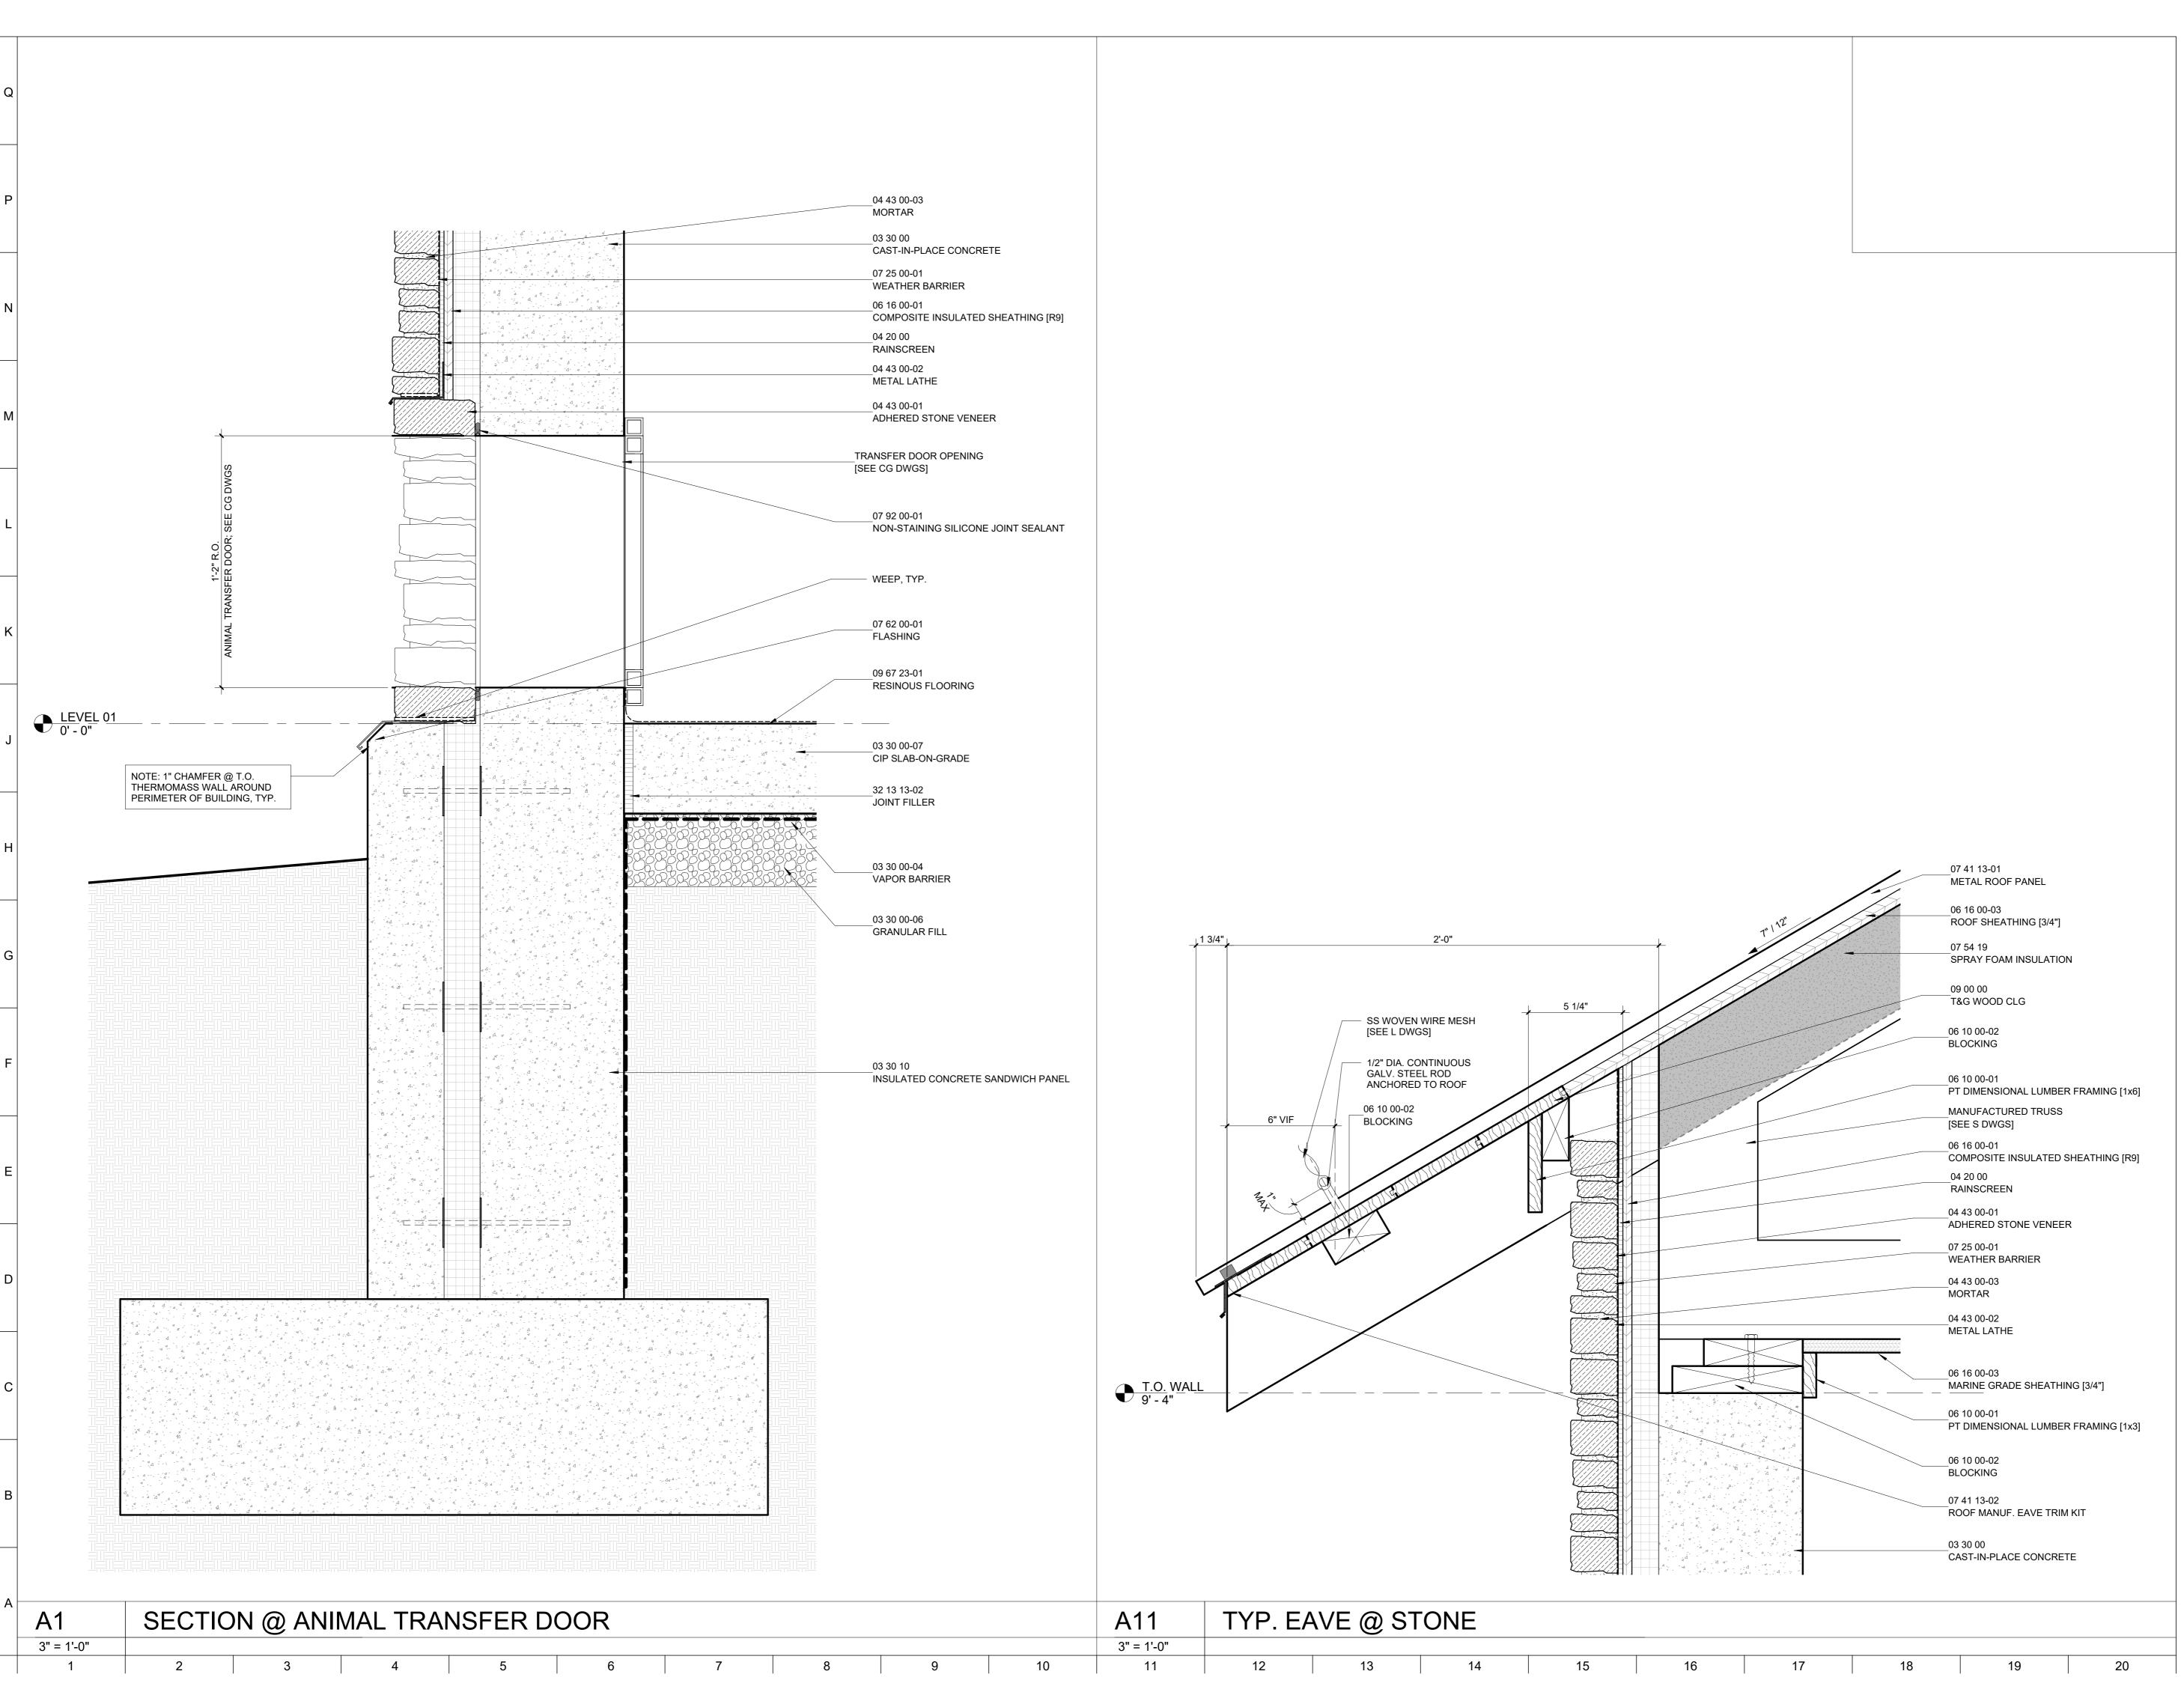
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MD LICENSE: 14268

DATE: NOVEMBER 22, 2024 PROJECT NO: 2023-10.04 CC DRAWN BY CHECKED BY DATE SUBMISSION 11/22/2024 PERMIT SET REVISION DATE

DRAWING TITLE: CONSTRUCTION DETAILS





ARCHITECT:
BUELL KRATZER POWELL, P.C.
1525 LOCUST STREET
PHILADELPHIA, PA 19102
T: 215.557.6509

CIVIL ENGINEER:
CARROLL ENGINEERING, INC
215 SCHILLING CIRCLE, STE 102
HUNT VALLEY, MD 21031
T: 410.785.7423

LANDSCAPE ARCHITECT:
ROBINSON ANDERSON SUMMERS
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MEDIA, PA 19063
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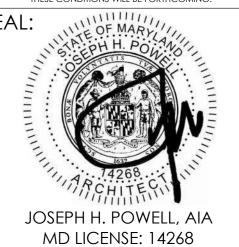
CLIENT: MARYLAND 700

THE MARYLAND ZOO IN BALTIMORE
1 SAFARI PLACE
BALTIMORE, MD 21217

KED PANDA

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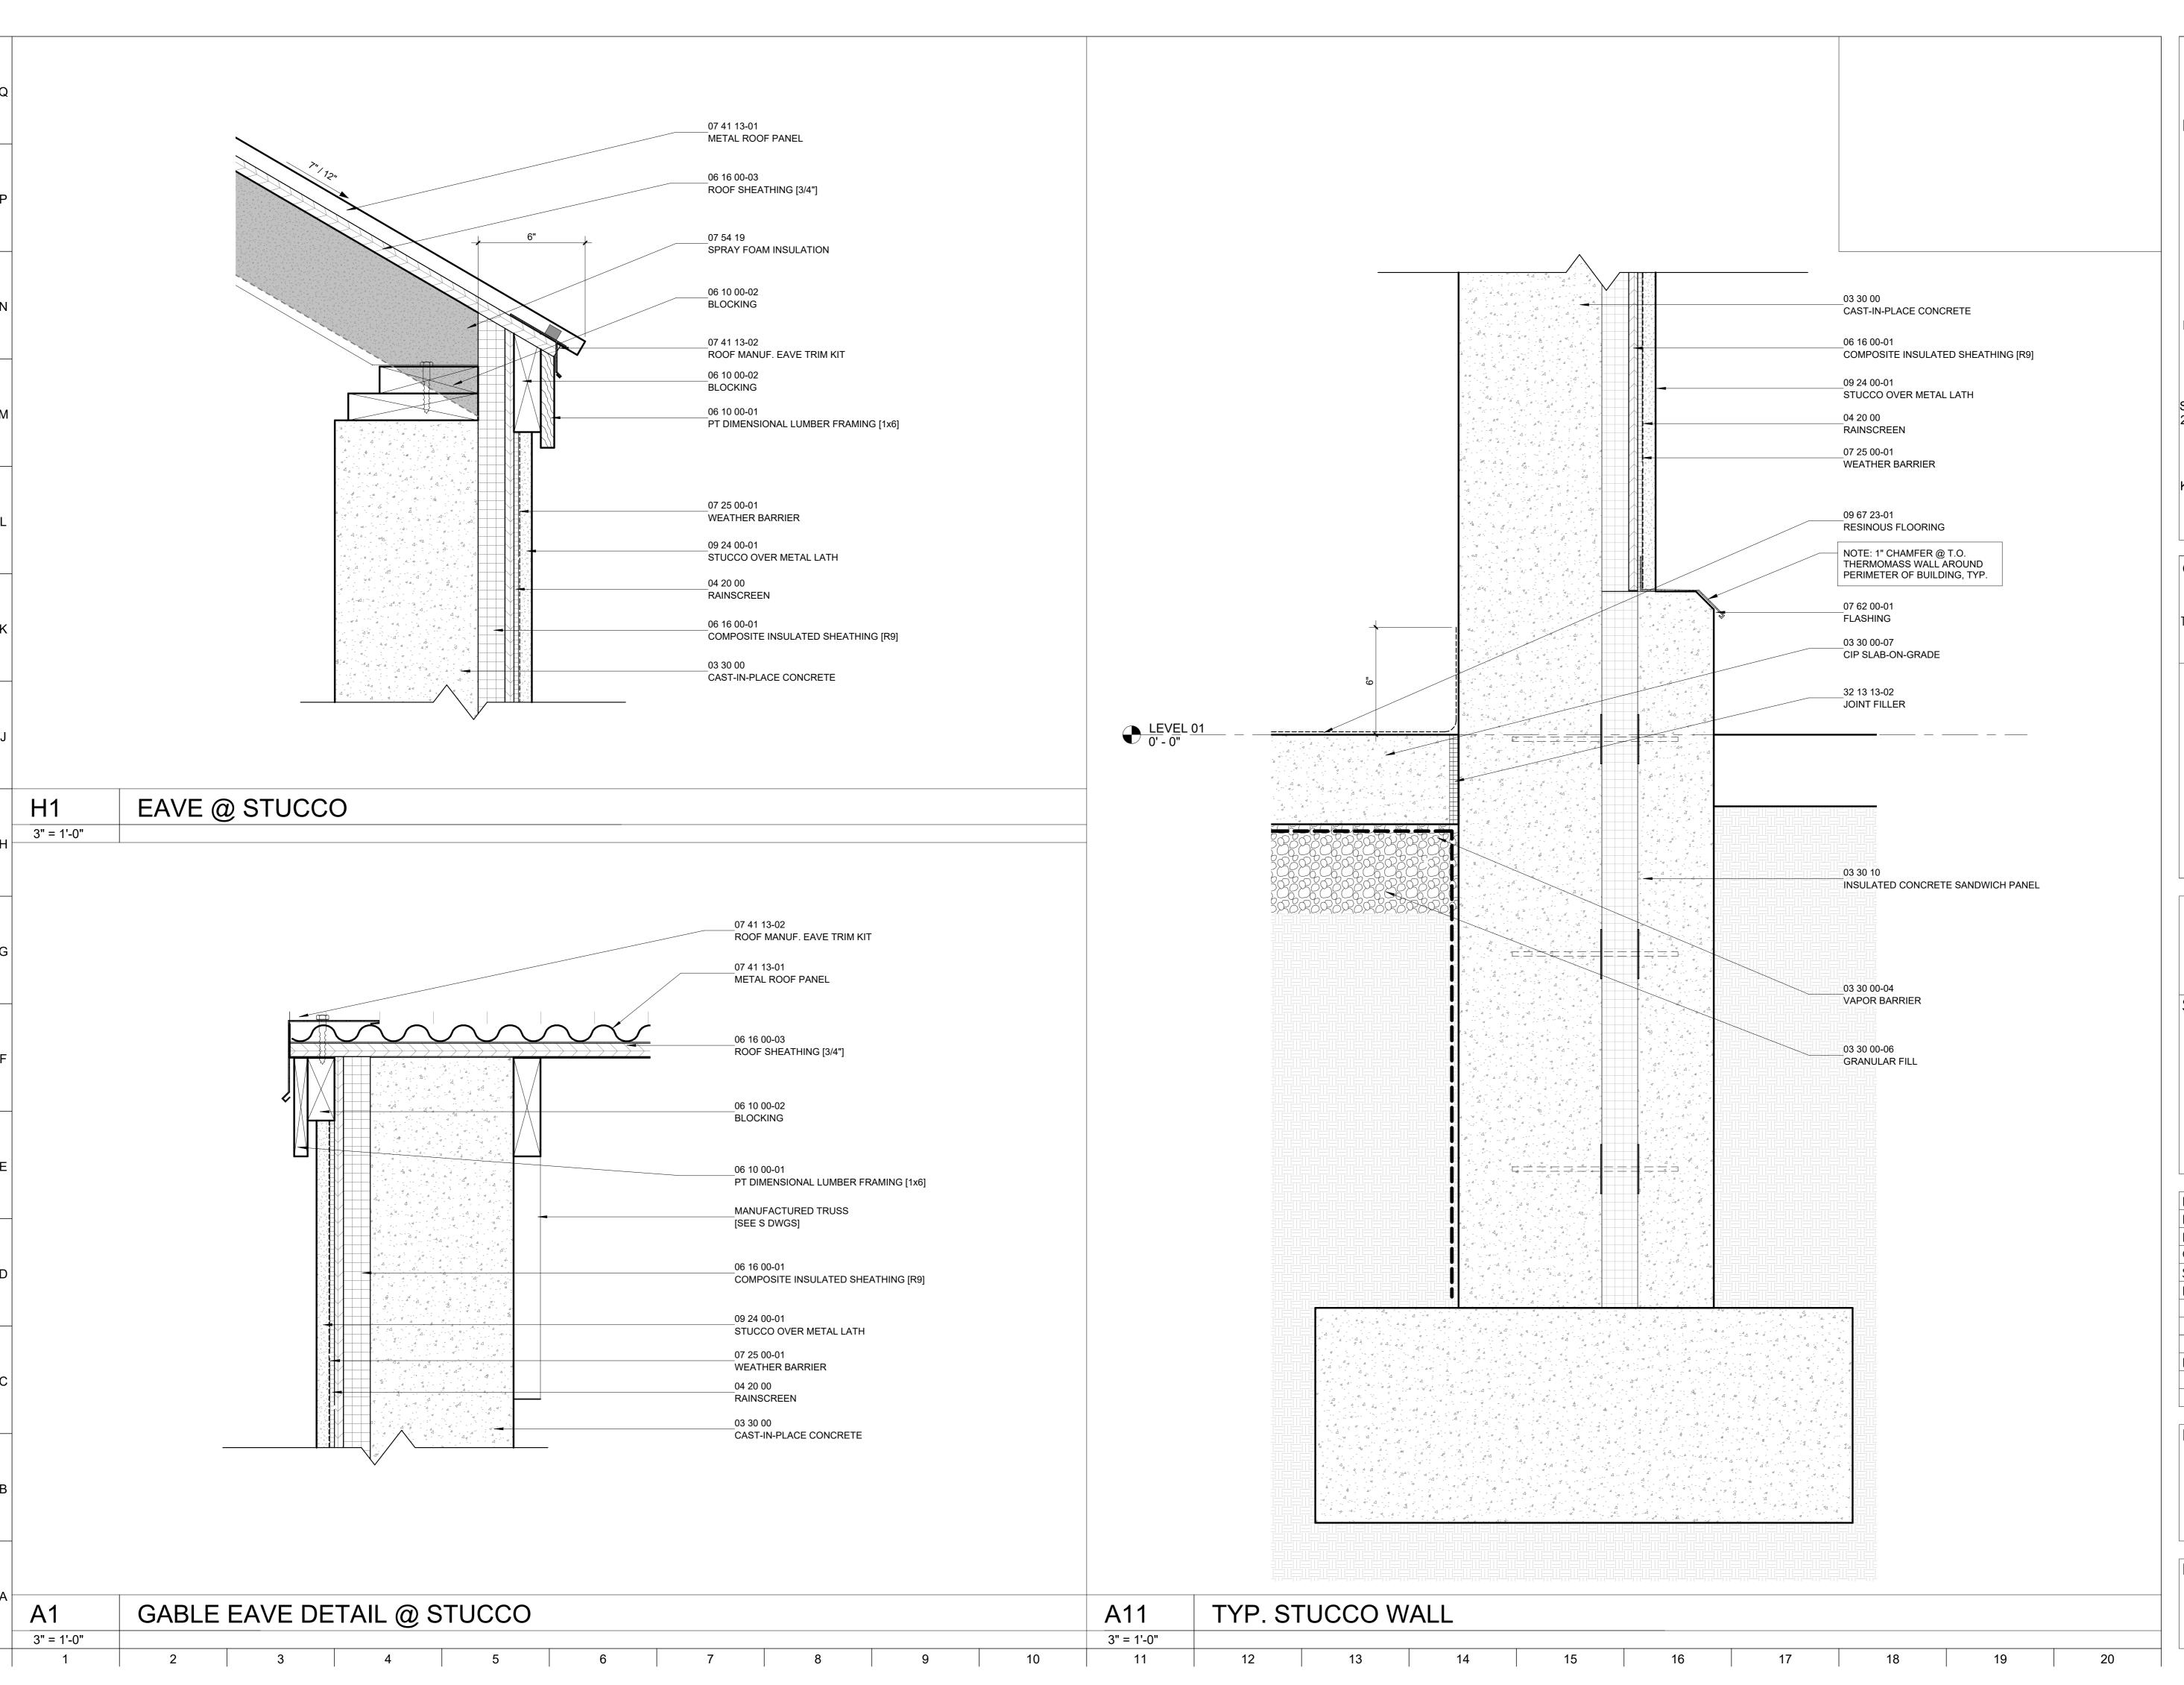


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190 WEST OSTEND ST, STE 300
BALTIMORE, MD 21230
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CLIENT:
MARYLAND ZOO

THE MARYLAND ZOO IN BALTIMORE
1 SAFARI PLACE
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RED PANDA

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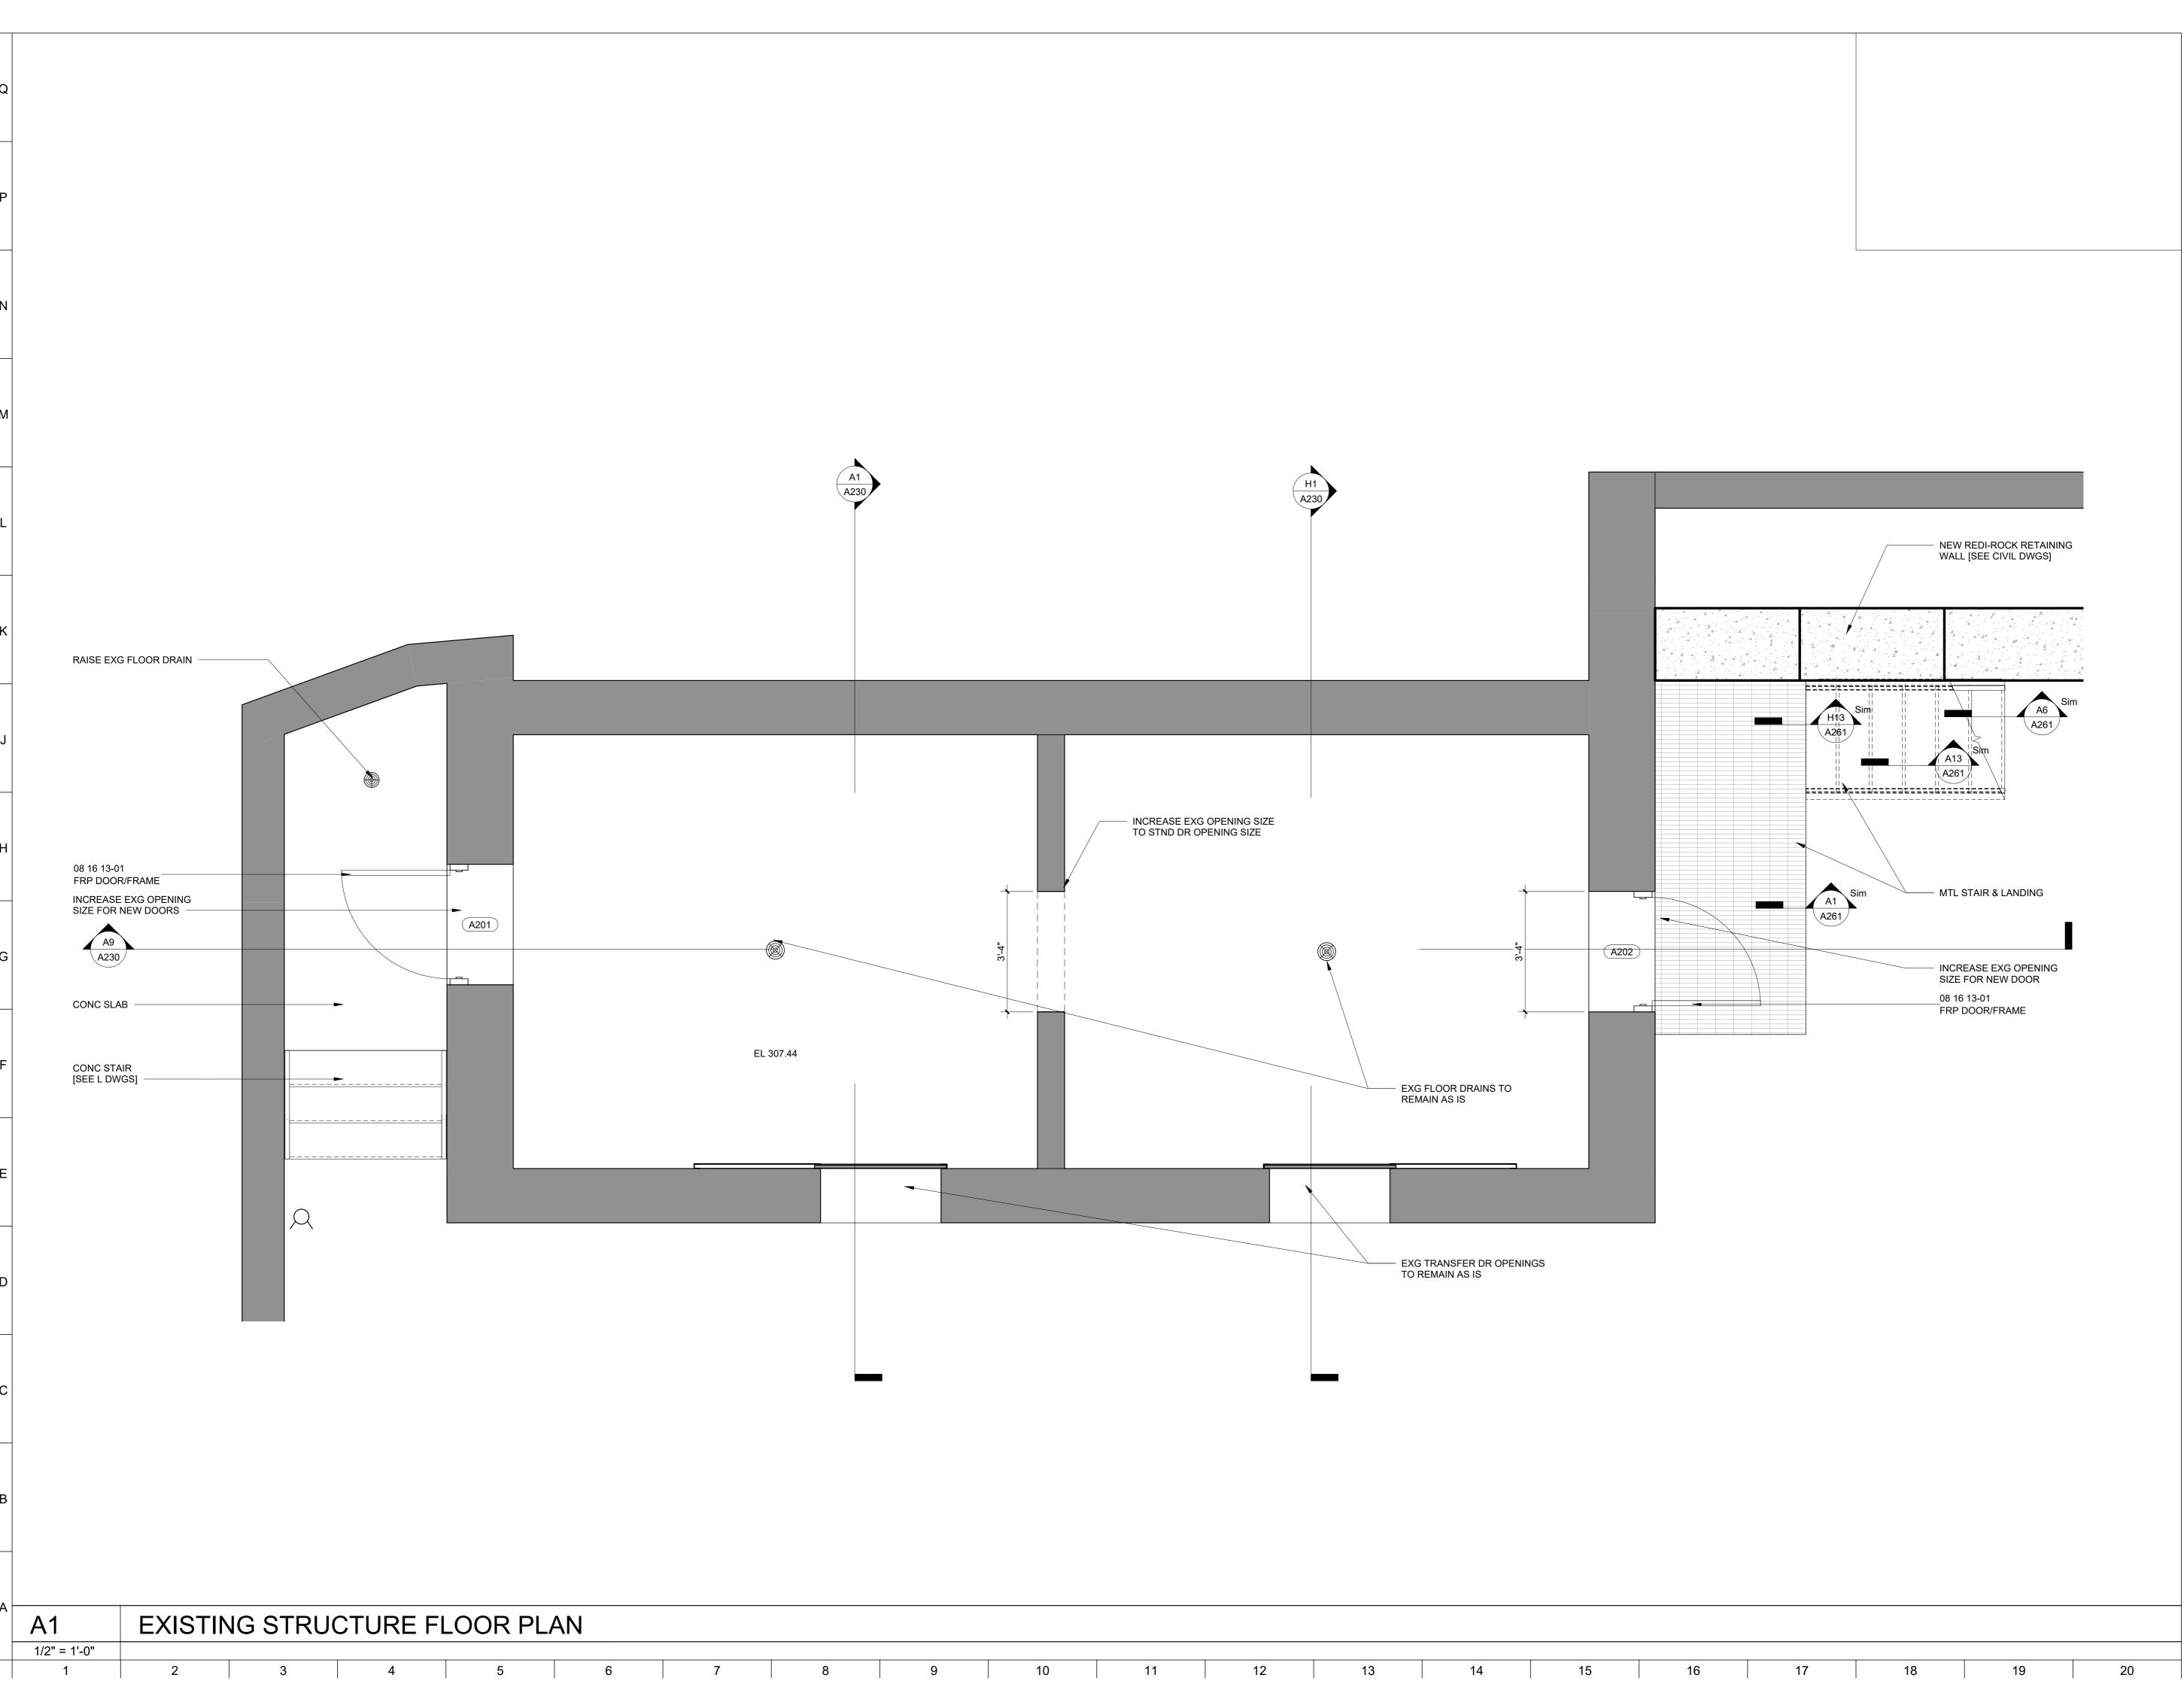
JOSEPH H. POWELL, AIA MD LICENSE: 14268

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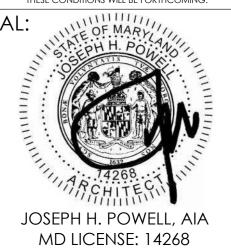
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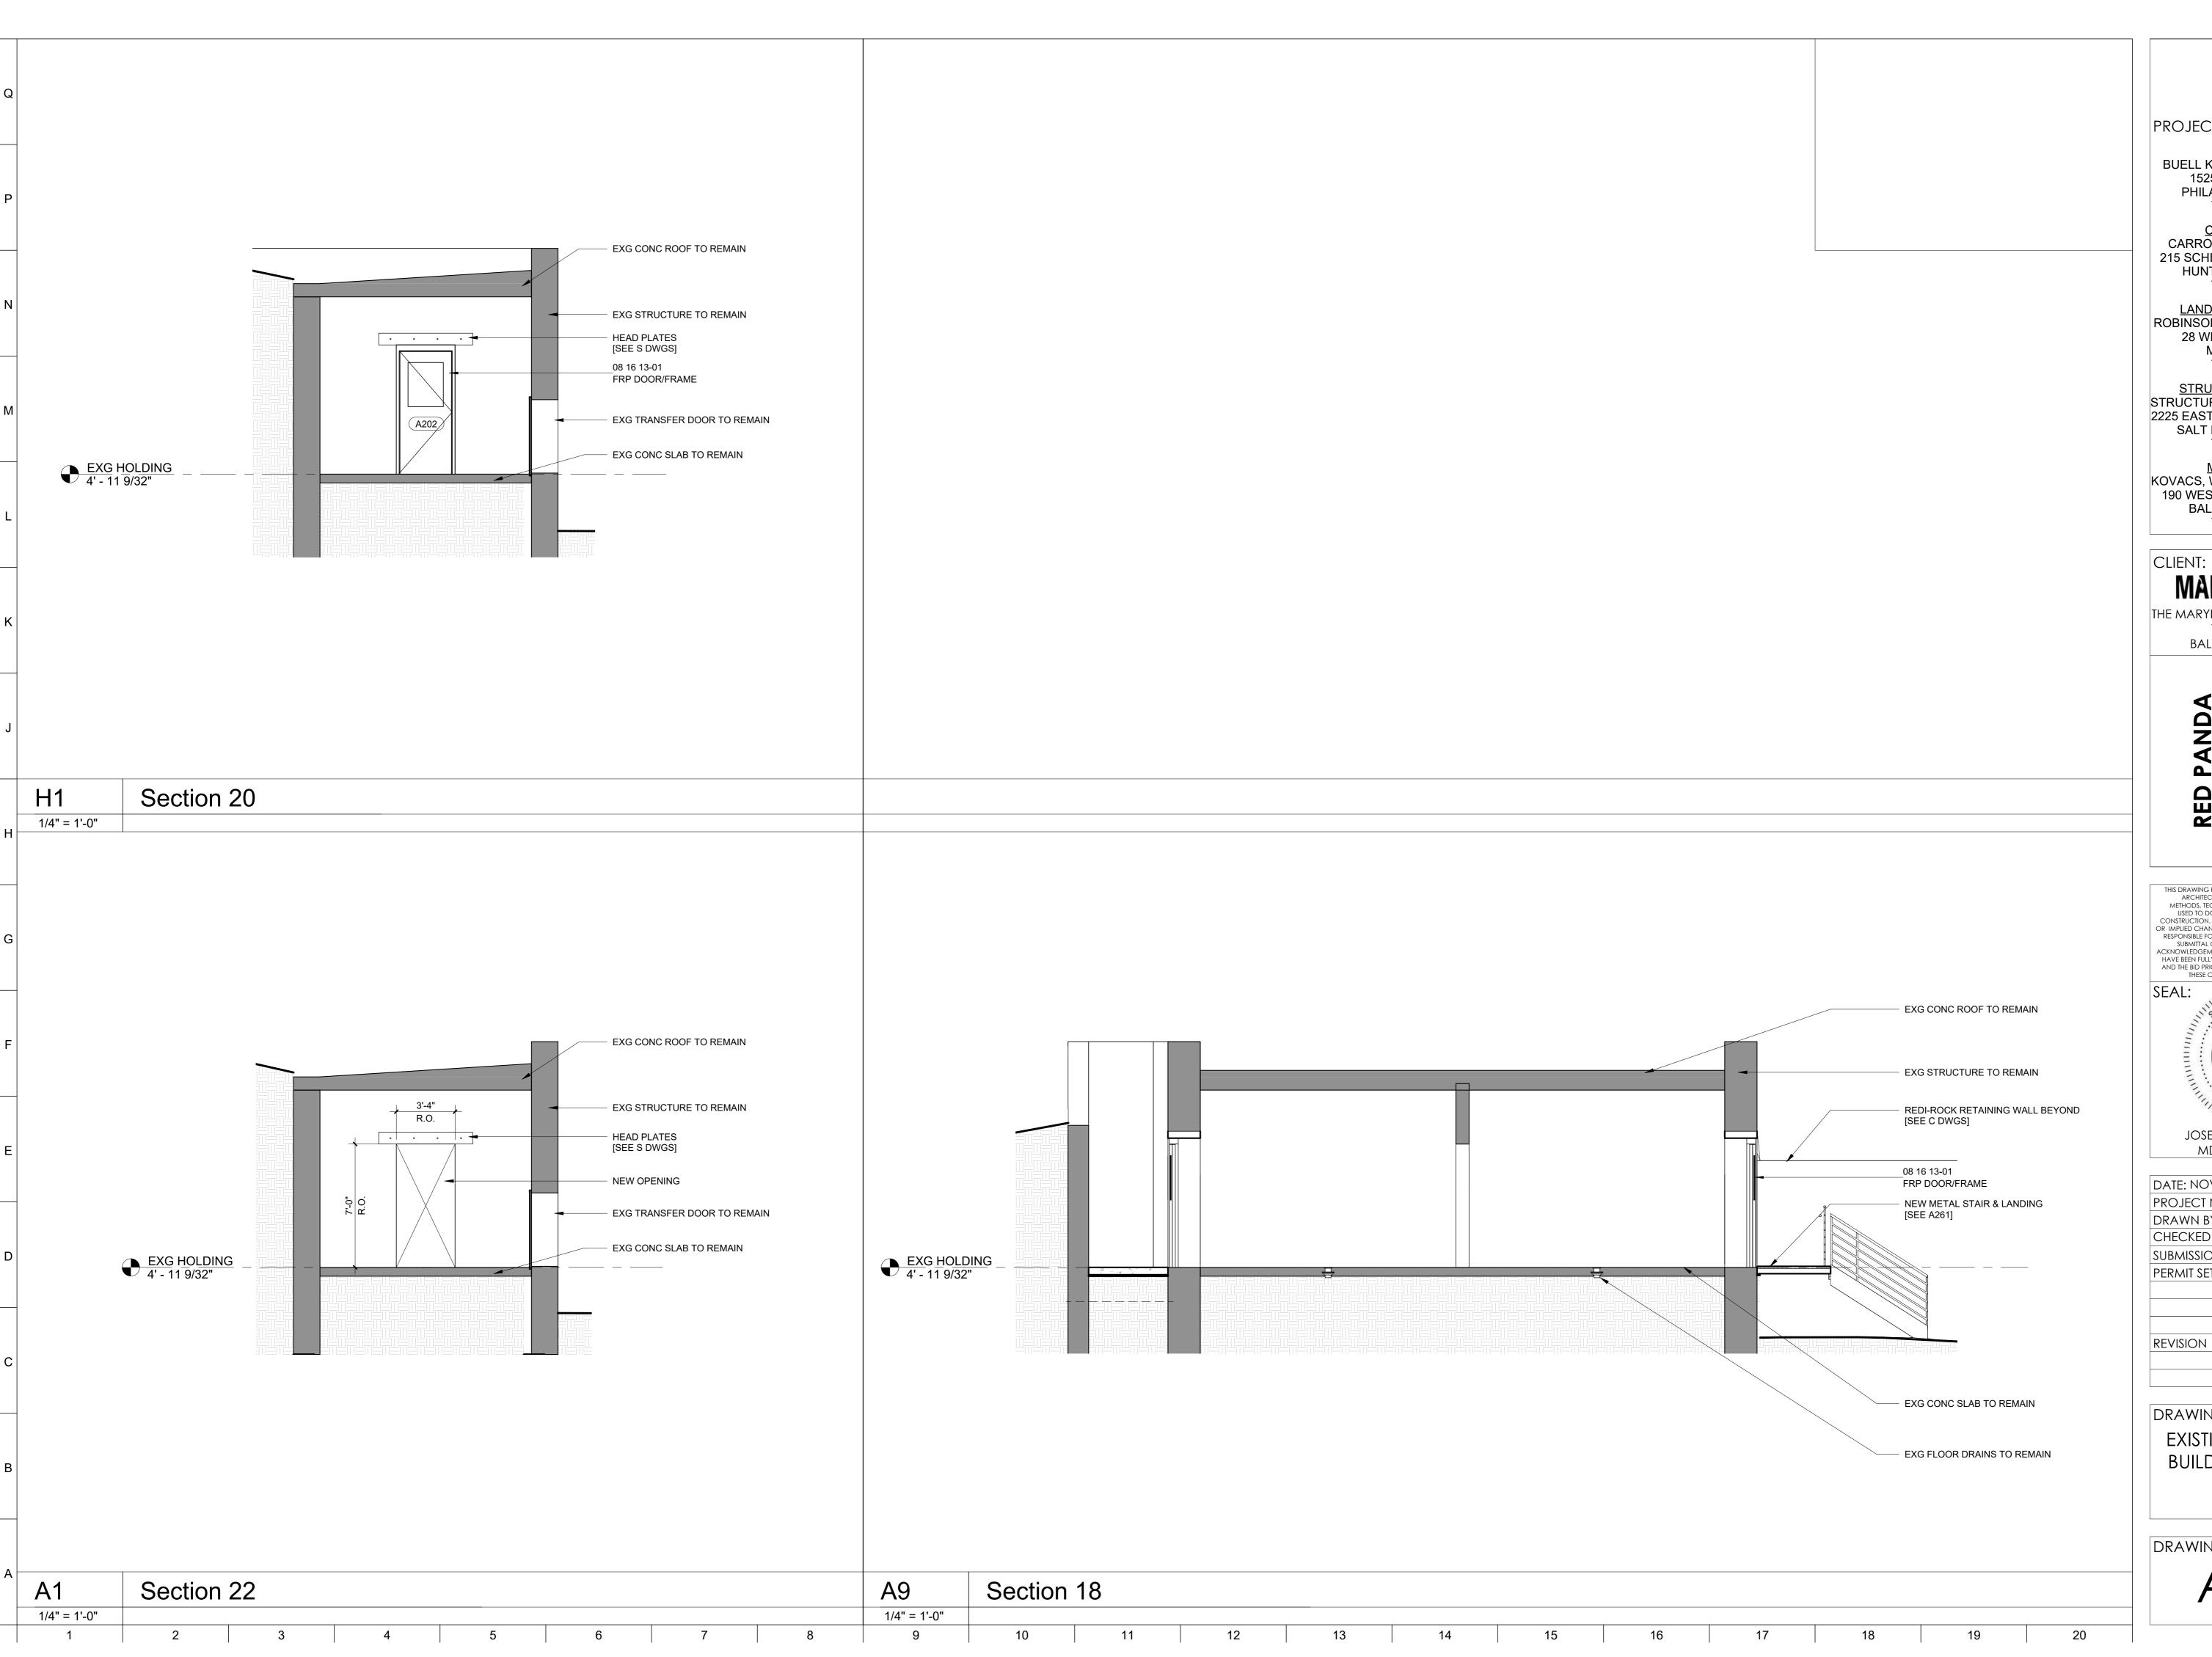
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DRAWING TITLE:
EXISTING STRUCTURE
FLOOR PLAN

DRAWING NO:





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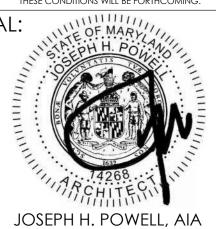
LANDSCAPE ARCHITECT: ROBINSON ANDERSON SUMMERS 28 WEST STATE STREET MEDIA, PA 19063 T: 302.888.1544

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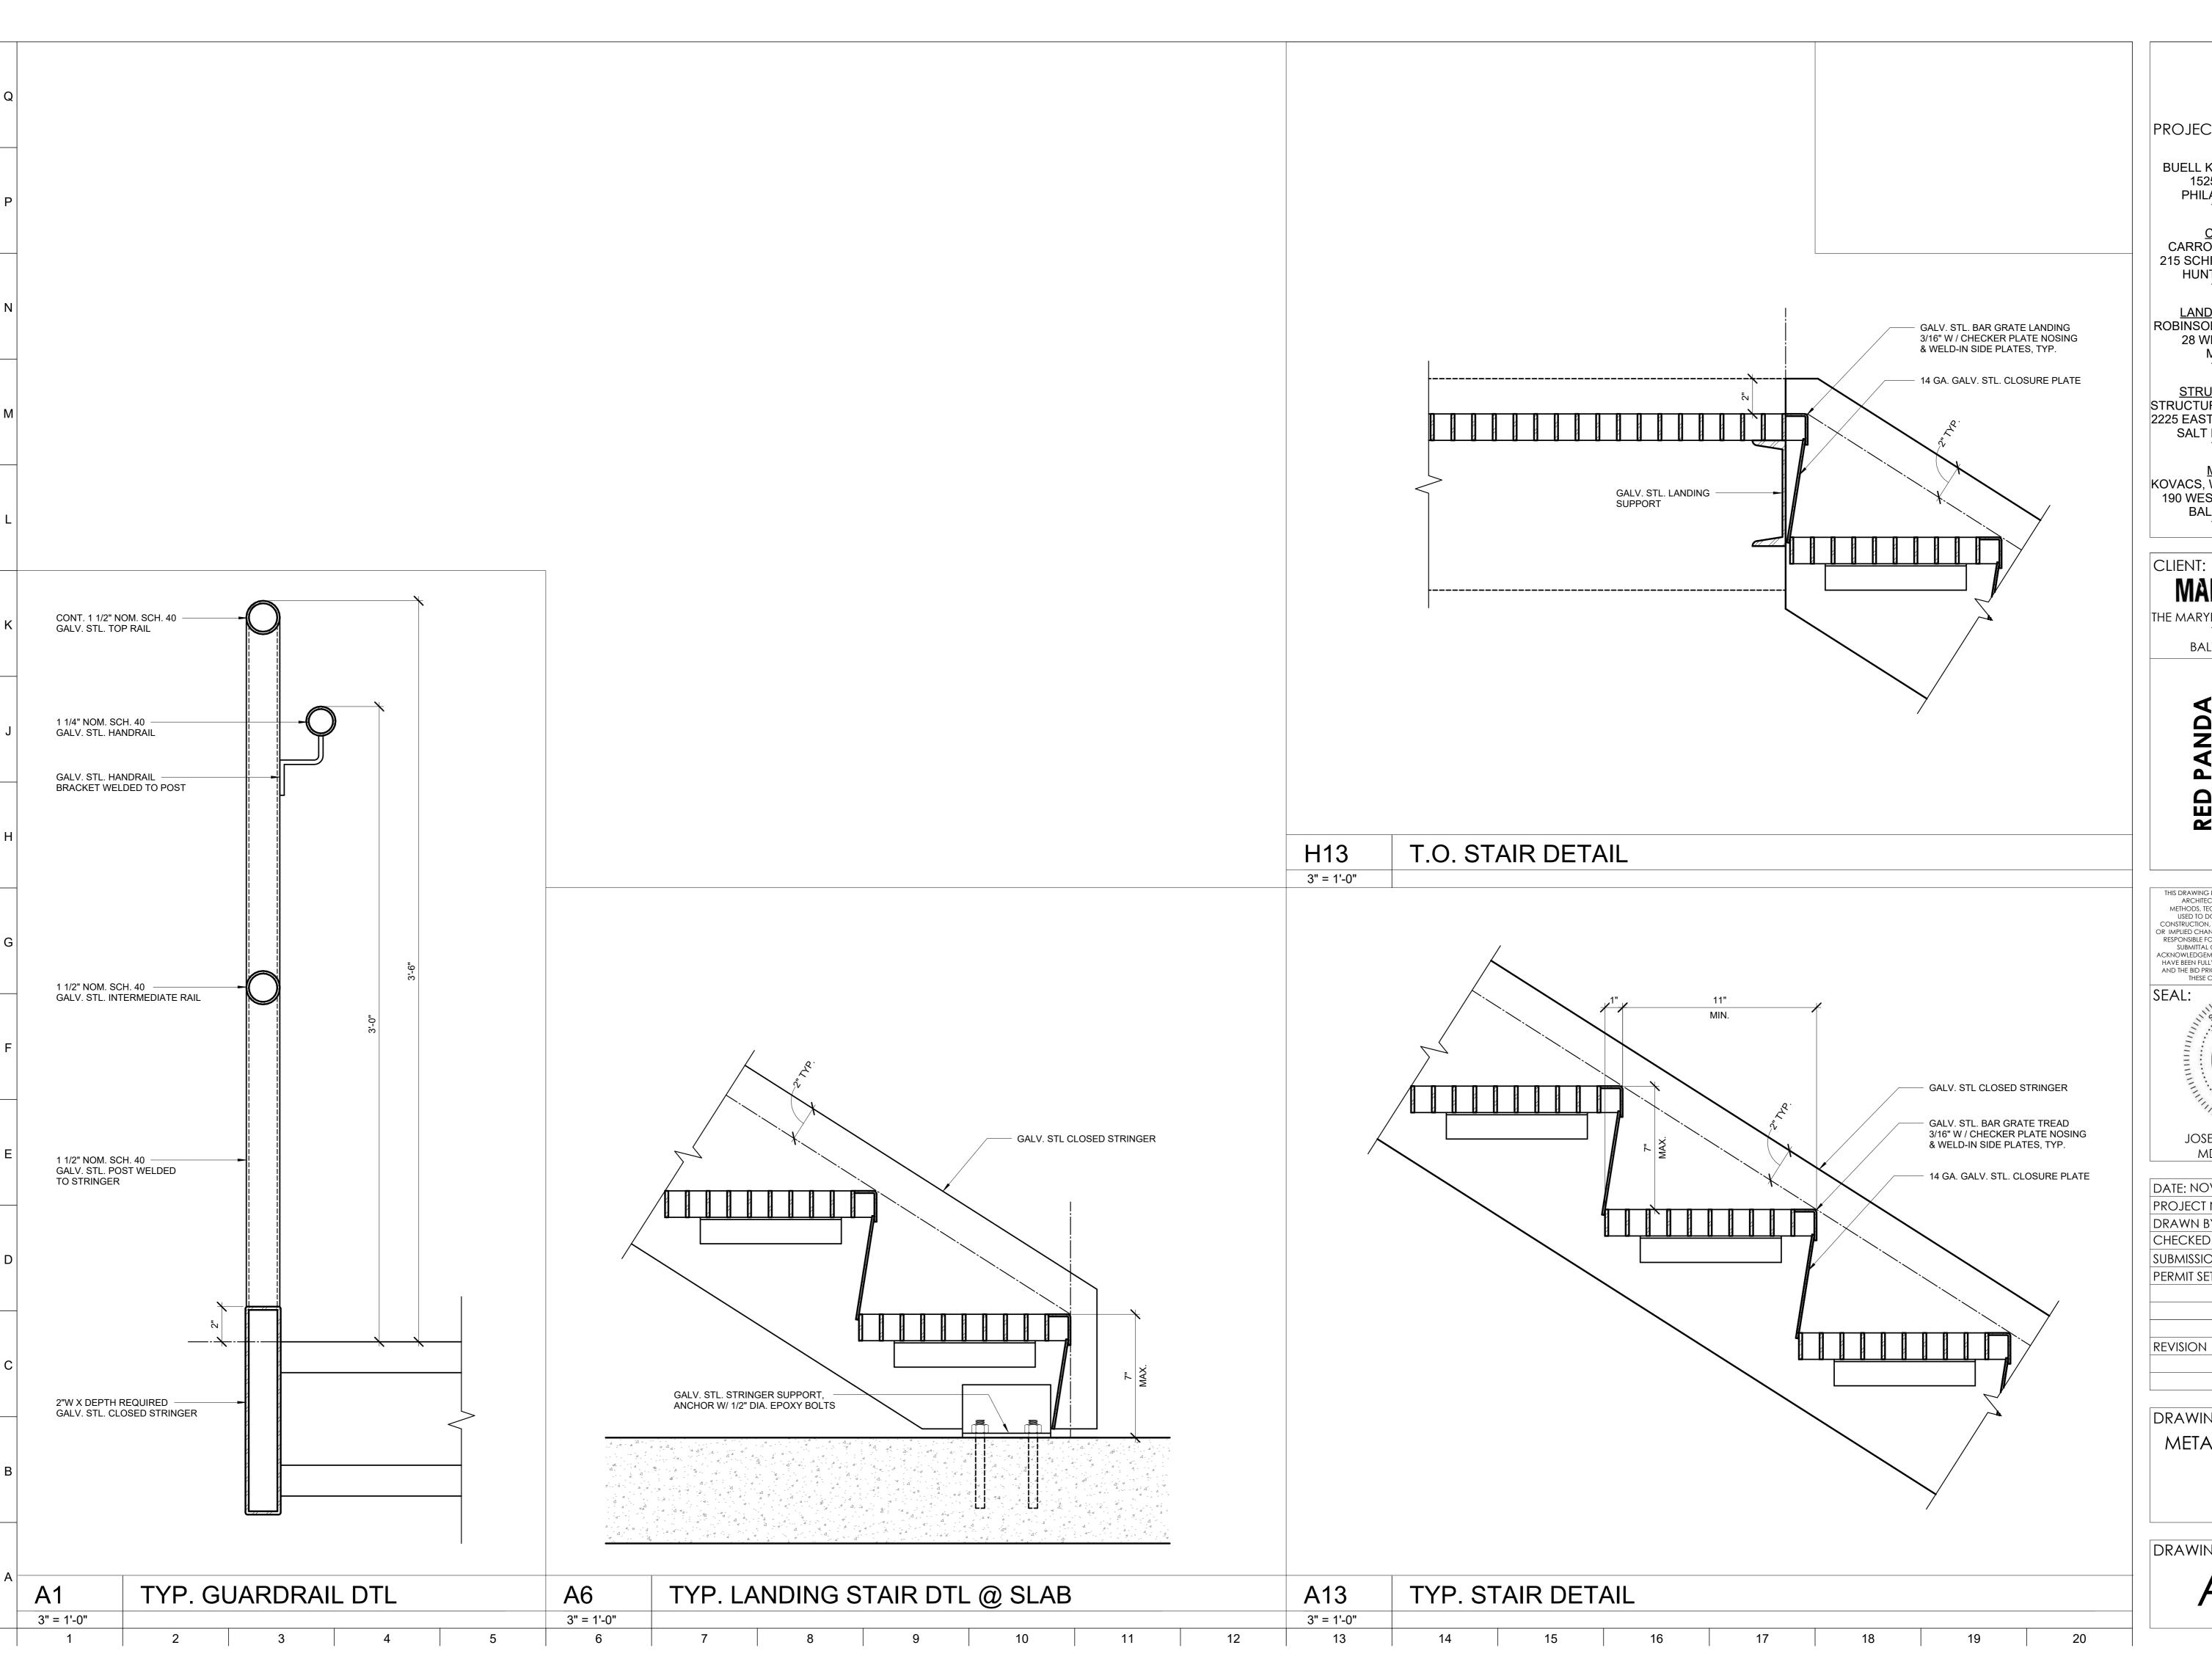


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DRAWING TITLE:

EXISTING STRUCTURE **BUILDING SECTIONS**





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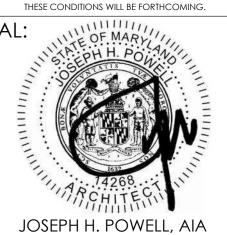
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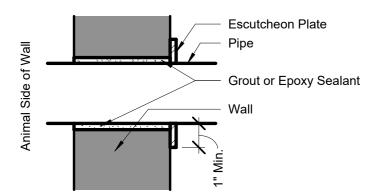
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REVISION	DATE		

DRAWING TITLE: METAL STAIR DETAILS


DRAWING NO:

Animal Management Requirements of Construction


- 1. **General** All items on this sheet shall be installed and/or performed as part of the base scope of work whether or not specifically detailed or noted elsewhere.
- A. Animal Management Requirements of Construction apply to all:
- a. Holding Buildings & Facilities.
- b. Indoor & outdoor transfer areas/chutes.B. Animal habitats, both on and off exhibit.
- 2. **Sharp Edges** No construction materials are permitted to have sharp edges within an animal zone or animal reach zone.
- A. All exposed flashing must have crimped edge.
- B. All exposed hardware, fasteners, & similar items must be clipped, ground smooth, or otherwise treated to eliminate all sharp edges.
- 3. **Vermin Control** Minimize potential for vermin infestation by:
- A. Seal all gaps occurring in adjoining construction with epoxy sealant as specified or approved by Architect.
- B. Cap all tubes at all exposed ends.C. Seal all tube steel vent holes with epoxy sealant as specified or approved by Architect.
- 4. **Caging Penetrations** All required penetrations in caging systems shall be coordinated and installed so that they are kept to an absolute minimum. Wherever possible, group penetrating elements together and "gang install" to create a single penetration. Any gaps remaining between penetrating elements must be less than1".
- 5. **Wall Penetrations** All pipe, duct, or other penetration between animal space and any other space shall be sealed completely (no voids, cracks, or holes allowed) with non-shrink cementitious grout or epoxy sealant as specified or approved by the Architect. Provide stainless steel escutcheon plate on all pipe penetrations for plumbing lines, drain leaders, sprinkler lines, or other pipes. Escutcheon plate shall be installed on non-animal side of wall only.




- 6. **Fixed Fasteners** Bolts & fasteners shall have a maximum projection of 1/8". All exposed fasteners within an animal space or Animal Reach Zone shall be fixed in place per the following instructions:
- A. Weld spot weld all exposed fasteners (bolt heads, nuts, etc.). Minimize welding to galvanized surfaces. All sharp edges of welds shall be made smooth.
 B. Damage Threads Exposed threads of bolts or anchors shall be damaged to prevent the nut from backing off. Sharp edges shall be made smooth. Contractor to verify that nuts cannot be removed.

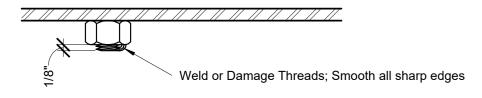

7. **Maximum Gaps** - All gaps larger than 1/2" between installed items, or between installed items and existing construction shall have a continuous section of cover plate welded to the construction to reduce the gap to the maximum allowable dimension or less. Cover plate shall be of the same material and finish as the surrounding caging and have a thickness of 1/16". This section does not apply to any gap that is specifically dimensioned or noted in the drawings.

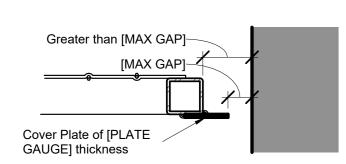

8. **Building Service Cover Plates** - Cover plate shall be installed wherever exposed conduit, cables, chains, plumbing lines, electric lines, hydraulic lines, or other building service elements occur within an Animal Reach Zone. Cover plate shall be of the same material and finish as the surrounding caging and have a thickness of 1/16". Cover plate shall be fixed to new or existing construction with SS anchor or weld, UNO. Where solid plates are not acceptable (ex. lights & sprinkler heads) provide typical caging (mesh panels) protection. If access is required to covered element, provide hinged assembly and clearance for full extent of swing.

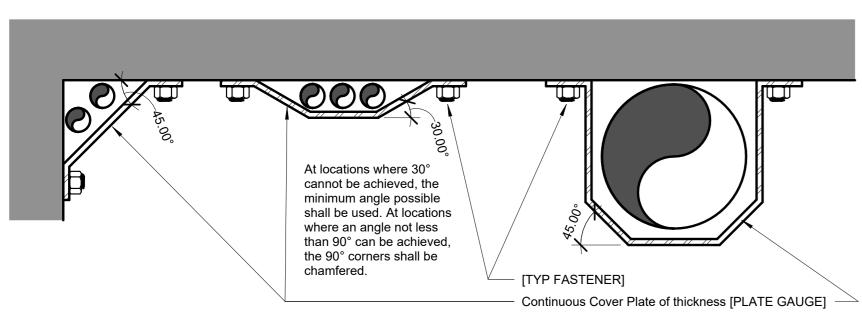

These details to be used both vertically & horizontally

- 9. **Transfer Door Operators** Transfer door operators and other animal management devices mounted to the face of a caging system may require additional framing beyond what is shown in the drawings to accommodate mounting and/or locking. Framing shall be of the same material and finish as the surrounding caging.
- 10. **Locking Systems** Coordinate all locking systems with specified padlocks. If no padlocks are specified, confirm padlock information with Owner and coordinate with locking systems. Verify that proper clearances are provided for specified or Owner provided padlocks.
- 11. Repeat steps above for each room.

BASIS OF DESIGN:
CORNERS LIMITED
CUSTOM CAGING SPECIALISTS
841 GIBSON STREET, KALAMAZOO, MI 49001
P: 800.456.6780

*NOTE: THE CAGING SYSTEM DOCUMENTED IN THIS SET IS TO BE MANUFACTURED
AND INSTALLED AS RECOMMENDED PER THE BASIS OF DESIGN. THIS INCLUDES
CAGING PANELS, MOUNTING HARDWARE, KEEPER AND ANIMAL DOORS, DOOR
COMPONENTS, AND CAGING ACCESSORIES.

KEEPER DOOR SCHEDULE			
DOOR NO.	R.O. WIDTH	R.O. HEIGHT	COMMENTS

K001	2' - 8"	7' - 0"	
K002	2' - 8"	7' - 0"	
K003	2' - 8"	7' - 0"	
K004	3' - 4"	7' - 4"	SECONDARY CONTAINMENT SEE J11/CG123
K005	1' - 10"	2' - 6"	ANIMAL TRANSFER CHUTE ACCESS
K010	6' - 8"	7' - 0"	SERVICE GATE
K011	6' - 4"	7' - 2"	SERVICE GATE
K012	6' - 4"	7' - 2"	SERVICE GATE


HORIZONTAL SLIDER 1' - 0" 1' - 2"

	TRANSFER DOOR SCHEDULE									
DOOR NO.	DOOR TYPE	R.O. WIDTH	R.O. HEIGHT	SILL HEIGHT (ABOVE FFE 302.5)	DOOR PANEL MATERIAL	MOUNTING CONDITION	OPERATOR TYPE	COMMENTS		
EX-T21		3' - 4"	4' - 2"	5' - 0"		CONC		LOCATED IN STORAGE BLDG. EXG TO REMAIN. NOT IN USE.		
EX-T22		3' - 4"	4' - 2"	5' - 0"		CONC		LOCATED IN STORAGE BLDG. EXG TO REMAIN. NOT IN USE.		
T001	HORIZONTAL SLIDER	1' - 4"	1' - 2"	0' - 2"	ALUM/ HDPE	CONC	PULL BAR			
T002	HORIZONTAL SLIDER	1' - 4"	1' - 2"	7' - 6"	ALUM/ HDPE	CONC	PULL HANDLE			
T003	HORIZONTAL SLIDER	1' - 4"	1' - 2"	7' - 6"	ALUM/ HDPE	CONC	PULL HANDLE			
T004	GUILLOTINE	1' - 4"	1' - 2"	6' - 2"	ALUM/ HDPE	CONC	PULL HANDLE			
T005	GUILLOTINE	1' - 4"	1' - 2"	6' - 2"	ALUM/ HDPE	CONC	PULL HANDLE			
T006	HORIZONTAL SLIDER	1' - 0"	1' - 2"	7' - 2"	HDPE	ROCKWORK	PULL BAR	TRANSFER TO HABITAT B. DOOR TO BE LOCKABLE IN OPEN & CLOSED POSITION. SEE J1/CG121		
T007	HORIZONTAL SLIDER	1' - 0"	1' - 2"	0' - 7 1/2"	MESH	CAGING PANEL	PULL BAR			
T008	HORIZONTAL SLIDER	1' - 0"	1' - 2"	6' - 2"	MESH	CAGING PANEL	PULL BAR			


CAGING PANEL PULL BAR


MESH

4' - 9"

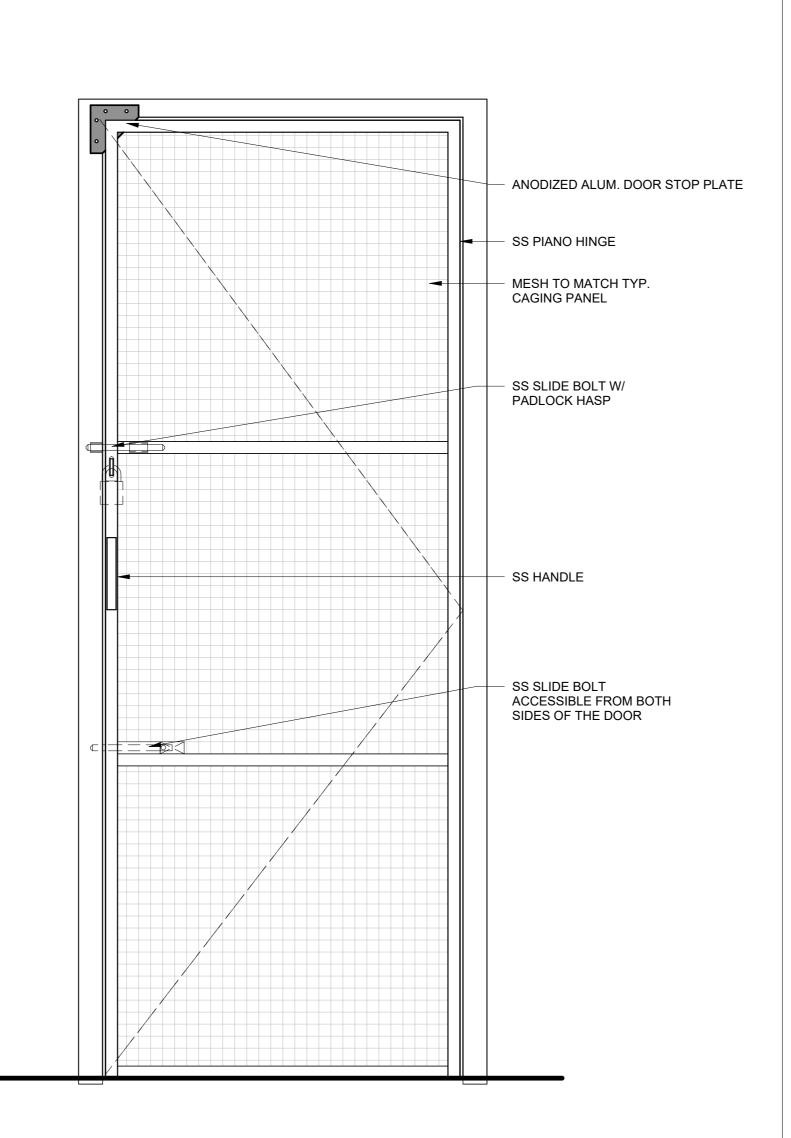

1 1/2" = 1'-0"

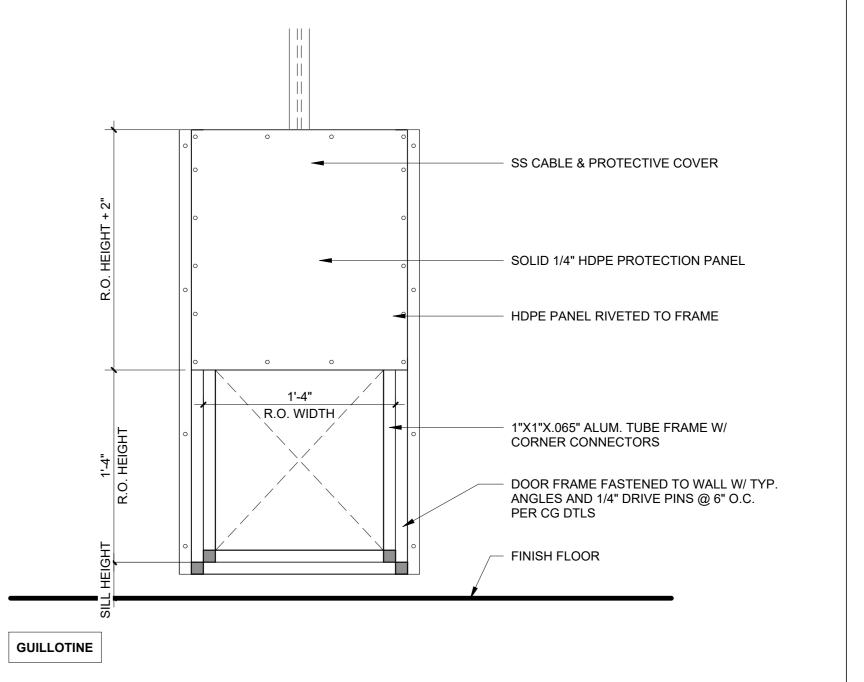

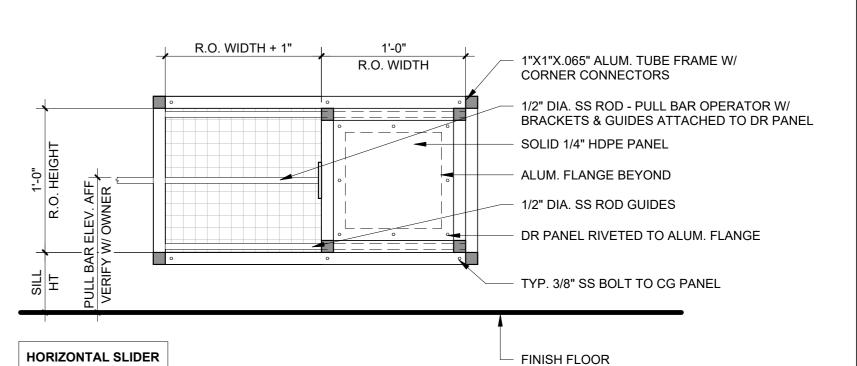

KEEPER DOOR TYPE

ANIMAL TRANSFER DOOR TYPE

1 1/2" = 1'-0"



PROJECT TEAM:

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STRUCTURAL ENGINEER: STRUCTURAL DESIGN STUDIO, INC 2225 EAST MURRAY HOLLADAY RD SALT LAKE CITY, UT 84117 T: 801.274.3950

MEP ENGINEER:
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190 WEST OSTEND ST, STE 300
BALTIMORE, MD 21230
T: 410.244.7191

CLIENT: MARYLAND 700

THE MARYLAND ZOO IN BALTIMORE


1 SAFARI PLACE

BALTIMORE, MD 21217

RED PANDA

THE MARYLAND ZOO
IN BALTIMORE
1 SAFARI PLACE
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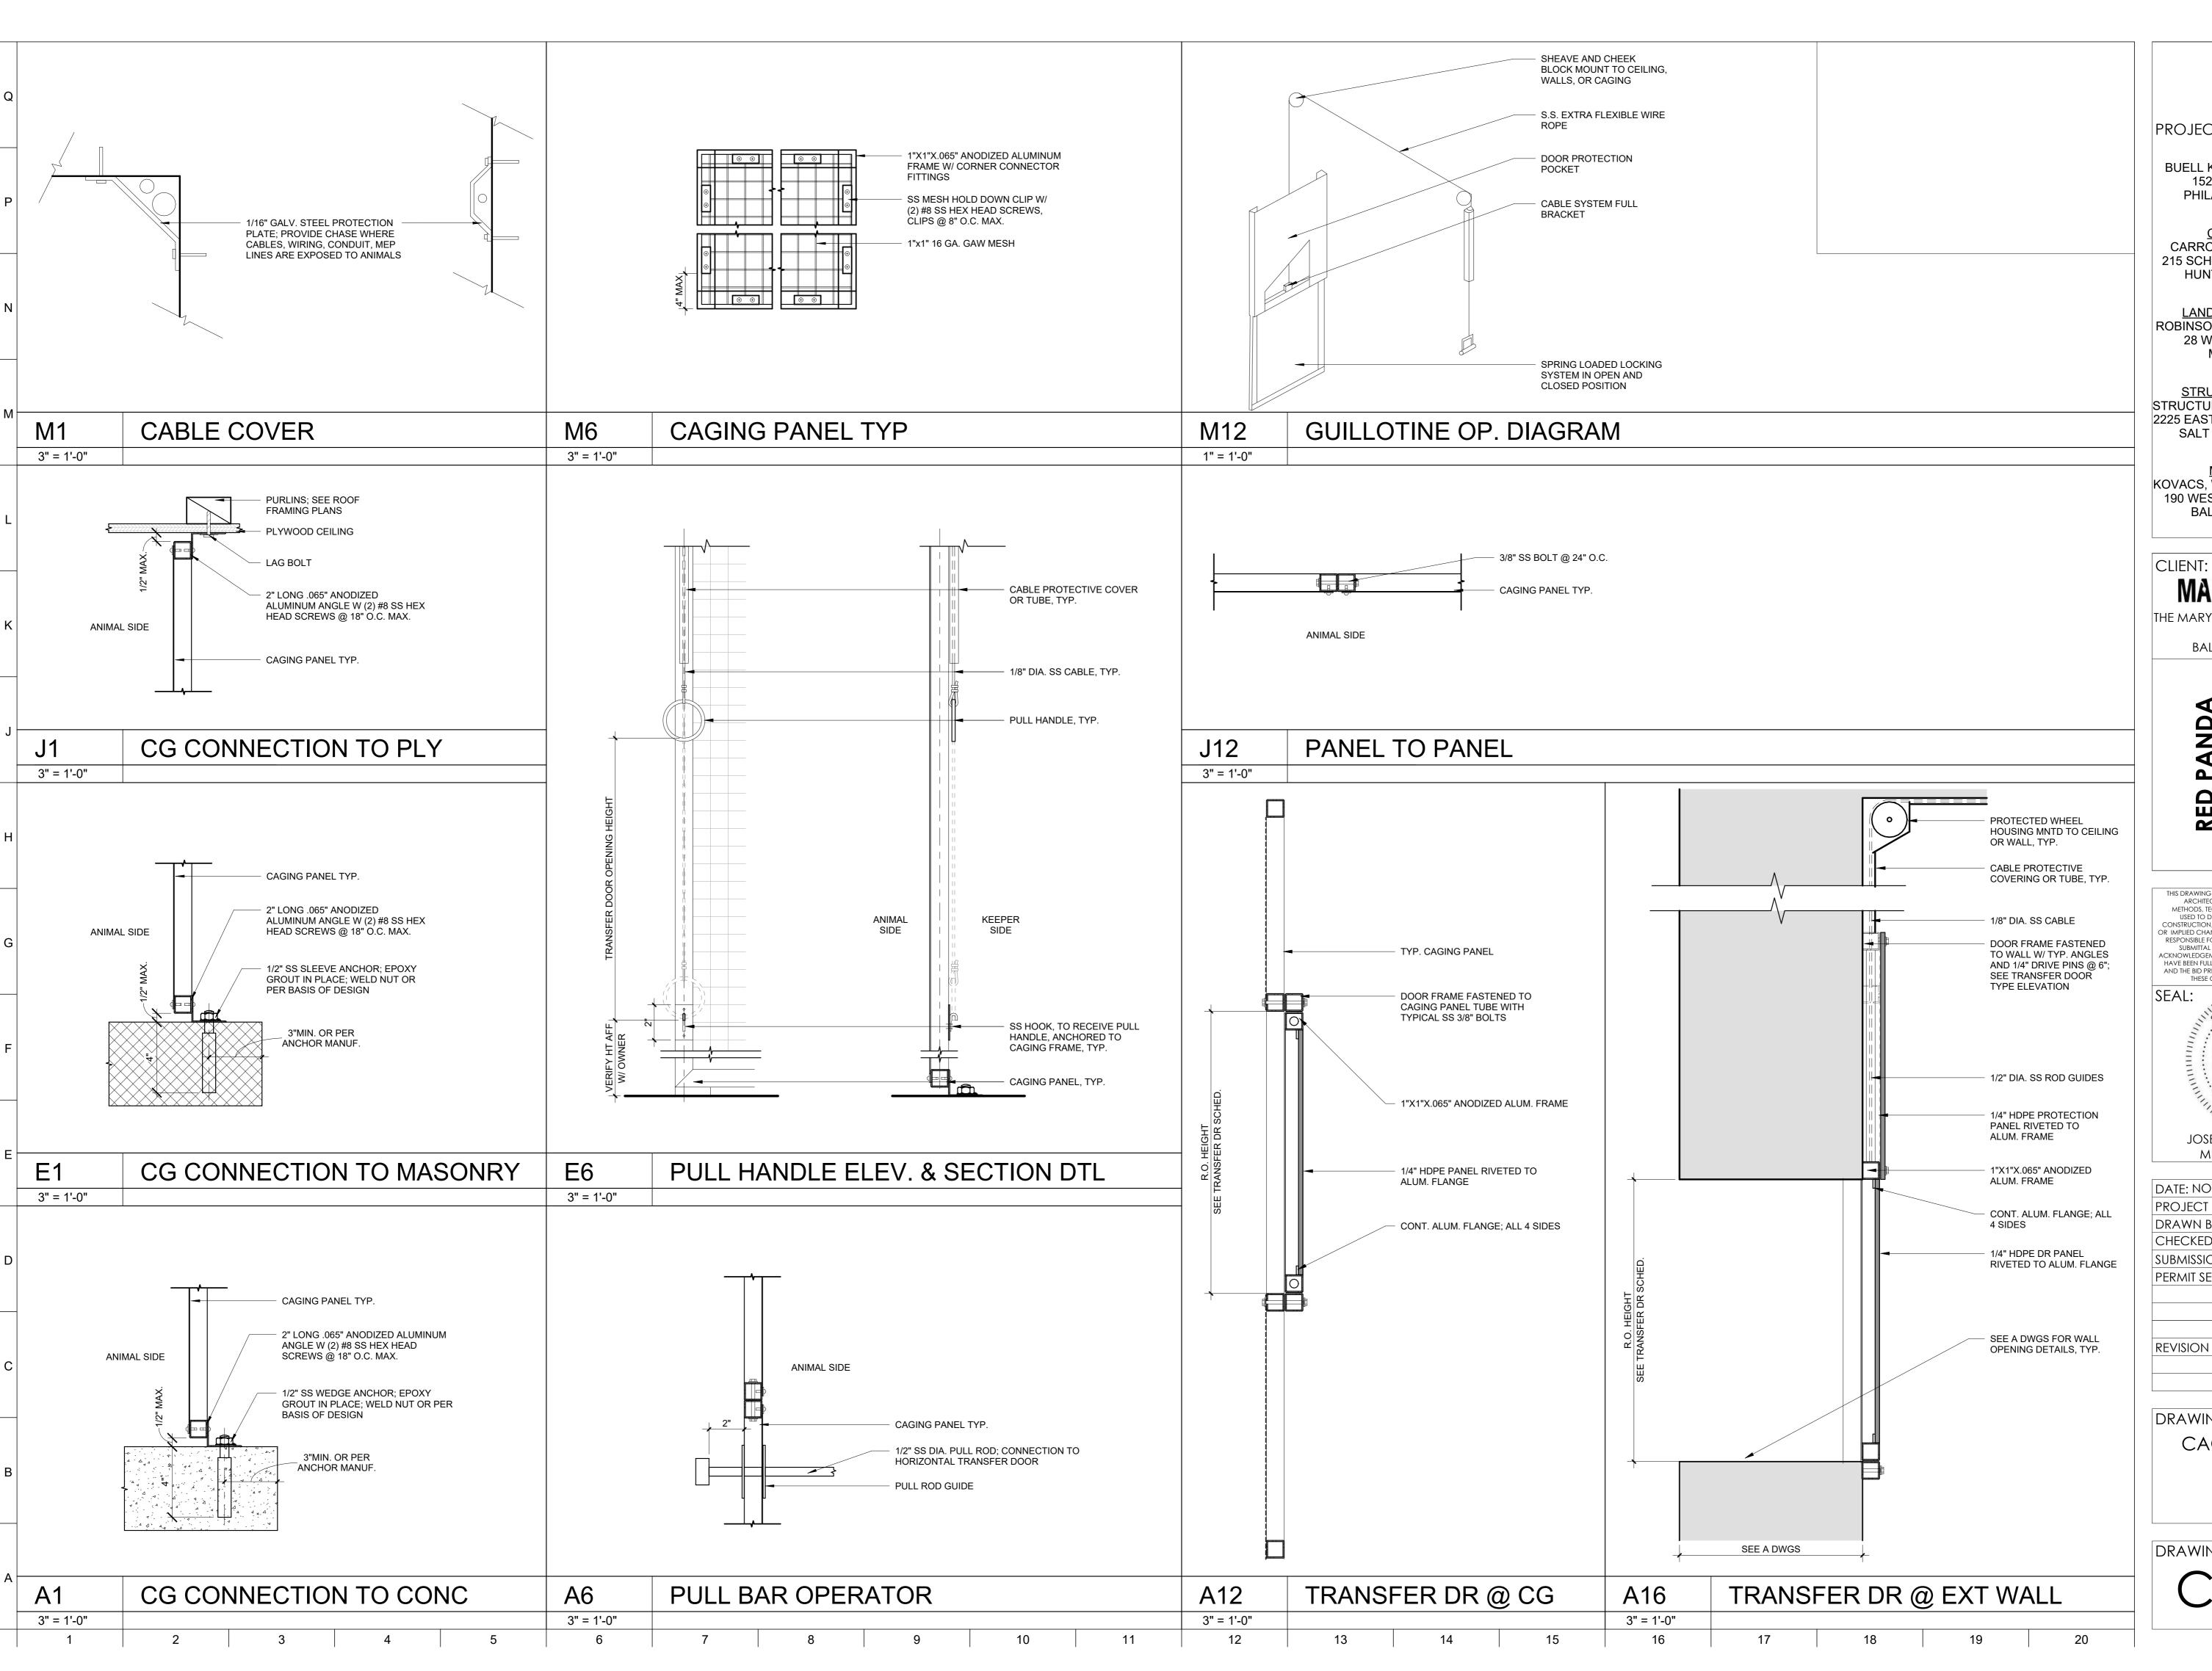
MD LICENSE: 14268

DATE: NOVEMBER 2	2. 2024					
PROJECT NO: 2023-10.04						
DRAWN BY CC						
CHECKED BY	JS					
SUBMISSION	DATE					
PERMIT SET	11/22/2024					
REVISION	DATE					

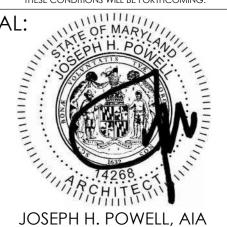DRAWING TITLE:

CAGING GENERAL REQUIREMENTS

DRAWING NO:





ARCHITECT: BUELL KRATZER POWELL, P.C. 1525 LOCUST STREET PHILADELPHIA, PA 19102 T: 215.557.6509

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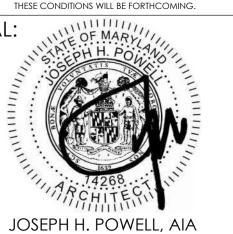
MEP ENGINEER: KOVACS, WHITNEY & ASSOCIATES 190 WEST OSTEND ST, STE 300 BALTIMORE, MD 21230

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THE MARYLAND ZOO IN BALTIMORE

1 SAFARI PLACE BALTIMORE, MD 21217


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DATE: NOVEMBER 22, 2024 PROJECT NO: 2023-10.04 CC DRAWN BY CHECKED BY DATE SUBMISSION 11/22/2024 PERMIT SET REVISION DATE

MD LICENSE: 14268

DRAWING TITLE: CAGING DETAILS



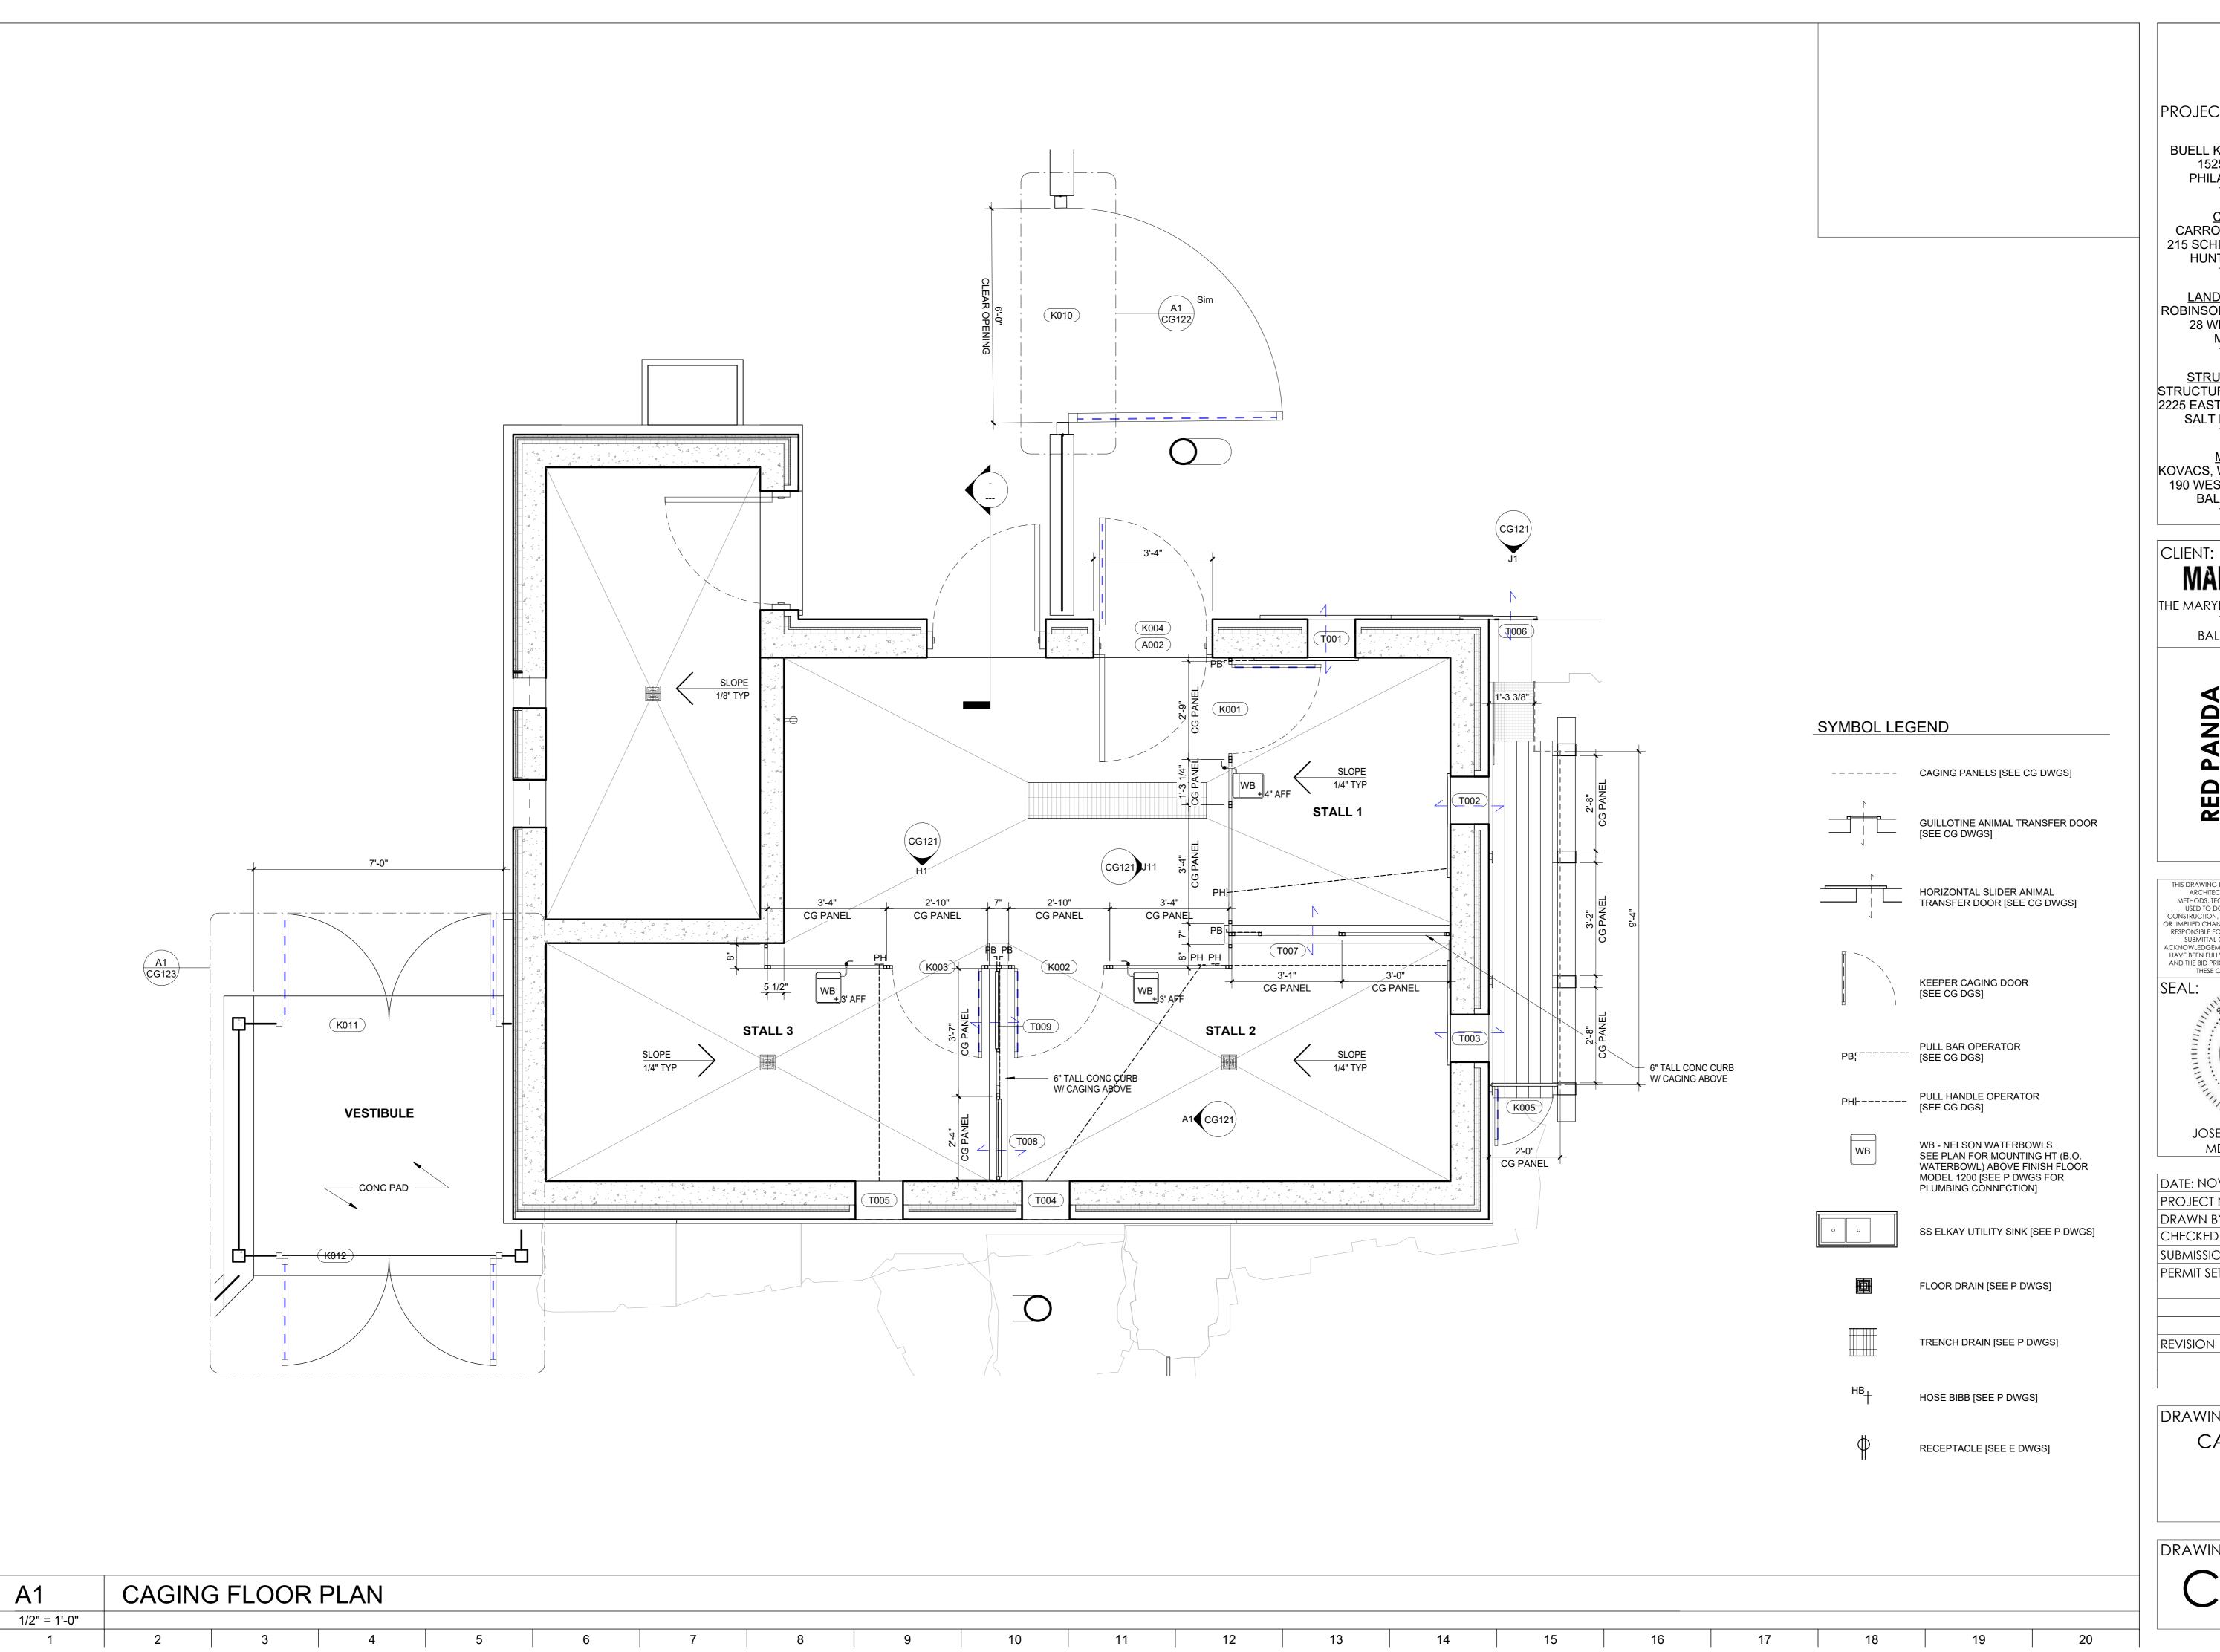

ARCHITECT: BUELL KRATZER POWELL, P.C. 1525 LOCUST STREET PHILADELPHIA, PA 19102 T: 215.557.6509

CIVIL ENGINEER: CARROLL ENGINEERING, INC 215 SCHILLING CIRCLE, STE 102 HUNT VALLEY, MD 21031 T: 410.785.7423


LANDSCAPE ARCHITECT: ROBINSON ANDERSON SUMMERS 28 WEST STATE STREET MEDIA, PA 19063 T: 302.888.1544

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THE MARYLAND ZOO IN BALTIMORE 1 SAFARI PLACE BALTIMORE, MD 21217

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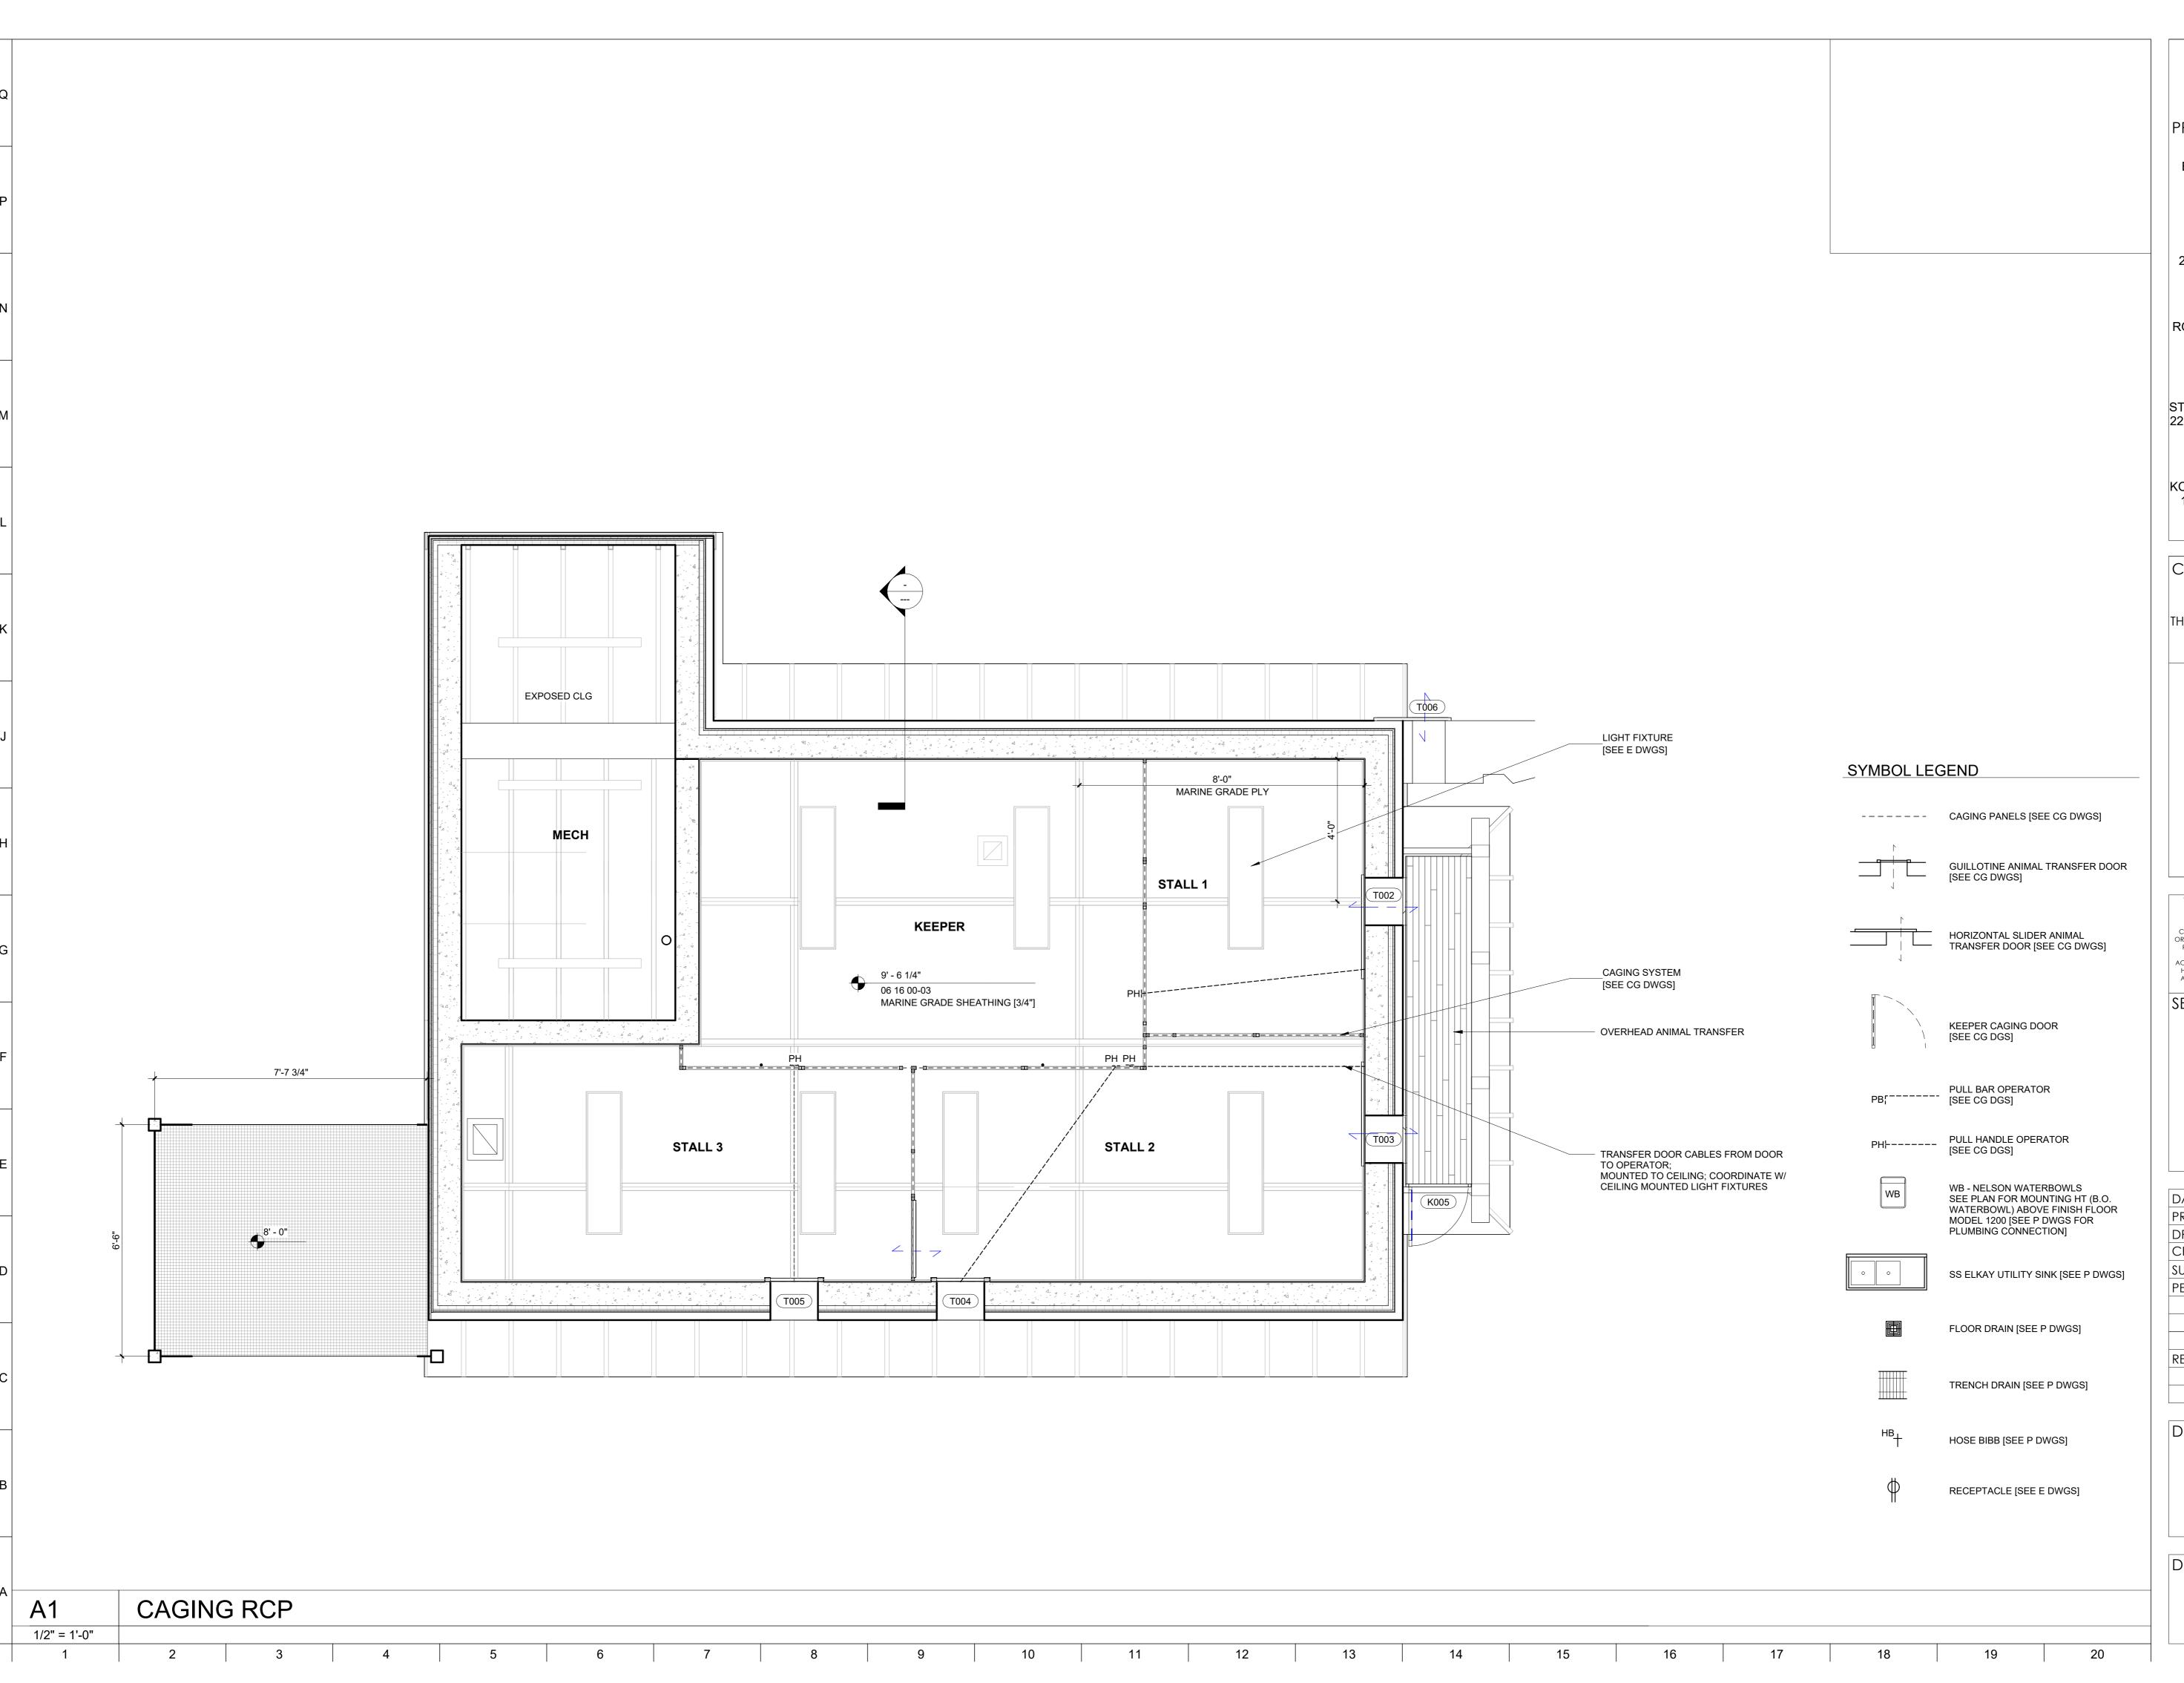


MD LICENSE: 14268

DATE: NOVEMBER 22, 2024						
PROJECT NO: 2023-10.04						
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CHECKED BY	JP					
SUBMISSION	DATE					
PERMIT SET	11/22/2024					
REVISION	DATE					

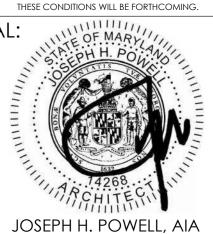DRAWING TITLE: CAGING PLAN

DRAWING NO:





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CLIENT: MARYLAND 700


THE MARYLAND ZOO IN BALTIMORE

1 SAFARI PLACE

BALTIMORE, MD 21217

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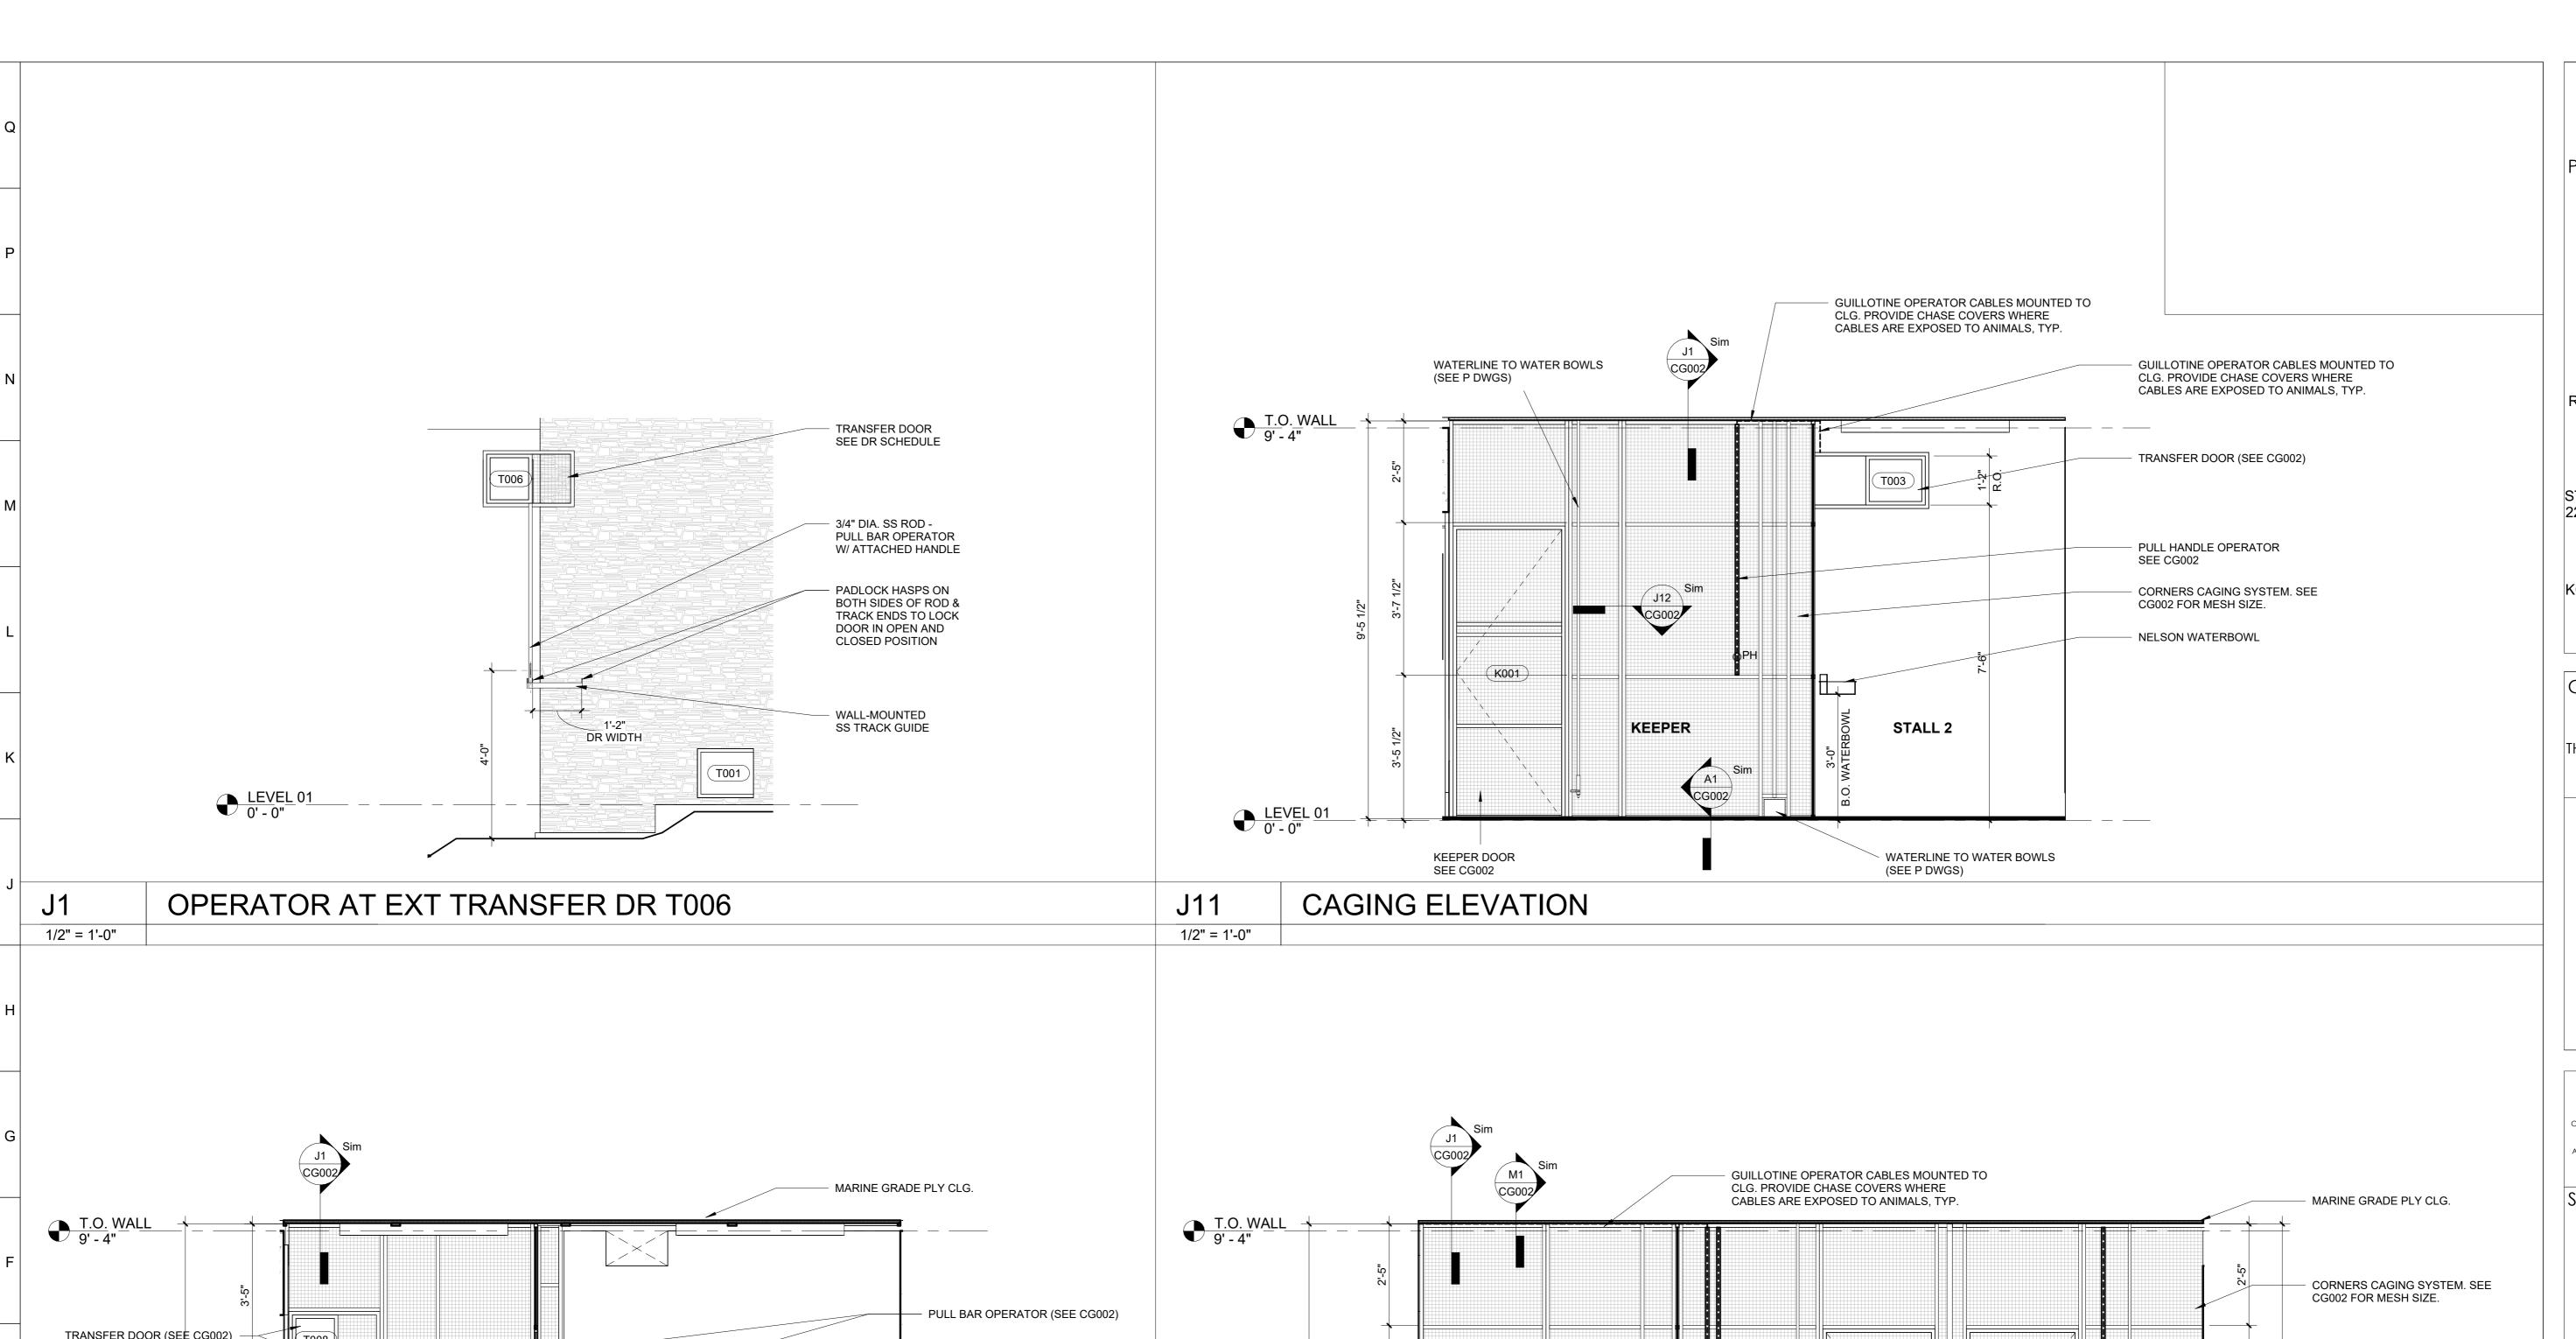



DATE: NOVEMBER 22, 2024						
PROJECT NO: 2023-10.04						
DRAWN BY	CC					
CHECKED BY	JP					
SUBMISSION	DATE					
PERMIT SET	11/22/2024					
REVISION	DATE					

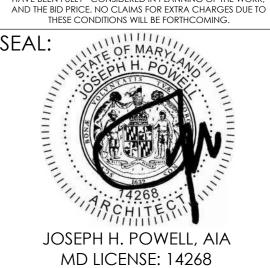
DRAWING TITLE:

CAGING PLAN RCP

DRAWING NO:



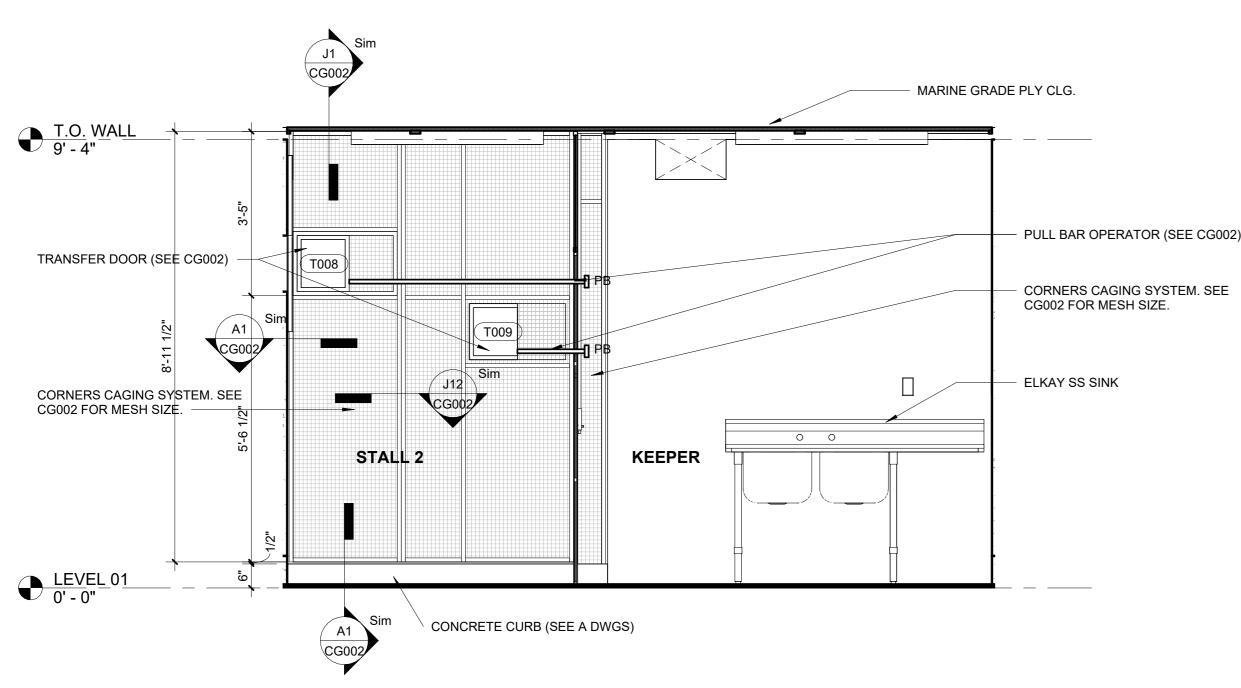

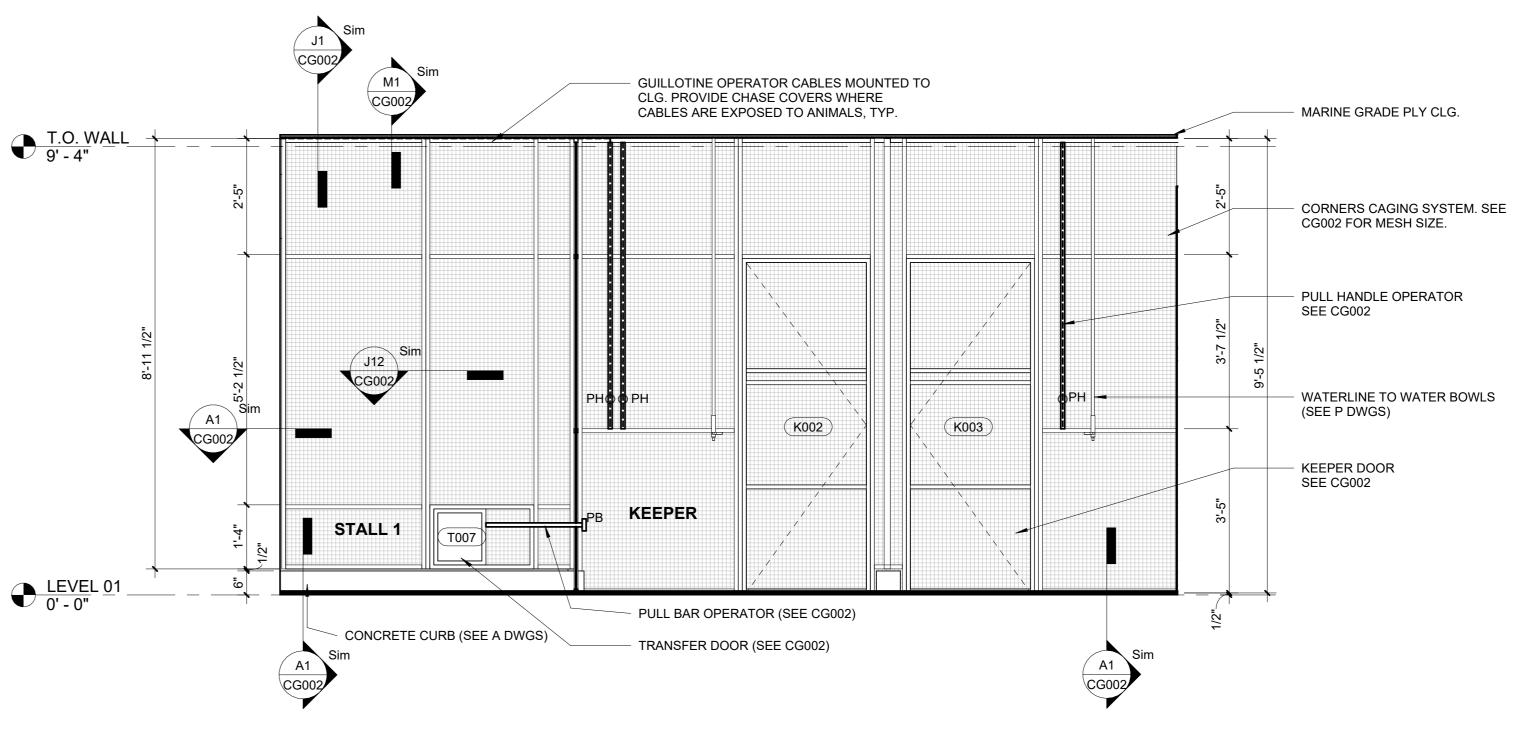

 A1
 CAGING ELEVATION

 1/2" = 1'-0"
 1/2" = 1'-0"

 1
 2
 3
 4
 5
 6
 7
 8
 9
 10
 11
 12
 13
 14
 15
 16
 17
 18
 19
 20



PROJECT TEAM:

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MEP ENGINEER:
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190 WEST OSTEND ST, STE 300
BALTIMORE, MD 21230
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CLIENT: MARYLAND ZOO


THE MARYLAND ZOO IN BALTIMORE

1 SAFARI PLACE

BALTIMORE, MD 21217

THE MARYLAND ZOO
IN BALTIMORE
1 SAFARI PLACE
BALTIMORE, MD 21217

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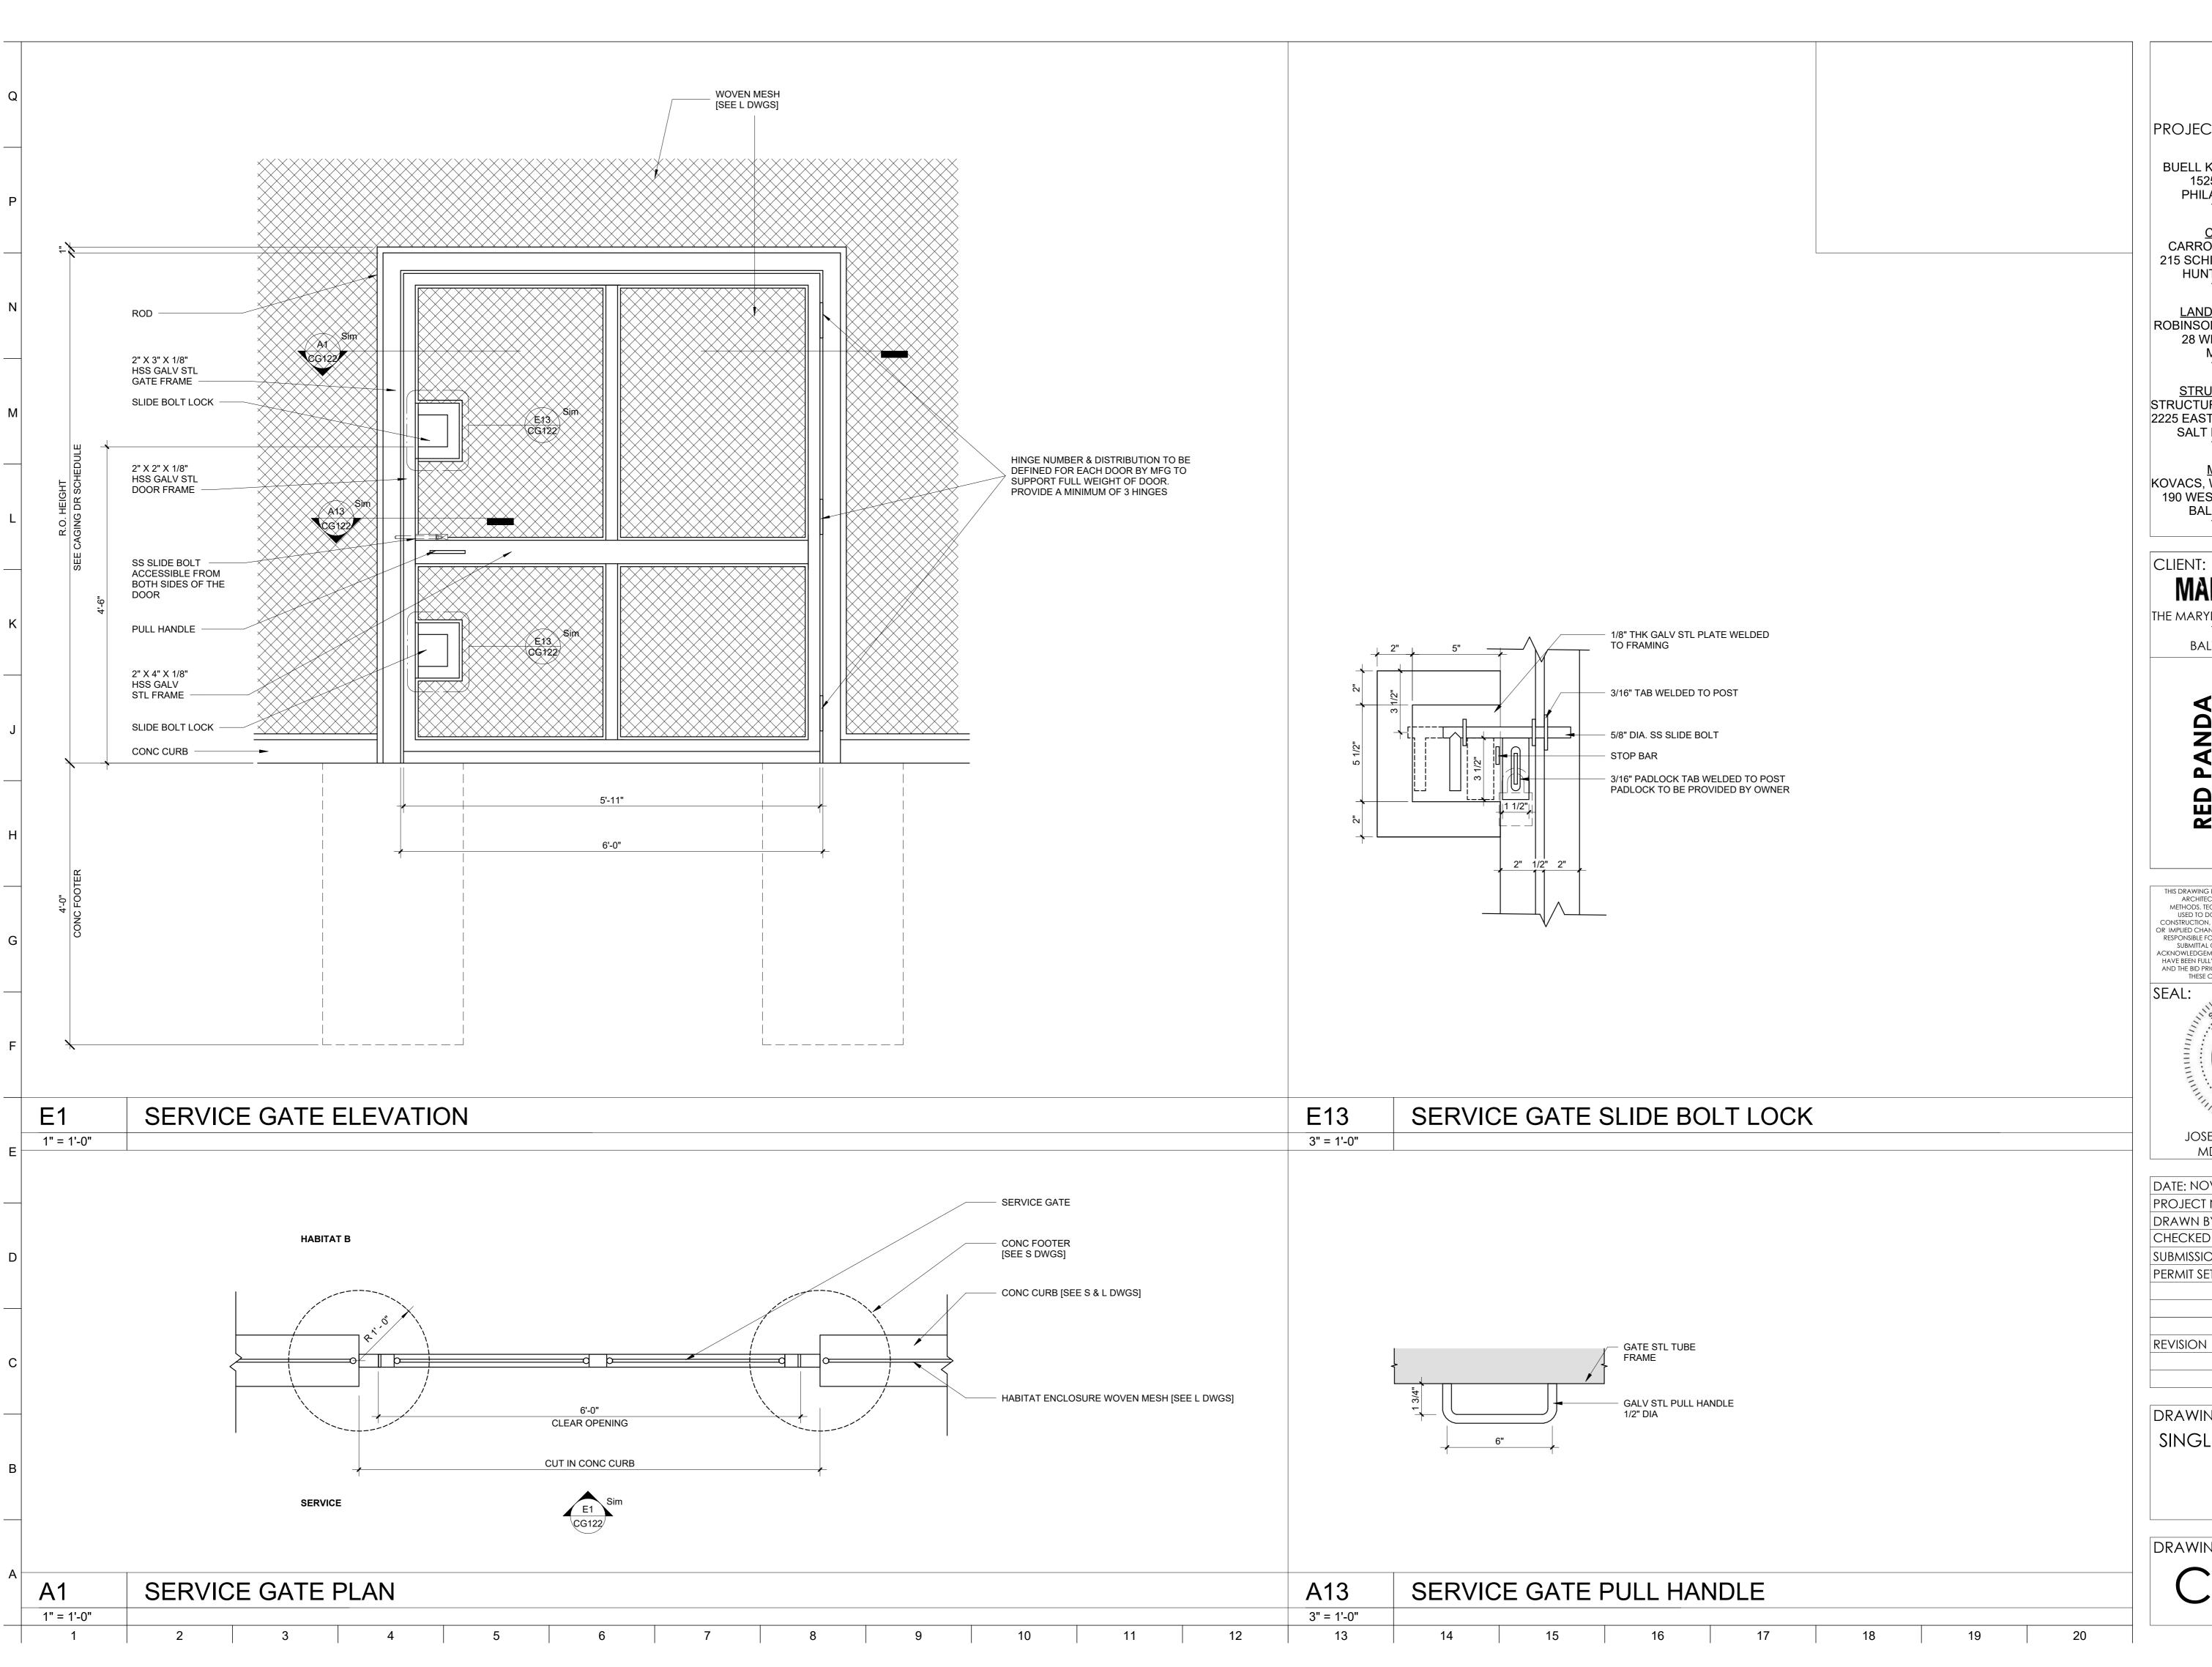


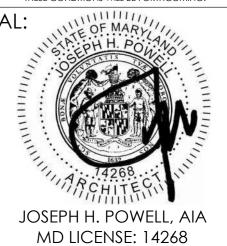DATE: NOVEMBER	22, 2024
PROJECT NO: 2023	3-10.04
DRAWN BY	CC
CHECKED BY	JS
SUBMISSION	DATE
PERMIT SET	11/22/202
REVISION	DATE

DRAWING TITLE:

CAGING ELEVATIONS

DRAWING NO:



ARCHITECT: BUELL KRATZER POWELL, P.C. 1525 LOCUST STREET PHILADELPHIA, PA 19102 T: 215.557.6509

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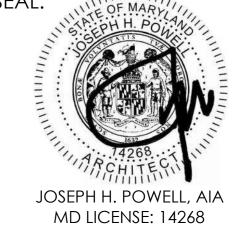
LANDSCAPE ARCHITECT: ROBINSON ANDERSON SUMMERS 28 WEST STATE STREET MEDIA, PA 19063 T: 302.888.1544

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MEP ENGINEER: KOVACS, WHITNEY & ASSOCIATES 190 WEST OSTEND ST, STE 300 BALTIMORE, MD 21230 T: 410.244.7191

THE MARYLAND ZOO IN BALTIMORE 1 SAFARI PLACE BALTIMORE, MD 21217


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DATE: NOVEMBER 22, 2024							
PROJECT NO: 2023-10.0)4						
DRAWN BY	CC						
CHECKED BY	JS						
SUBMISSION	DATE						
PERMIT SET	11/22/2024						
REVISION	DATE						

DRAWING TITLE: SINGLE SERVICE GATE

DRAWING NO:



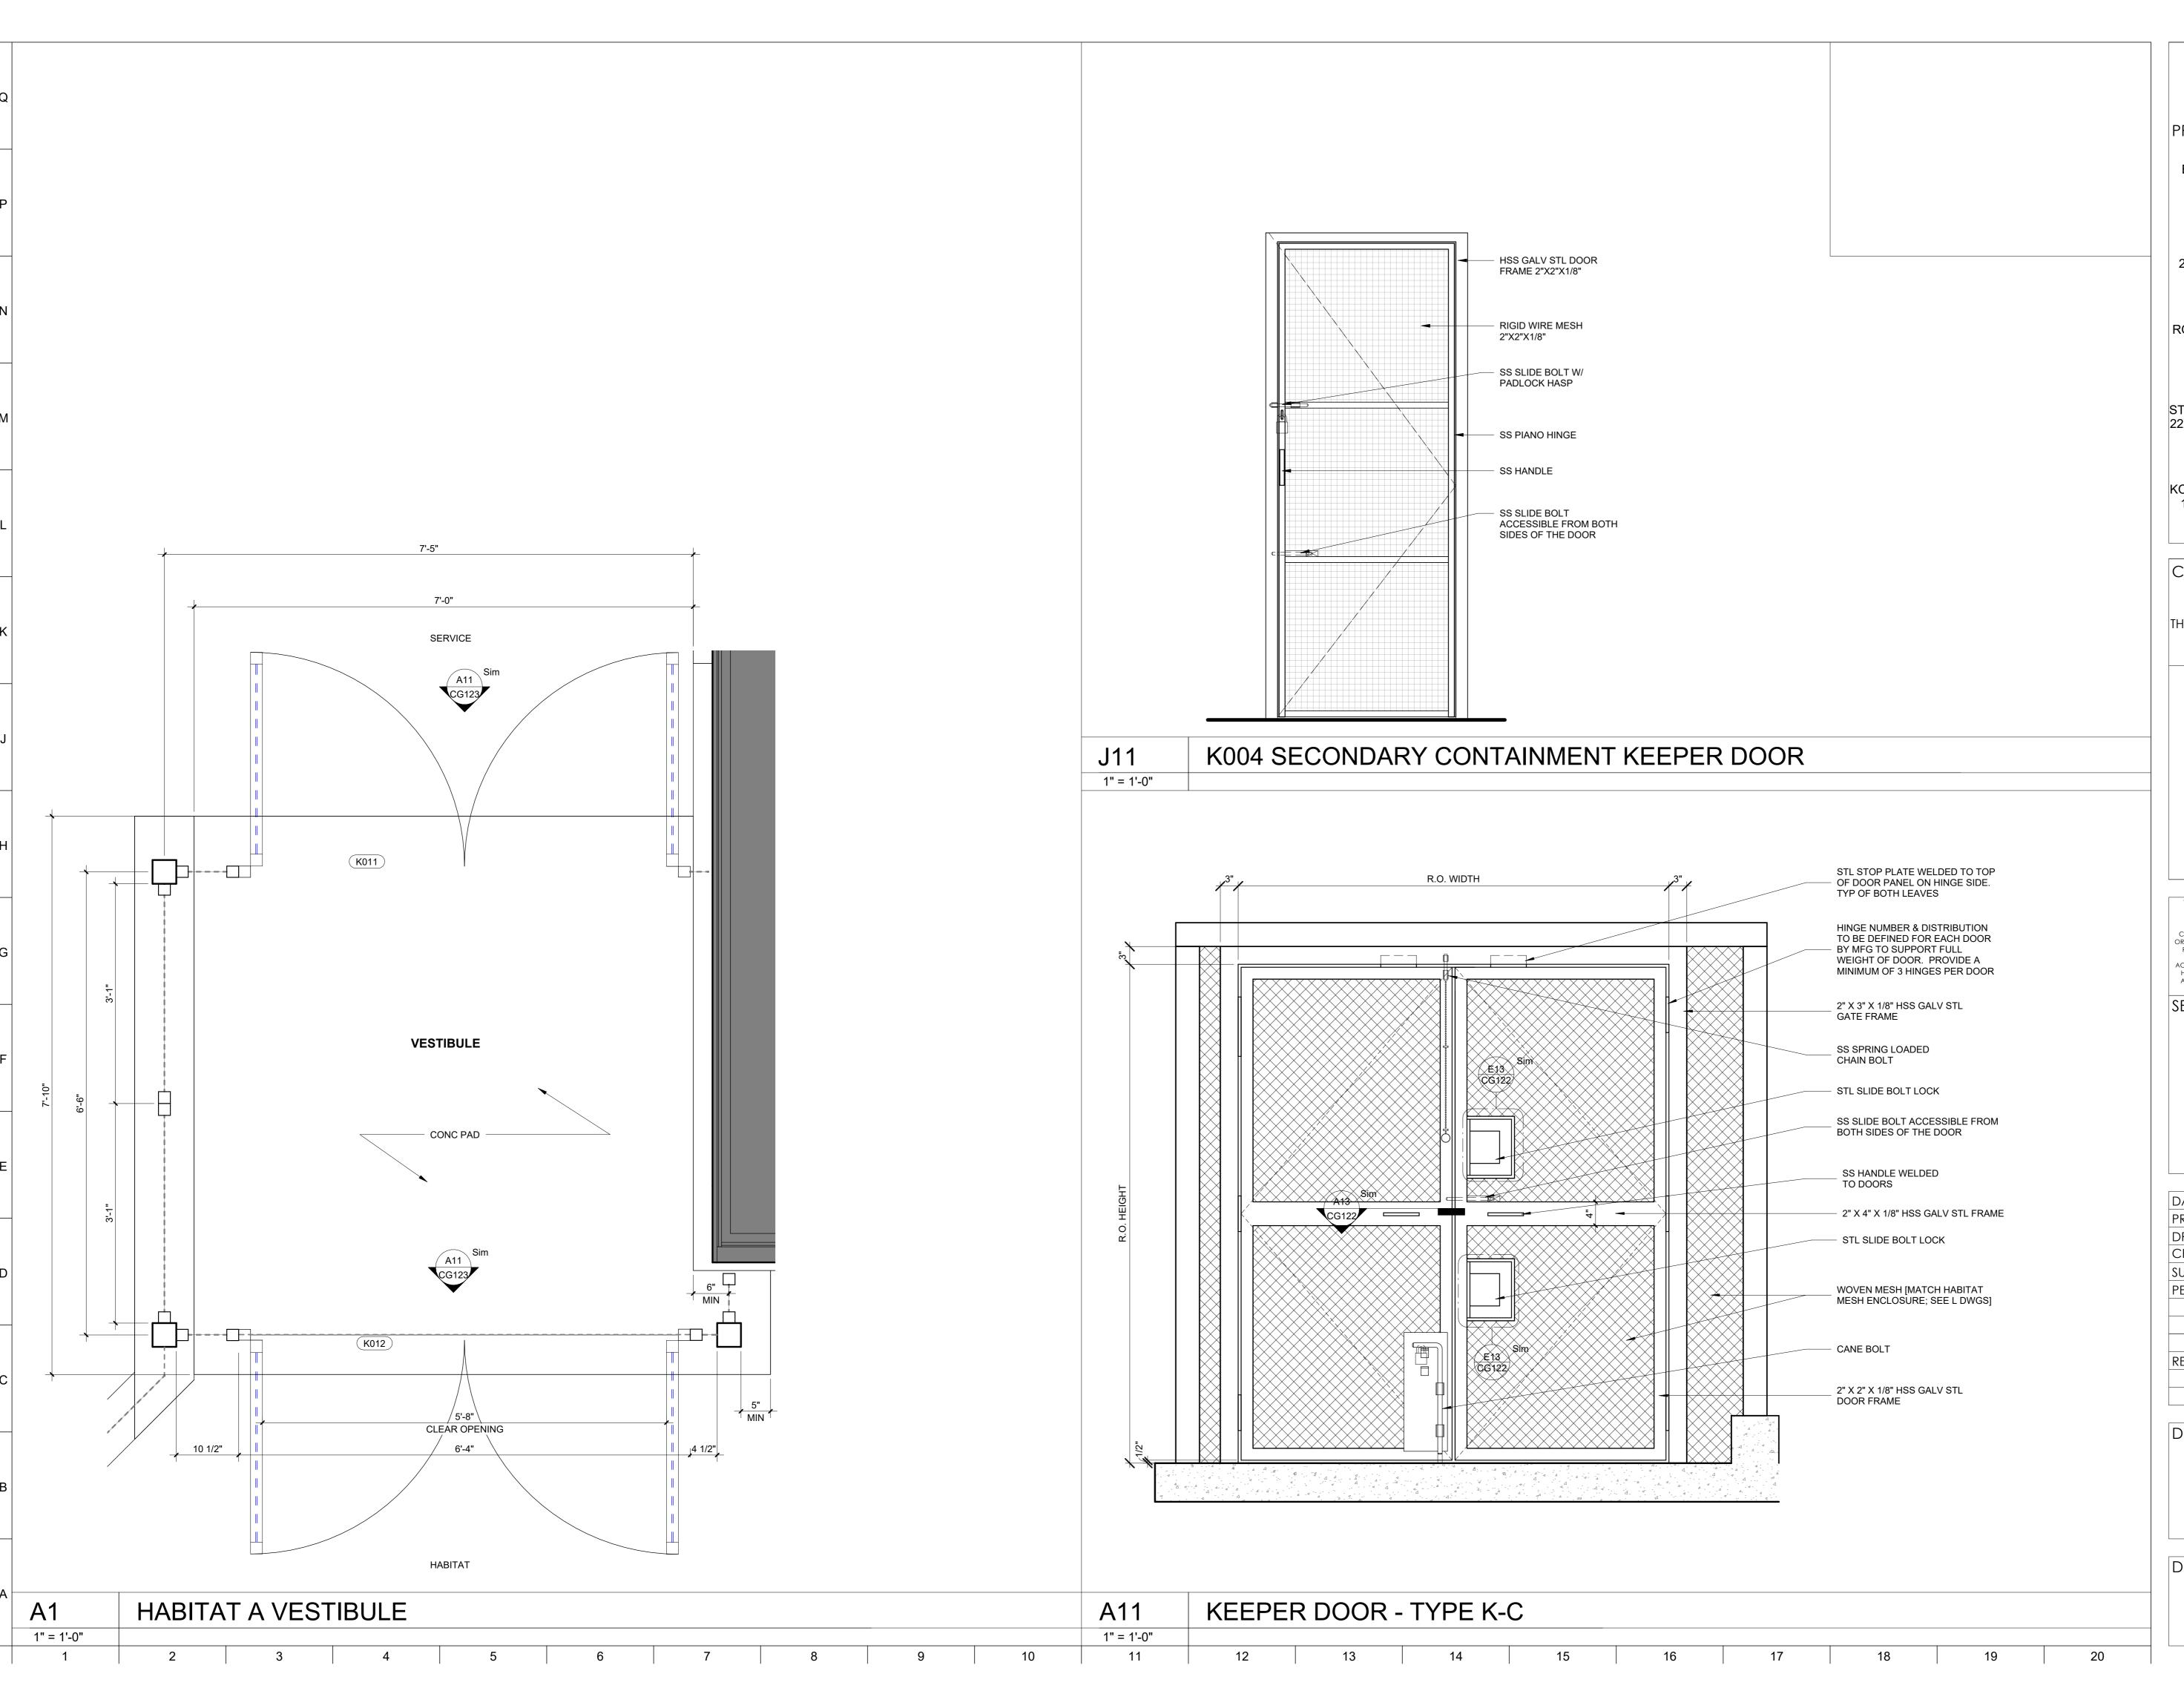

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LANDSCAPE ARCHITECT:
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T: 302.888.1544

STRUCTURAL ENGINEER: STRUCTURAL DESIGN STUDIO, INC 2225 EAST MURRAY HOLLADAY RD SALT LAKE CITY, UT 84117 T: 801.274.3950


MEP ENGINEER:
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190 WEST OSTEND ST, STE 300
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T: 410.244.7191

CLIENT: MARYLAND 700

THE MARYLAND ZOO IN BALTIMORE
1 SAFARI PLACE
BALTIMORE, MD 21217

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3ALTIMORE, MD 21217

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MD LICENSE: 14268

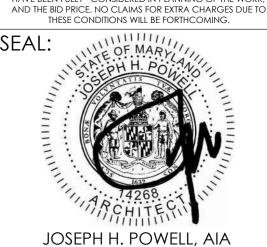DATE: NOVEMBER 22, 2024						
PROJECT NO: 2023-10.04						
DRAWN BY	CC					
CHECKED BY	JS					
SUBMISSION	DATE					
PERMIT SET	11/22/2024					
REVISION	DATE					

DRAWING TITLE:

VESTIBULE DOUBLE SERVICE GATES

DRAWING NO:

PLUMBING FIXTURE SCHEDULE								
DESIGN	DESCRIPTION	SAN	TRAP	VENT	CW	HW	TW	REMARKS
P-1	TWO-COMPARTMENT SINK 2	ı	-	-	1/2"	1/2"	ı	1

DRAIN SINK INTO 3" FLOOR SINK. REFER TO DRAWINGS FOR FLOOR SINK LOCATION.
PROVIDE DRAIN PIPING FROM EACH COMPARTMENT AND DISCHARGE INTO FLOOR SINK.

TWO COMPARTMENT SINK WITH 18"X18"X12" BOWLS, 10" HIGH BACK SPLASH, 24" RIGHT SIDE DRAINBOARD AND STAINLESS STEEL LEGS. ELKAY MODEL #2C18X18-R-24X.
FAUCET: CHICAGO FAUCETS NO. 510-GVB613L12XKCAB.
REFER TO SPECIFICATIONS SECTION 224000.

WATER HEATER SCHEDULE							
DESIG.	LOCATION	TYPE	CAPACITY (GAL.)	kw input	VOLTS/PHASE	A.O. SMITH MODEL	REMARKS
WH-1	MECH ROOM	ELECTRIC	55	3	240	DEN-52	ALL

1) DUEL HEATING ELEMENT WITH NON-SIMULTANEOUS OPERATION.

2) PROVIDE WITH MANUFACTURER'S RELIEF VALVE.

3 SET WATER HEATER TEMPERATURE TO 130'F. SET MIXING VALVE LEAVING TEMPERATURE TO 120'F.

EQUIPMENT NOTES:

- 1. <u>FLOOR DRAINS</u> LACQUERED CAST IRON BODY WITH BOTTOM OUTLET ZURN MODEL #ZN-415B.
- 2. FLOOR SINK —
 12"x12"x8" DEEP CAST IRON BODY AND SQUARE
 LIGHT-DUTY GRATE WITH ½" SLOTTED OPENINGS
 WHITE ACID RESISTING PORCELAIN ENAMEL INTERIOR AND TOP
 ZURN MODEL #ZN-1901-KC.
- 3. TRENCH DRAIN —

 MODULAR CHANNEL MADE OF 0% WATER ABSORBENT HDPE
 CHANNELS CUT TO LENGTH AS INDICATED ON DRAWINGS
 FIBERGLASS GRATE
 ZURN MODEL #Z882.

REFER TO SPECIFICATION SECTION 221319.

	PUMP SCHEDULE											
DECION	CEDVICE	MODEL	HE/) IMPELLER			MOTOR			LITTLE GIANT PUMP MODEL	DEMADIA
DESIGN.	SERVICE	MODEL	GPM	(FEET)	RPM	(IN.)	WATTS	AMPS	VOLTS	PHASE	1	REMARKS
P-1	HABITAT A WATER FEATURE	FP2	20	10	-	-	167	1. 4 5	120	1	FP SERIES	ı
P-2	HABITAT B WATER FEATURE	FP2	20	10	-	-	167	1.45	120	1	FP SERIES	1
NOTEC.												

<u>Notes:</u>

1 LITTLE GIANT FP SERIES MODEL FP2 OR APPROVED EQUAL. WET ROTOR PUMP, CLOG RESISTANT AND CAPABLE OF PASSING 1/5" SOLIDS. RATED FOR CONTINUOUS DUTY. 26 FT LONG CORD.

	EXPANSION TANK SCHEDULE							
DESIGN	LOCATION	SERVICE	TYPE	TOTAL VOL. MIN. GAL.	ACCEPT VOL. MIN. GAL.	DIAMETER X LENGTH	WATTS MODEL NUMBER	REMARKS
ET-1	MECH ROOM	DOMESTIC WATER	DIAPHRAGM	3.5	2.3	10"øx14"L	DETA-5	



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MARYLAND ZQO

THE MARYLAND ZOO IN BALTIMORE

1 SAFARI PLACE

BALTIMORE, MD 21217

RED PANDA
THE MARYLAND ZOO
IN BALTIMORE
1 SAFARI PLACE
BALTIMORE, MD 21217

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SEAL:




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	DATE: NOVEMBER	BER 22, 2024			
	PROJECT NO: 202	23-10.04			
	DRAWN BY	KWA			
	CHECKED BY	KWA			
	SUBMISSION	DATE			
	PERMIT SET	11/22/2024			
	REVISION	DATE			

DRAWING TITLE:
PLUMBING SCHEDULES

DRAWING NO:

P_001

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- 1) PROVIDE NEW 12" WIDE AND 60" LONG TRENCH DRAIN.
- PROVIDE SOLIDS INTERCEPTOR BELOW GRADE IN CONCRETE VAULT. REFER TO SOLIDS INTERCEPTOR DETAIL ON SHEET P-501.
- $\overline{3}$ Sanitary Pipe up to Cleanout at Floor above.
- PROVIDE WATER HEATER. MOUNT TO 4" HIGH HOUSEKEEPING PAD.
 REFER TO WATER HEATER DETAIL ON SHEET P-501. REFER TO
 WATER HEATER SCHEDULE ON SHEET P-001.
- PROVIDE MIXING STATION WITH ADJUSTABLE BALL VALVES AND TEMPERATURE GAUGE. REFER TO MIXING STATION DETAIL ON SHEET P-501.
- 6 1/2"DCW DOWN TO WATER BOWL. SECURE PIPE TO CAGING. REFER TO WATER BOWL CONNECTION DETAIL ON SHEET P-501.
- 7 3/4" TEMPERED WATER FROM MIXING VALVE TO HOSE BIBBS.
- 8 1/2"CW BELOW GRADE TO WATER BOWL IN HABITAT. REFER TO HABITAT B PLAN ON SHEET P-102 FOR CONTNUATION.
- $\left\langle 9\right\rangle$ provide floor drain with trap and 3"san connection.
- PROVIDE TEMPERED WATER DOWN ALONG WALL TO HOSE BIBB. ANCHOR PIPE TO WALL AT HOSE BIBB AT EVERY 48" ALONG WALL.
- PROVIDE FLOOR SINK BELOW COMPARTMENT SINK. DRAIN COMPARTMENT SINK TO FLOOR SINK WITH AIR GAP. PROVIDE FLOOR SINK WITH TRAP
- PROVIDE 8"x8" ACCESS DOOR IN CEILING FOR HOSE BIBB ISOLATION BALL
- PROVIDE RECESSED WALL HYDRANT CONNECTED TO TEMPERED WATER. HYDRANTS EXPOSED TO THE EXTERIOR SHALL BE FREEZE-PROOF TYPE.
- RELIEF FITTING FROM HOT WATER HEATER ALONG FLOOR TO FLOOR DRAIN.
- BACKFLOW PREVENTER AND PRESSURE REDUCING VALVE ON INCOMING DCW LINE. REFER TO COLD WATER INLET DETAIL ON SHEET P-501.
- MIXING VALVE FOR DOMESTIC WATER HEATER. REFER TO DOMESTIC HOT WATER MIXING VALVE DETAIL ON SHEET P-501.
- PROVIDE 3" VENT THROUGH WALL AND UP TO ATMOSPHERE. TERMINATE VENT AT LEAST 60" ABOVE OA INTAKE LOUVER.
- COORDINATE WITH CIVIL DIVISION TO CONNECT 4"SAN AND 2"CW FOR NEW HOLDING BUILDING TO 8"SAN AND 2"CW. CONNECTIONS PROVIDED BY CIVIL DIVISION.
- (19) 2" VENT DOWN THROUGH FLOOR.

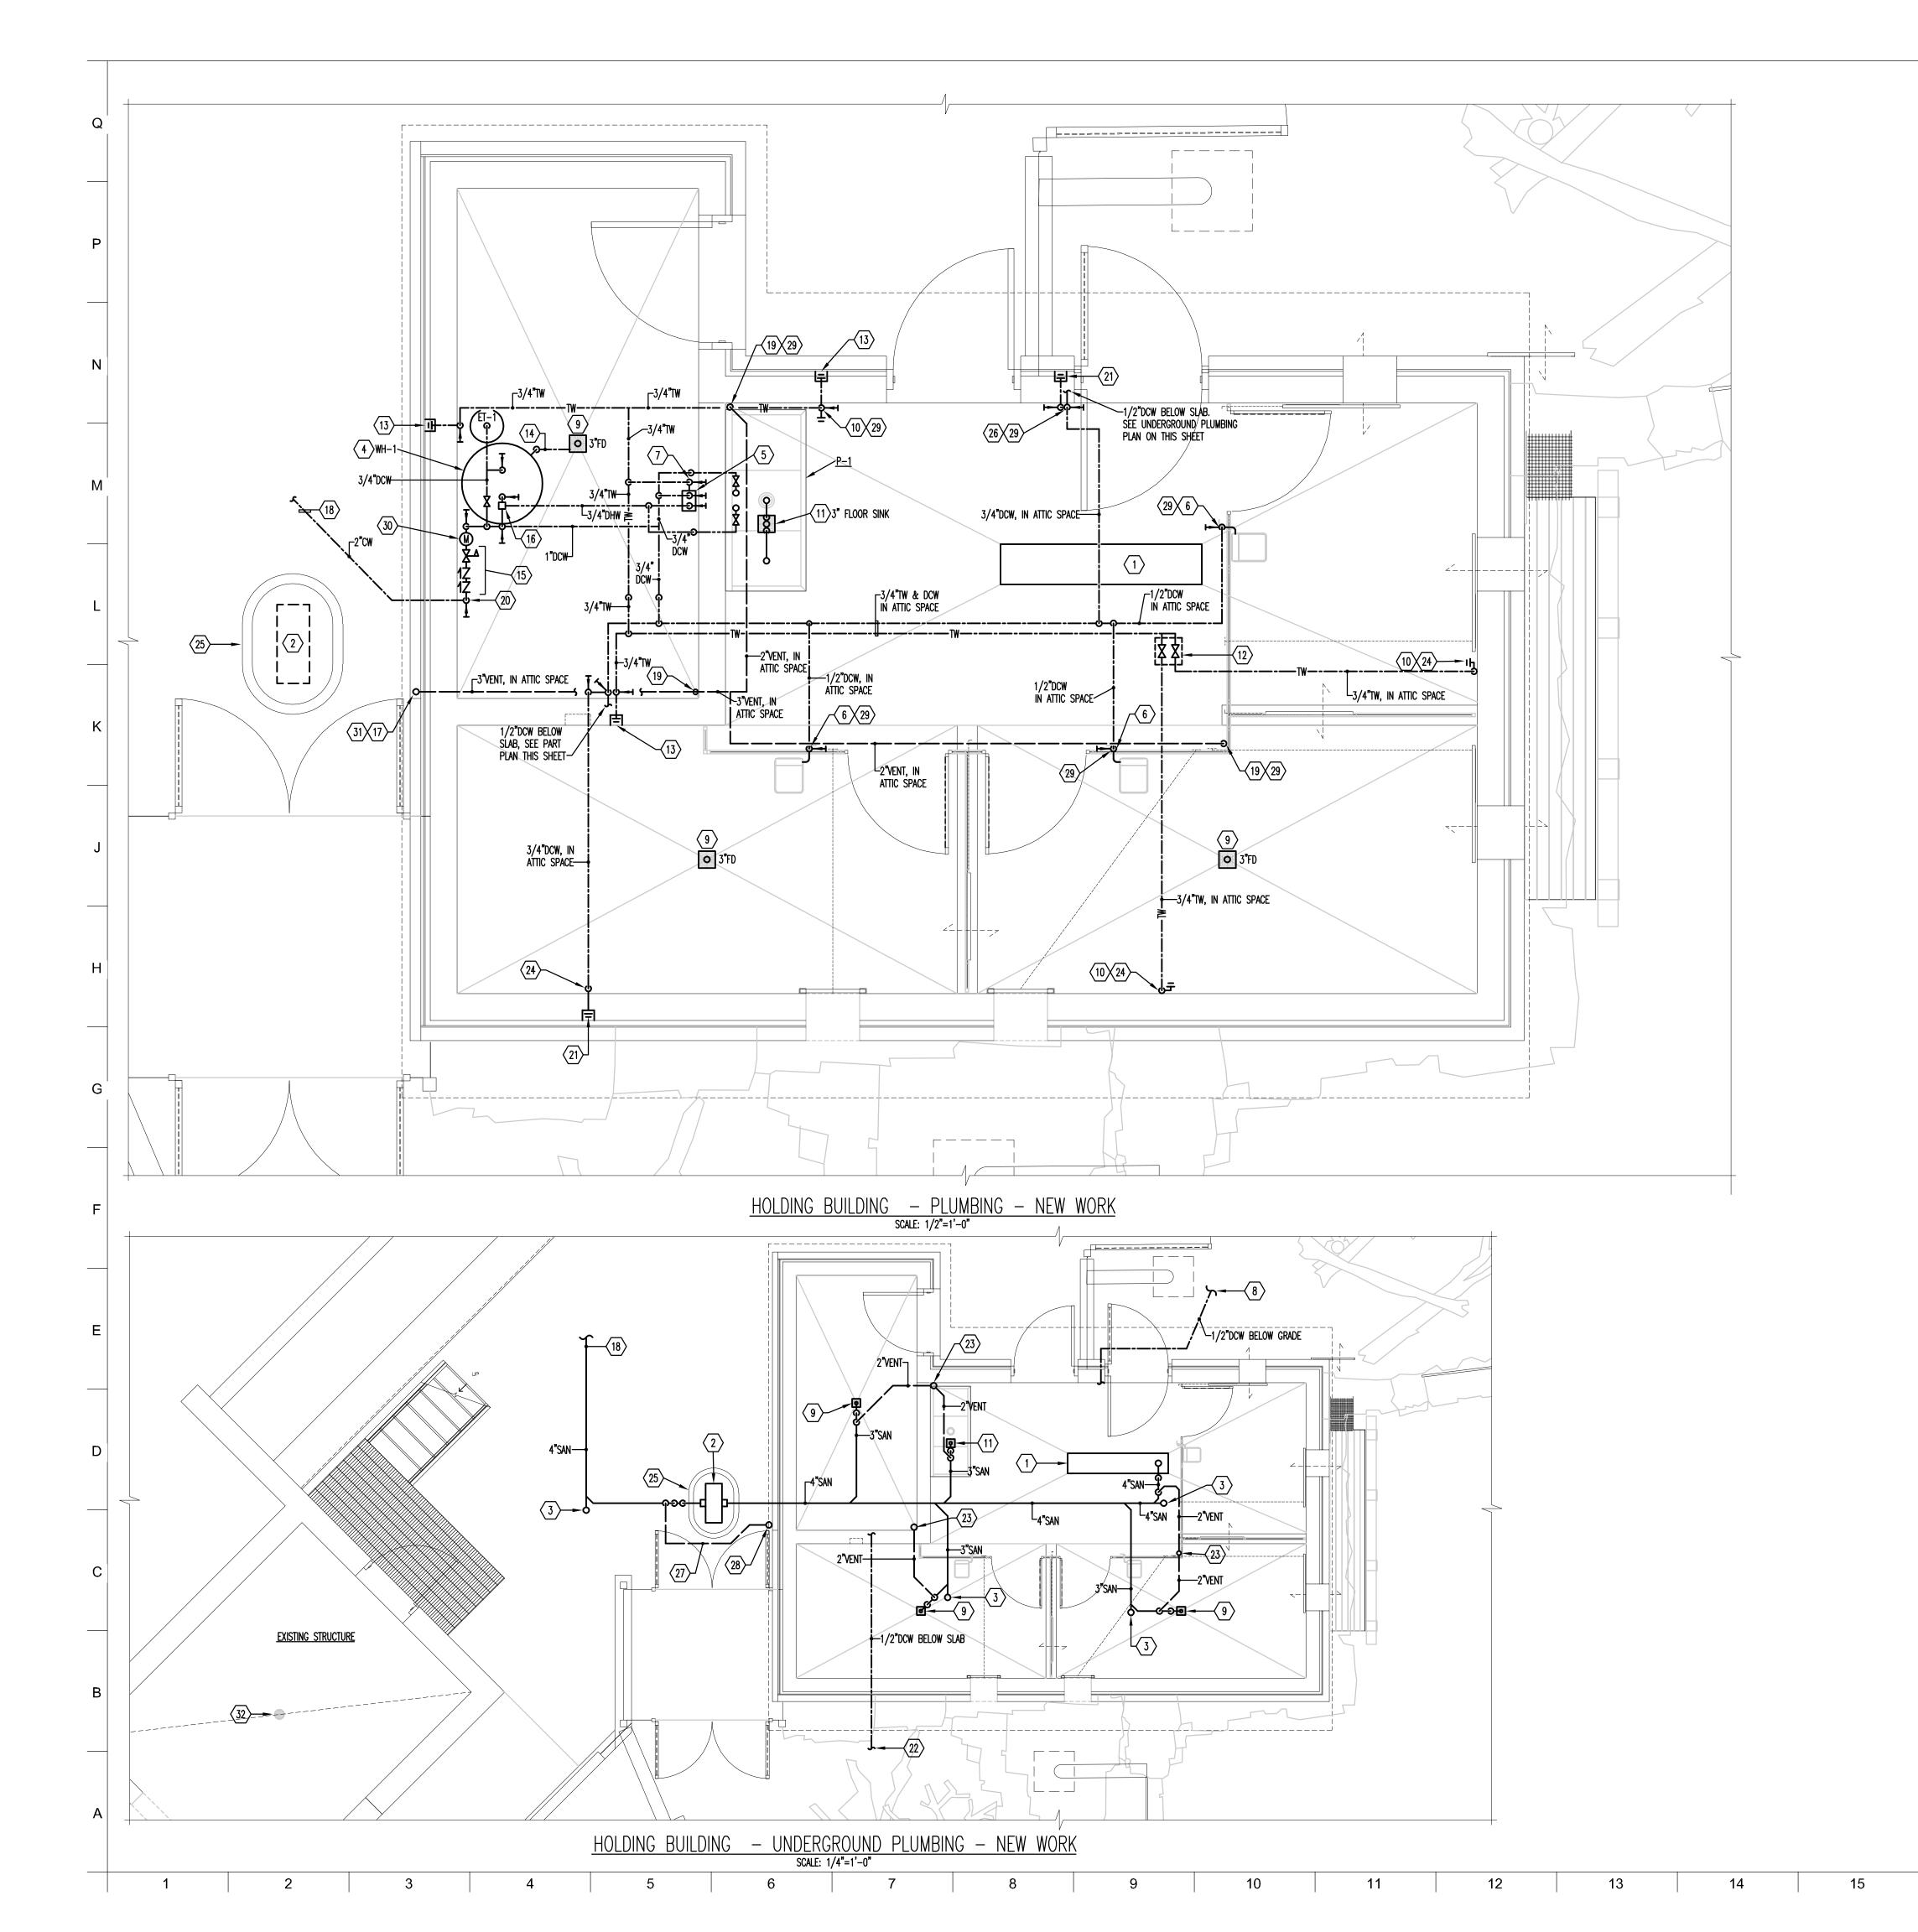AND 3"SAN CONNECTION.

- PROVIDE 2"CW UP THROUGH SLAB THEN REDUCE TO 1-1/4"CW PRIOR TO FITTINGS.
- PROVIDE RECESSED WALL HYDRANT CONNECTED TO DOMESTIC COLD WATER. HYDRANTS EXPOSED TO THE EXTERIOR SHALL BE FREEZE-PROOF TYPE.
- $\langle 22 \rangle$ 1/2"CW below grade to water bowl in Habitat. Refer to Habitat a plan on sheet P-102 for continuation.
- 23 2" VENT UP TO ATTIC SPACE.
- PROVIDE COVER PLATE OVER PIPING IN ANIMAL STALL. REFER TO CG001 FOR DETAILS AND NOTES. WHERE ACCESS TO HOSE BIBBS IS REQUIRED, PROVIDE HINGED ASSEMBLY WITH QUARTER TURN LATCH FOR COVER PLATES.
- (25) CONCRETE VAULT. REFER TO CIVIL DRAWINGS FOR DETAIL.
- DROP DCW DOWN ALONG WALL. PROVIDE BALL VALVE TO ISOLATE HOSE BIBB AND HABITAT WATER BOWL.
- 27 2"VP UNDERGROUND.
- $\overline{\langle 28 \rangle}$ 2"VP UP ALONG EXTERIOR OF BUILDING.
- (29) INSTALL PIPE ESCUTCHEON AT PIPE PENETRATION THROUGH CEILING.
- PROVIDE METRON-FARNIER SPECTRUM SINGLE JET WATER METER. PROVIDE METER WITH VN-LTE REGISTER THAT WILL ALLOW COMMUNICATION WITH WATERSCOPE DASHBOARD. CONTRACTOR TO COORDINATE INSTALLATION WITH MIMIR WATER.

 CONTACT: ANNIKKI CHAMBERLAIN PHONE: 929-910-0149

 EMAIL: annikki@mimirwater.com
- (31) DROP 2*VP DOWN BELOW GRADE.
- CONFIRM THAT DRAINAGE FROM EXISTING FLOOR DRAIN FLOWS UNOBSTRUCTED.
 CLEAR BLOCKAGE IF DOES NOT. TYPICAL AT TWO LOCATIONS IN EXISTING STRUCTURE.



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MARYLAND ZOO

THE MARYLAND ZOO IN BALTIMORE 1 SAFARI PLACE BALTIMORE, MD 21217

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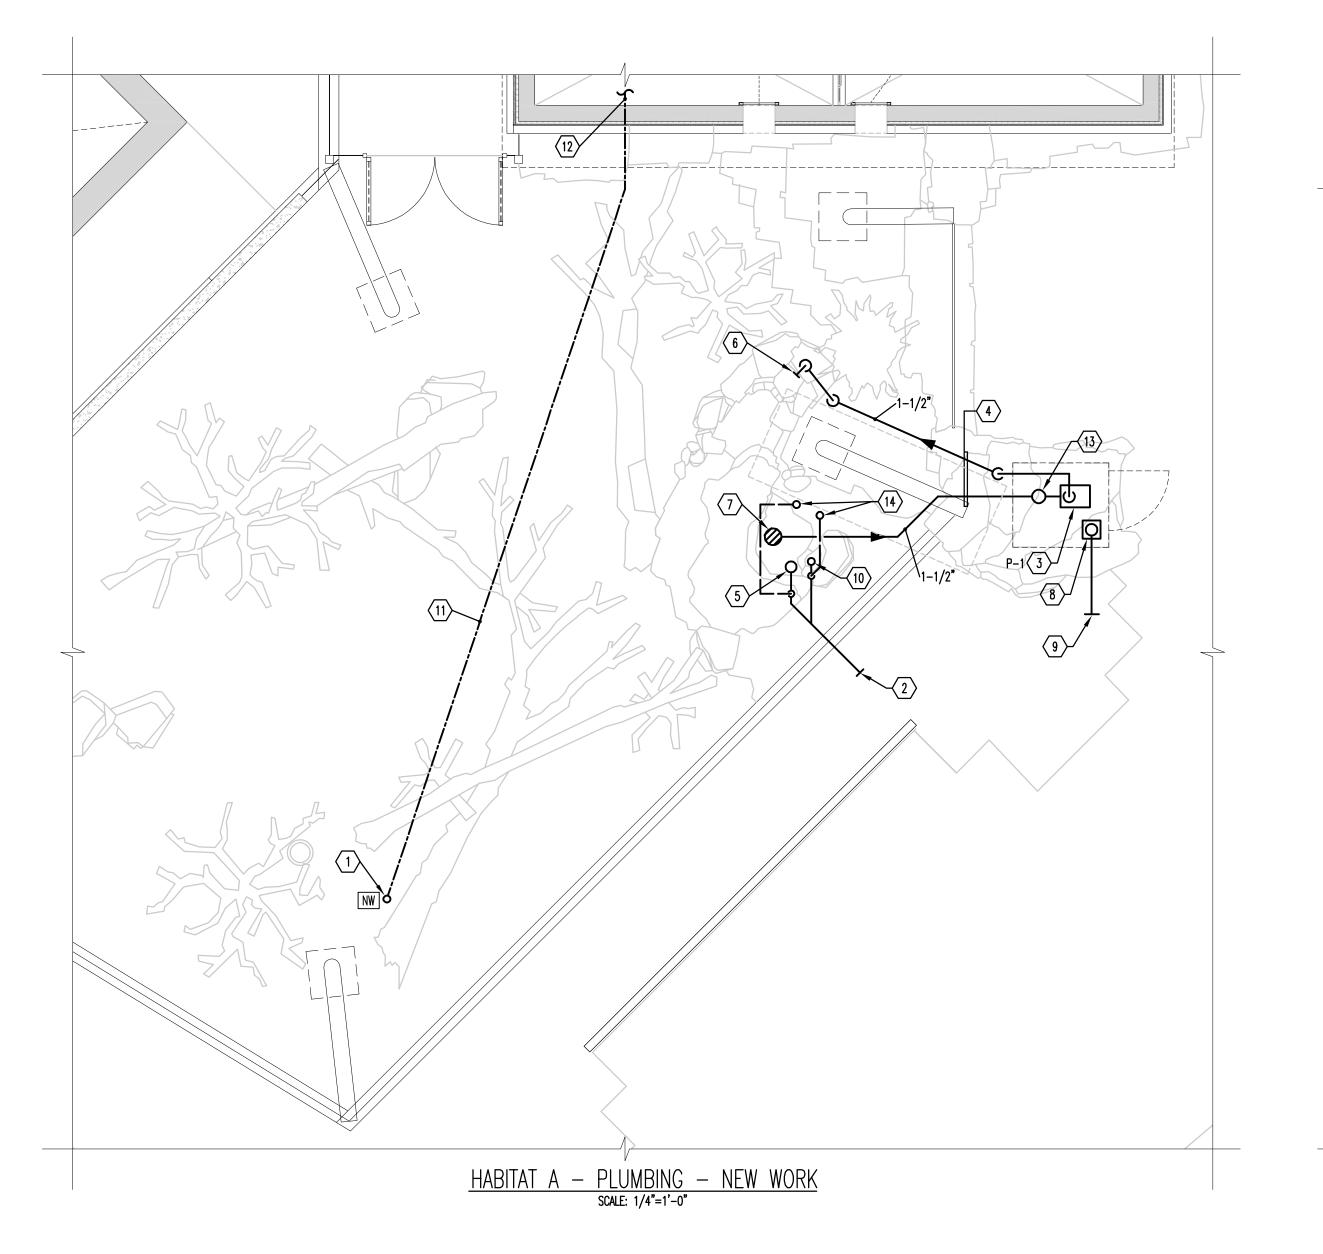
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DRAWN BY KWA		
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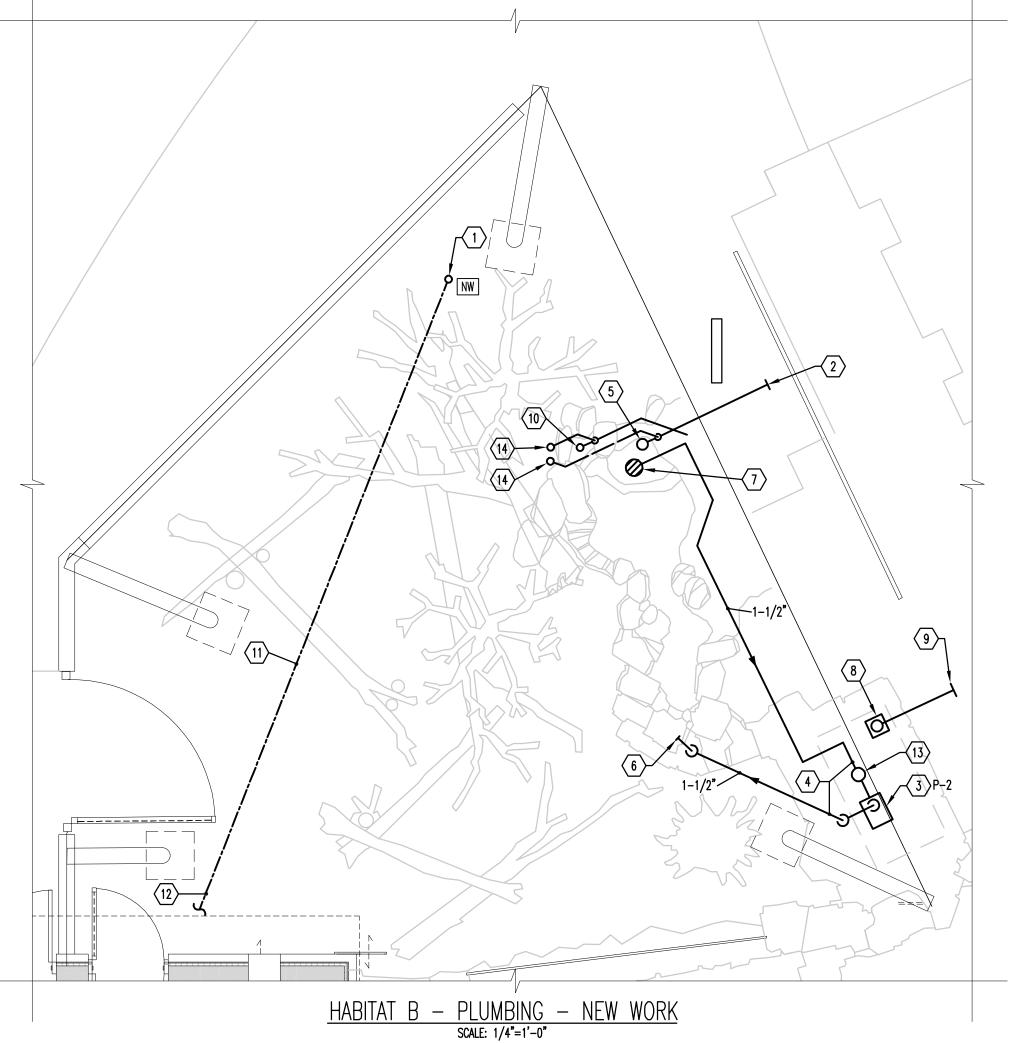
DRAWING TITLE:
HOLDING BUILDING PLUMBING - NEW WORK

DRAWING NO:

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P-101





DRAWING NOTES:

- ANIMAL WATERER IN HABITAT. PROVIDE 1/2"CW TO THIS POINT AND INSTALL WATERER PER MANUFACTURER'S RECOMMENDATIONS. REFER TO DETAIL. COORDINATE WITH ELECTRICAL DIVISION TO PROVIDE POWER TO HEATER.
- $\fbox{2}$ New sanitary from Habitat pond bottom drain and overflow. Refer to civil drawings for continuation.
- PROVIDE RECIRCULATING PUMP FOR POND IN ACCESS CAVITY IN FAUX ROCKS. REFER TO HABITAT POND PUMP DETAIL ON SHEET P-501.
- PROVIDE 1-1/2"PVC BELOW GRADE FOR POND RECIRCULATION SUPPLY AND RETURN.
- PROVIDE 3" FITTING CLEANOUT ADAPTER FOR DRAINING HABITAT POND.
 PROVIDE 3" CLEANOUT PLUG WITH 0-RING. COORDINATE WITH CIVIL
 DIVISION FOR CONNECTION TO SANITARY MAIN.
- 6 connect 1-1/2" pond pump supply to stilling box.
- 7 PROVIDE VGBA TESTED AND CERTIFIED POOL DRAIN WITH SUMP. CMP GALAXY POOL DRAIN OR EQUAL. COLOR BLACK.
- (8) PROVIDE 3" FLOOR DRAIN.
- 9 NEW 3" STORM WATER FROM FLOOR DRAIN. REFER TO CIVIL DRAWINGS FOR CONTINUATION.
- (10) 2" HABITAT POND OVERFLOW STUBBED UP AT THIS LOCATION.
- 11 1/2"CW UNDERGROUND TO HABITAT WATERER LOCATION.
- REFER TO HOLDING BUILDING PLUMBING PLAN ON SHEET P-101 FOR CONTINUATION.
- (13) BASKET STRAINER.
- STUB 1-1/2" VENT PIPE 12" ABOVE GRADE. COVER VENT OPENING WITH STAINLESS STEEL BIRD SCREEN.



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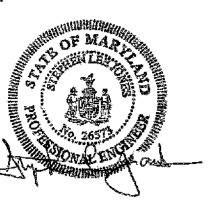
THE MARYLAND ZOO IN BALTIMORE 1 SAFARI PLACE BALTIMORE, MD 21217

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HE MARYLAND Z IN BALTIMORE 1 SAFARI PLAC LTIMORE, MD 2

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	DRAWN BY	KWA
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	Submission	DATE
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	revision	DATE
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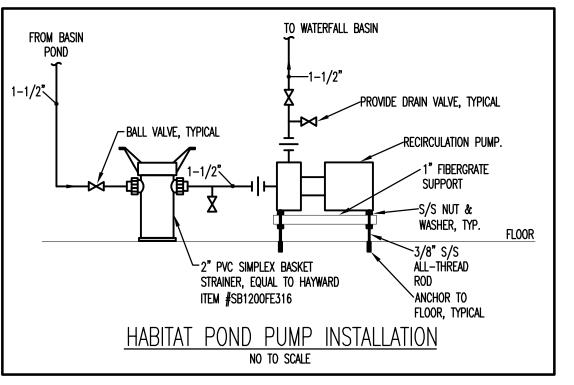
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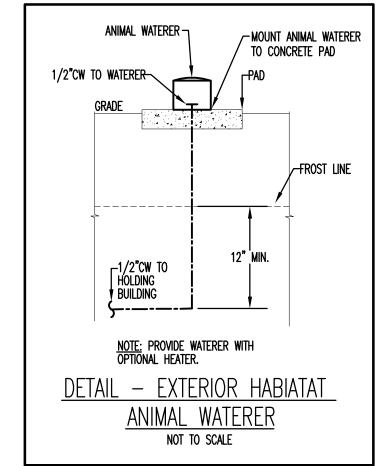
PLUMBING - NEW WORK


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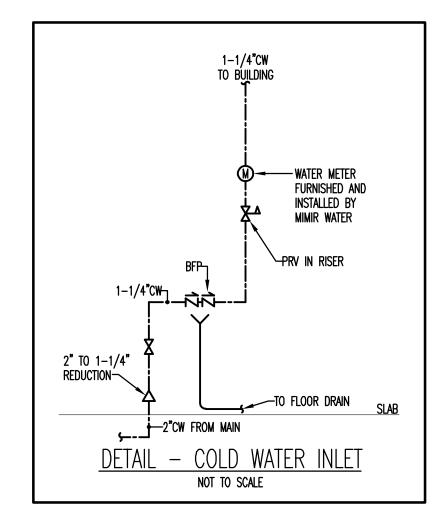
P-102


10877 - RED PANDA










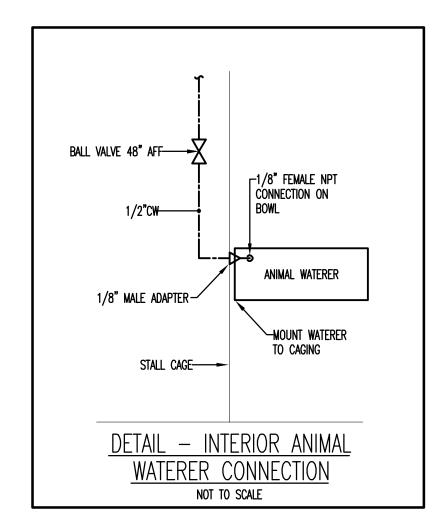

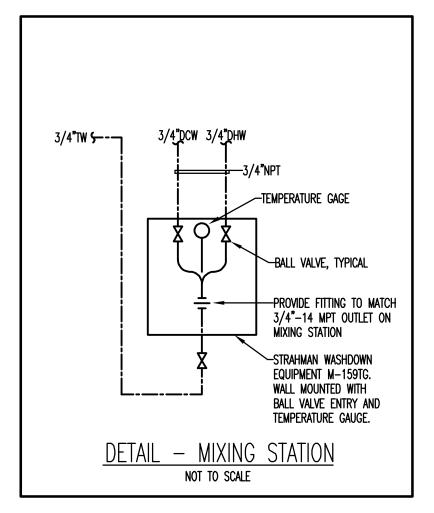

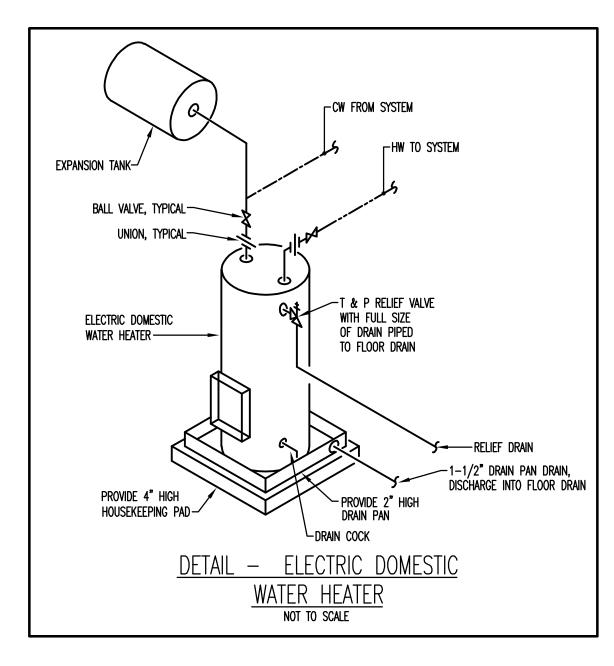

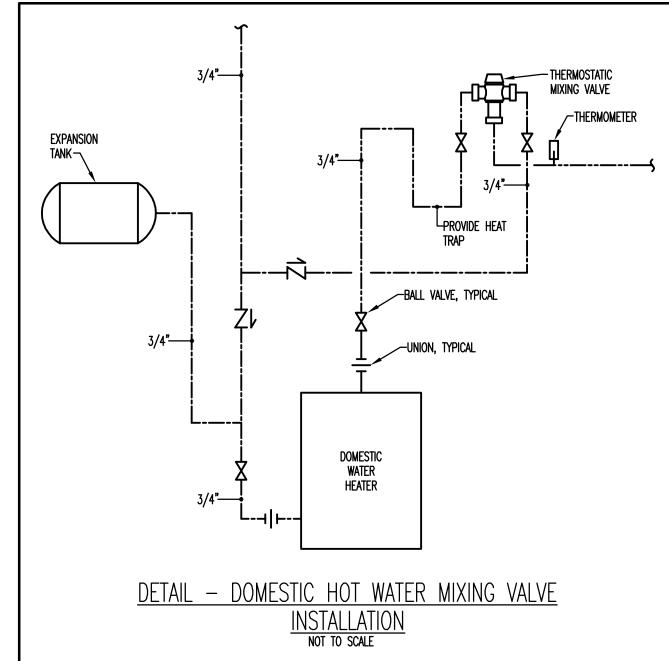

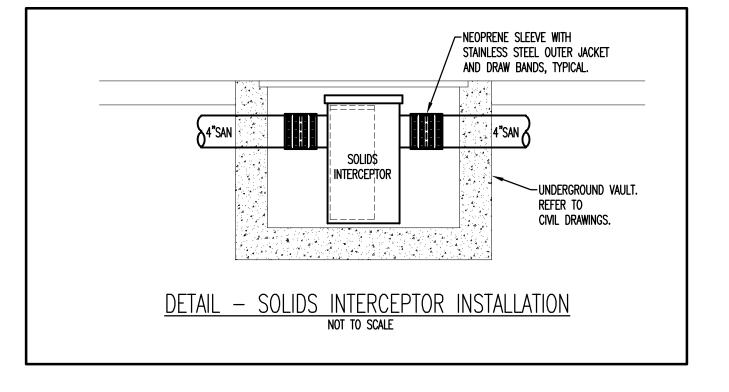



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SUBMISSION	DATE
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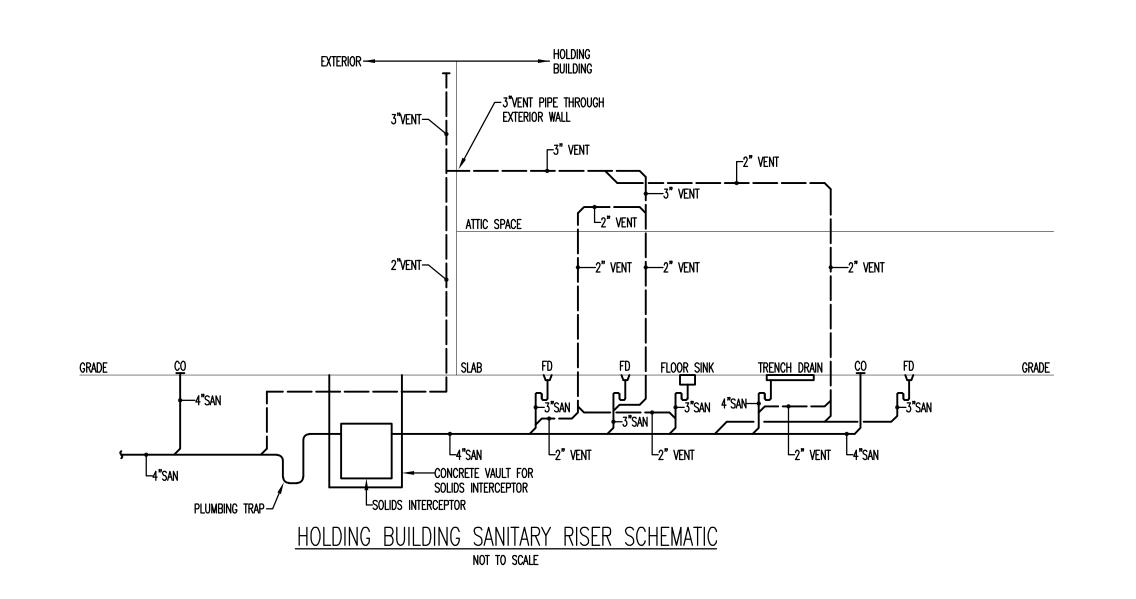
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PLUMBING DETAILS


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P-501

10877 - RED PANDA





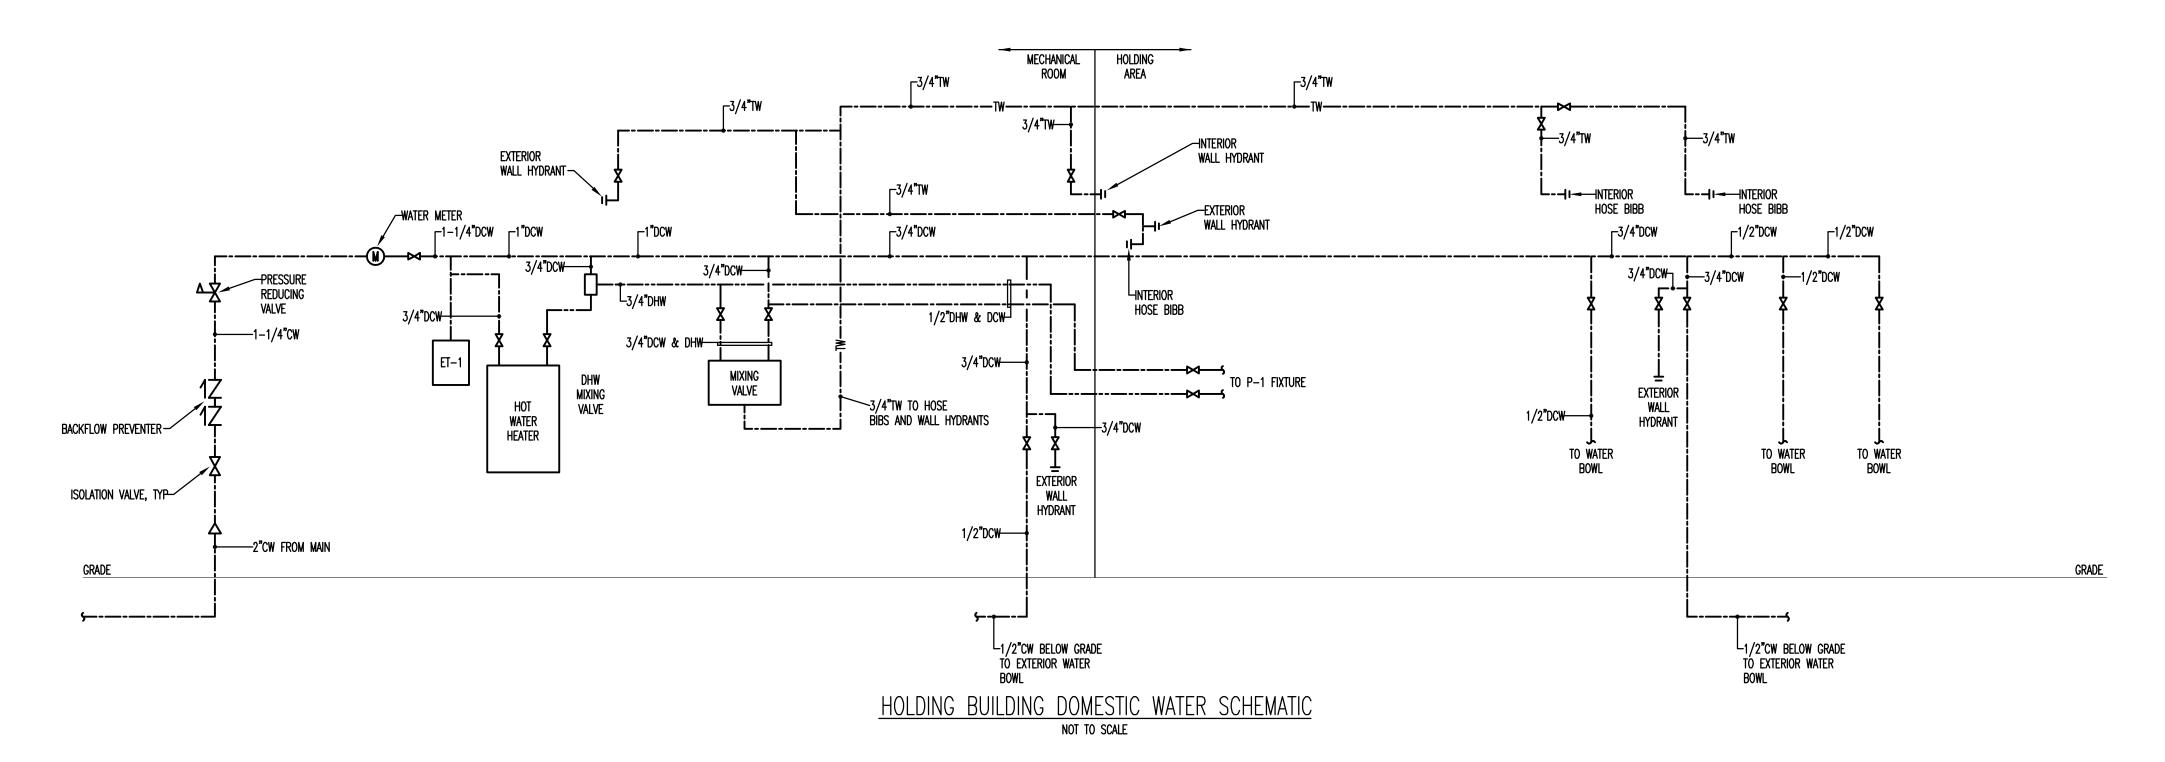

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THE MARYLAND ZOO IN BALTIMORE

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THE MARYLAND ZOC IN BALTIMORE 1 SAFARI PLACE BALTIMORE, MD 2121

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DRAWN BY	KWA
CHECKED BY	KWA
SUBMISSION	DATE
PERMIT SET	11/22/2024
revision	DATE

DRAWING TITLE:
PIPING SCHEMATICS

DRAWING NO:

P_K01

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TYPE	DESCRIPTION	MANUFACTURER	LAMPS	VOLTS	REMARKS
A	12" W X 48" L X 3-1/2"D, SLOPED SIDES, VANDAL RESISTANT, CONFINEMENT/ CORRECTIONAL SURFACE, FLUSH LENS	COOPER LIGHTING SOLUTIONS #FUSL-12-4-LD4-2LO-35-UNV-80 -84-EDD	LED 5300L 47W	120	
AE	SAME AS FIXTURE 'A' BUT CONNECTED TO EMERGENCY BATTERY PACK	COOPER LIGHTING SOLUTIONS #FUSL-12-4-LD4-2LO-35-UNV-80 -84-EDD	LED 5300L 47W	120	PROVIDE BATTERY PACK AND SELF-DIAGNOSTIC FIXTURES
В	48" LONG SUSPENDED LED LINEAR STRIP FIXTURE, STEEL HOUSING, NO DIFFUSER, WHITE FINISH	COOPER LIGHTING SOLUTIONS #4SNX-33SL-LW-UNV-L835-CD #ATC-CHAIN/SET-U, #WG-SNX/SN-4FT-B	LED 3300L 21W	120	PROVIDE WIREGUARD
BE	SAME AS FIXTURE 'B' BUT CONNECTED TO EMERGENCY BATTERY PACK	COOPER LIGHTING SOLUTIONS #4SNX-33SL-LW-UNV-L835-CD #ATC-CHAIN/SET-U, #WG-SNX/SN-4FT-B	LED 3300L 21W	120	PROVIDE BATTERY PACK AND SELF-DIAGNOSTIC FIXTURES
B1	48" LONG SURFACE MOUNTED LED LINEAR STRIP FIXTURE, STEEL HOUSING, NO DIFFUSER, WHITE FINISH, WITH INTEGRAL OCCUPANCY SENSOR	COOPER LIGHTING SOLUTIONS #4SNX-48SL-LW-UNV-L835-CD #WLS	LED 4800L 32W	120	
B1E	SAME AS FIXTURE 'B1' BUT CONNECTED TO EMERGENCY BATTERY PACK	COOPER LIGHTING SOLUTIONS #4SNX-48SL-LW-UNV-L835-CD #WLS	LED 4800L 32W	120	
B2	24" LONG SUSPENDED LED LINEAR STRIP FIXTURE, STEEL HOUSING, NO DIFFUSER, WHITE FINISH	COOPER LIGHTING SOLUTIONS #2SNX-19SL-LW-UNV-L835-CD #ATC-CHAIN/SET-U, #WG-SNX/SN-2FT-B	LED 1900L 12W	120	
С	WALL MOUNTED SEALED AND GASKETED ARCHITECTURAL FIXTURE, REGRESSED DIFFUSED LENS, ALUMINUM HOUSING BLACK FINISH	LITHONIA #ARC2LED-P4-30K-MVOLT-DBLXD	LED 4000L 30W	120	SELECTED BY ARCHITECT
CE	SAME AS FIXTURE 'C' BUT CONNECTED TO EMERGENCY BATTERY PACK	LITHONIA #ARC2LED-P4-30K-MVOLT-E4WH-DBLXD	LED 4000L 30W	120	SELECTED BY ARCHITECT COORDINATE TO PROVIDE EM BATTERY BACKUP
D	POLE MOUNTED, EXTERIOR 18" LED SHADE FIXTURE, BLACK FINISH, GOOSENECK MOUNTING OPTION	HI-LITE #H-15118-91/HL-E-91/WGR-91/ 6LED435WBCM-PHCL/BCM	LED 850L 6 W	120	PROVIDE DRIVER AND MOTION SENSOF TO REDUCE LIGHT 50% WHEN NO MO IS DETECTED. WIRE VIA TIMECLOCK WI OVERRIDE SWITCH. COORDINATE WITH MANUFACTURER 14' POLES.
F	VICTORIAN LED POST TOP FIXTURE, SYMMETRIC DISTRIBUTION, DECORATIVE ALUMINUM POLE WITH RECEPTACLE, CONTROLLED BY TIMECLOCK	HADCO #MV-G-CA-G1-350-5-730-A-SRD-R-N -SP1-BKS #2063-14-A-Z-D-M-N	LED - 42W	120	SELECTED BY ARCHITECT COORDINATE POLE AND FIXTURE WITH MANUFACTURER
G	LED STRING LIGHTS	TBD	TBD	TBD	COORDINATE WITH ARCHITECT. MINIMU SAG AT 12' ABOVE GRADE
Н	FLOOD LIGHT	ABOVE ALL #SMFL-50-1-PC-KN	LED 50W	120	CONFIRM WITH ARCHITECT
Х	EXIT SIGN, SINGLE SIDED, ALUMINUM HOUSING, GREEN LETTERING, UNIVERSAL	EMERGI-LITE #BA-P-2-G	LED 2W	120	PROVIDE BATTERY PACK AND SELF—DIAGNOSTIC FIXTURES

FLECTRICAL LEGEND

THRU ROOF CONNECTION

GROUND BAR

GROUND ROD

CORD REEL

CONCEALED: 3/4"x10' COPPER CLAD GROUND

CLASS II COPPER DOWNLEAD RUN EXPOSED AND IN CONDUIT THAT IS

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	<u>ELECTRICAL LEGENI</u>	<u>)</u>		
SYMBOL	DESCRIPTION	<u>SYMBOL</u>	<u>DESCRIPTION</u>	
	1'x4' SURFACE TROFFER	CR	ACCESS CARD READER; MH=36"AFF	
	1'x4' SURFACE TROFFER WITH EMERGENCY BATTERY PACK	KP	SECURITY KEYPAD; MH=48"AFF	
	STRIP FIXTURE		SECURITY CAMERA; CEILING MOUNT	
\longrightarrow	STRIP FIXTURE WITH EMERGENCY BATTERY PACK	@	CCTV CAMERA; CEILING/WALL MOUNT	
	LED STRING LIGHTS	(1)	FIDE ALADM CNOVE DETECTOD	
0	DECORATIVE CEILING FIXTURE	(f)	FIRE ALARM SMOKE DETECTOR	
0	RECESSED DOWNLIGHT	(D)	FIRE ALARM HEAT DETECTOR	
⊗ ♥	EXIT LIGHT WITH DIRECTIONAL ARROWS AS INDICATED; CEILING/ WALL MTD;	(B)	FIRE ALARM DUCT SMOKE DETECTOR	
	SHADED PORTION DENOTES LIGHTED FACE	<u>(4)</u>	FIRE ALARM FLAME DETECTOR	
望	EXTERIOR WALL LIGHT WITH EMERGENCY BATTERY PACK, FURNISHED BY OTHERS INSTALLED BY EC	Ē	FIRE ALARM MANUAL PULLSTATION; MH=48"AFF	
\$ _{a,b}	SINGLE POLE SWITCH; SUBSCRIPT DENOTES SWITCHING SCHEME; MH=48"AFF	⊕ 00 ≈	FIRE ALARM STROBE; MH=80"AFF	
\$ 3	THREE-WAY SWITCH; MH=48" FF	D 00	FIRE ALARM STROBE; CEILING MOUNT	
\$ D	0-10VDC DIMMER SWITCH; MH=48"AFF	⊕ [©]	FIRE ALARM AUDIO/VISUAL DEVICE; MH=80"AFF	
\$ P	SWITCH WITH PILOT LIGHT; MH=48" FF	© CD	FIRE ALARM AUDIO/VISUAL DEVICE; CEILING MOUNT	
\$ 0	WALL SENSOR SWITCH; MH=48" AFF	RTS	FIRE ALARM DUCT SMOKE DETECTOR REMOTE TEST	SWITCH
\$ T	TIMER SWITCH; MH=48" FF	Q	FIRE ALARM REMOTE INDICATOR LIGHT	
\$ _{TD}	TIMER SWITCH WITH 0-10VDC DIMMING CAPABILITY; MH=48" FF		FIRE ALARM ANNUNCIATOR	
® , ® ,	OCCUPANCY SENSOR, LOWER CASE LETTERING TO DENOTE CONTROLLED FIXTURES;		FIRE ALARM CONTROL PANEL	
_	CEILING MOUNTED	———F——	FIRE ALARM WIRING IN CONDUIT	
® <u>®</u>	PHOTOCELL SENSOR; CEILING MOUNTED		WIRE IN CONDUIT; HATCH MARKS DENOTE QUANTITY IN 3/4"C, UNLESS INDICATED OTHERWISE; ARROW D	OF #12 CONDUCTORS DENOTES HOME RUN TO
TC	TIME CLOCK		Panèl indicated	
①	BLUE FAN, FURNISHED BY OTHERS, INSTALLED BY EC PATTERSON 14" HIGH VELOCITY, 120V, 2.8A, 1HP		0-10VDC WIRING UNDERGROUND CONDUIT	
₽	DUPLEX RECEPTACLE; MH=18"AFF; UNO		NEW WORK	
#	DOUBLE DUPLEX RECEPTACLE; MH=18"AFF		EXISTING WORK TO REMAIN	
$\square \bigcirc \underline{\mathbb{Q}}$	JUNCTION BOX; CEILING/WALL MOUNTED		REMOVE EXISTING WORK	
<i>77772</i> 3	EXISTING ELECTRIC PANELBOARD		NEW UNDERGROUND FIBER OPTIC CABLE	
_	NEW ELECTRIC PANELBOARD		EXPOSED HVAC DUCT BELOW CEILING SHOWN FOR	COORDINATION
-	DISCONNECT SWITCH			
	COMBINATION STARTER			
\$ _M	MANUAL MOTOR STARTER SWITCH			
<u> </u>	VARIABLE FREQUENCY DRIVE			
	MOTOR			
Ī	TRANSFORMER			
R	RELAY IN NEMA 1 ENCLOSURE			
<u> </u>	AIR TERMINAL: 1/2"x12" GENTLY TAPERED SOLID COPPER AIR TERMINAL			
●A	WITH COPPER SADDLE BASE MOUNTED HORIZONTALLY			

VOLTAGE DROP CALCULATIONS

1. Parameters A. COMMERCIAL 75 DEGREES C B. POWER FACTOR 0.85 C. SINGLE PHASE D. 240V C. COPPER CONDUCTOR D. CONDUIT (NON STEEL)

2. VOLTAGE DROP = 2.8% IF FEEDER IS 400KCMIL SINGLE SET

LIGHTING POWER DENSITY CALCULATIONS

E. LENGTH OF RUN 343'

1. STORAGE ROOM - 0.26 W/FT² 2. KEEPING ROOM - 1..0 W/FT²

3. MECHANICAL ROOM - .69 W/FT² 4. EXTERIOR RED PANDA BUILDING WALK WAY - 0.01W/FT² 5. EXTERIOR PARK WALK WAY - 0.03W/FT²

3#6, #10GRD IN 1"C---_3#4/0, #4GRD IN 2−1/2" _3#2, #6GRD IN 1-1/2°C 60A-2P FSS-3#6, #10grd in 1"C(max total ^L Length of 4' up to SPD)———— MECHANICAL 225AF/225AT INTERLOCK (TYP) NEW PANEL RDP EX NEW —NEW TAP BOX/MTS PANEL MDP PANEL service rated RPS UTILITY SERVICE TO TEMP. GEN. 225A MCB 100A 3#350KCMIL, #4GRD IN 4"C¬ MCB MCB FROM BGE LEX BGE TRANSFORMER LEX FUSED DISCONNECT 800A, 1PH, 120/240V

<u>RED PANDA — ELECTRICAL RISER DIAGRAM</u>

GENERAL NOTES:

1. USE MINIMUM OF 3/4" DIAMETER EMT FOR POWER CIRCUIT.

2. REFER TO ARCHITECTURAL REFLECTED CELING PLANS FOR EXACT LOCATIONS

OF LUMINAIRES.

3. ARC FLASH STUDY IS INCLUDED IN THIS PROJECT, AS REQUIRED BY CODE.

4. EMERGENCY AND EXIT LIGHTS SHALL BE PROVIDED WITH EMERGENCY BATTERY PACKS.

5. Luminaires with "e" next to fixture type per schedule are designated as emergency.

6. ALL LUMINAIRES SHALL BE ACCREDITED BY DESIGN LIGHTS CONSORTIUM.

7. PROVIDE DIVIDERS BETWEEN 120V AND TELECOM CABLES IN WIREMOLD.

8. EXIT LIGHTS SHALL BE WIRED AHEAD OF SWITCHING.

9. PROVIDE DIVIDERS BETWEEN NORMAL AND EMERGENCY CIRCUITS WITHIN PULLBOXES CONTAINING BOTH SYSTEMS.

10. FIRE ALARM VENDOR SHALL SUBMIT DETAILED NOTIFICATION DEVICE LOCATIONS FOR APPROVAL. SEPARATE PERMIT REQUIRED FOR ALTERATION OF FIRE ALARM SYSTEM. A SEPARATE SHOP DRAWING SUBMITTAL, REVIEW AND PERMIT IS REQUIRED FOR FIRE ALARM SYSTEM.

18

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CLIENT:

THE MARYLAND ZOO IN BALTIMORE 1 SAFARI PLACE BALTIMORE, MD 21217

RED PANDA

THE MARYLAND ZOO
IN BALTIMORE
1 SAFARI PLACE
BALTIMORE, MD 21217

BAL

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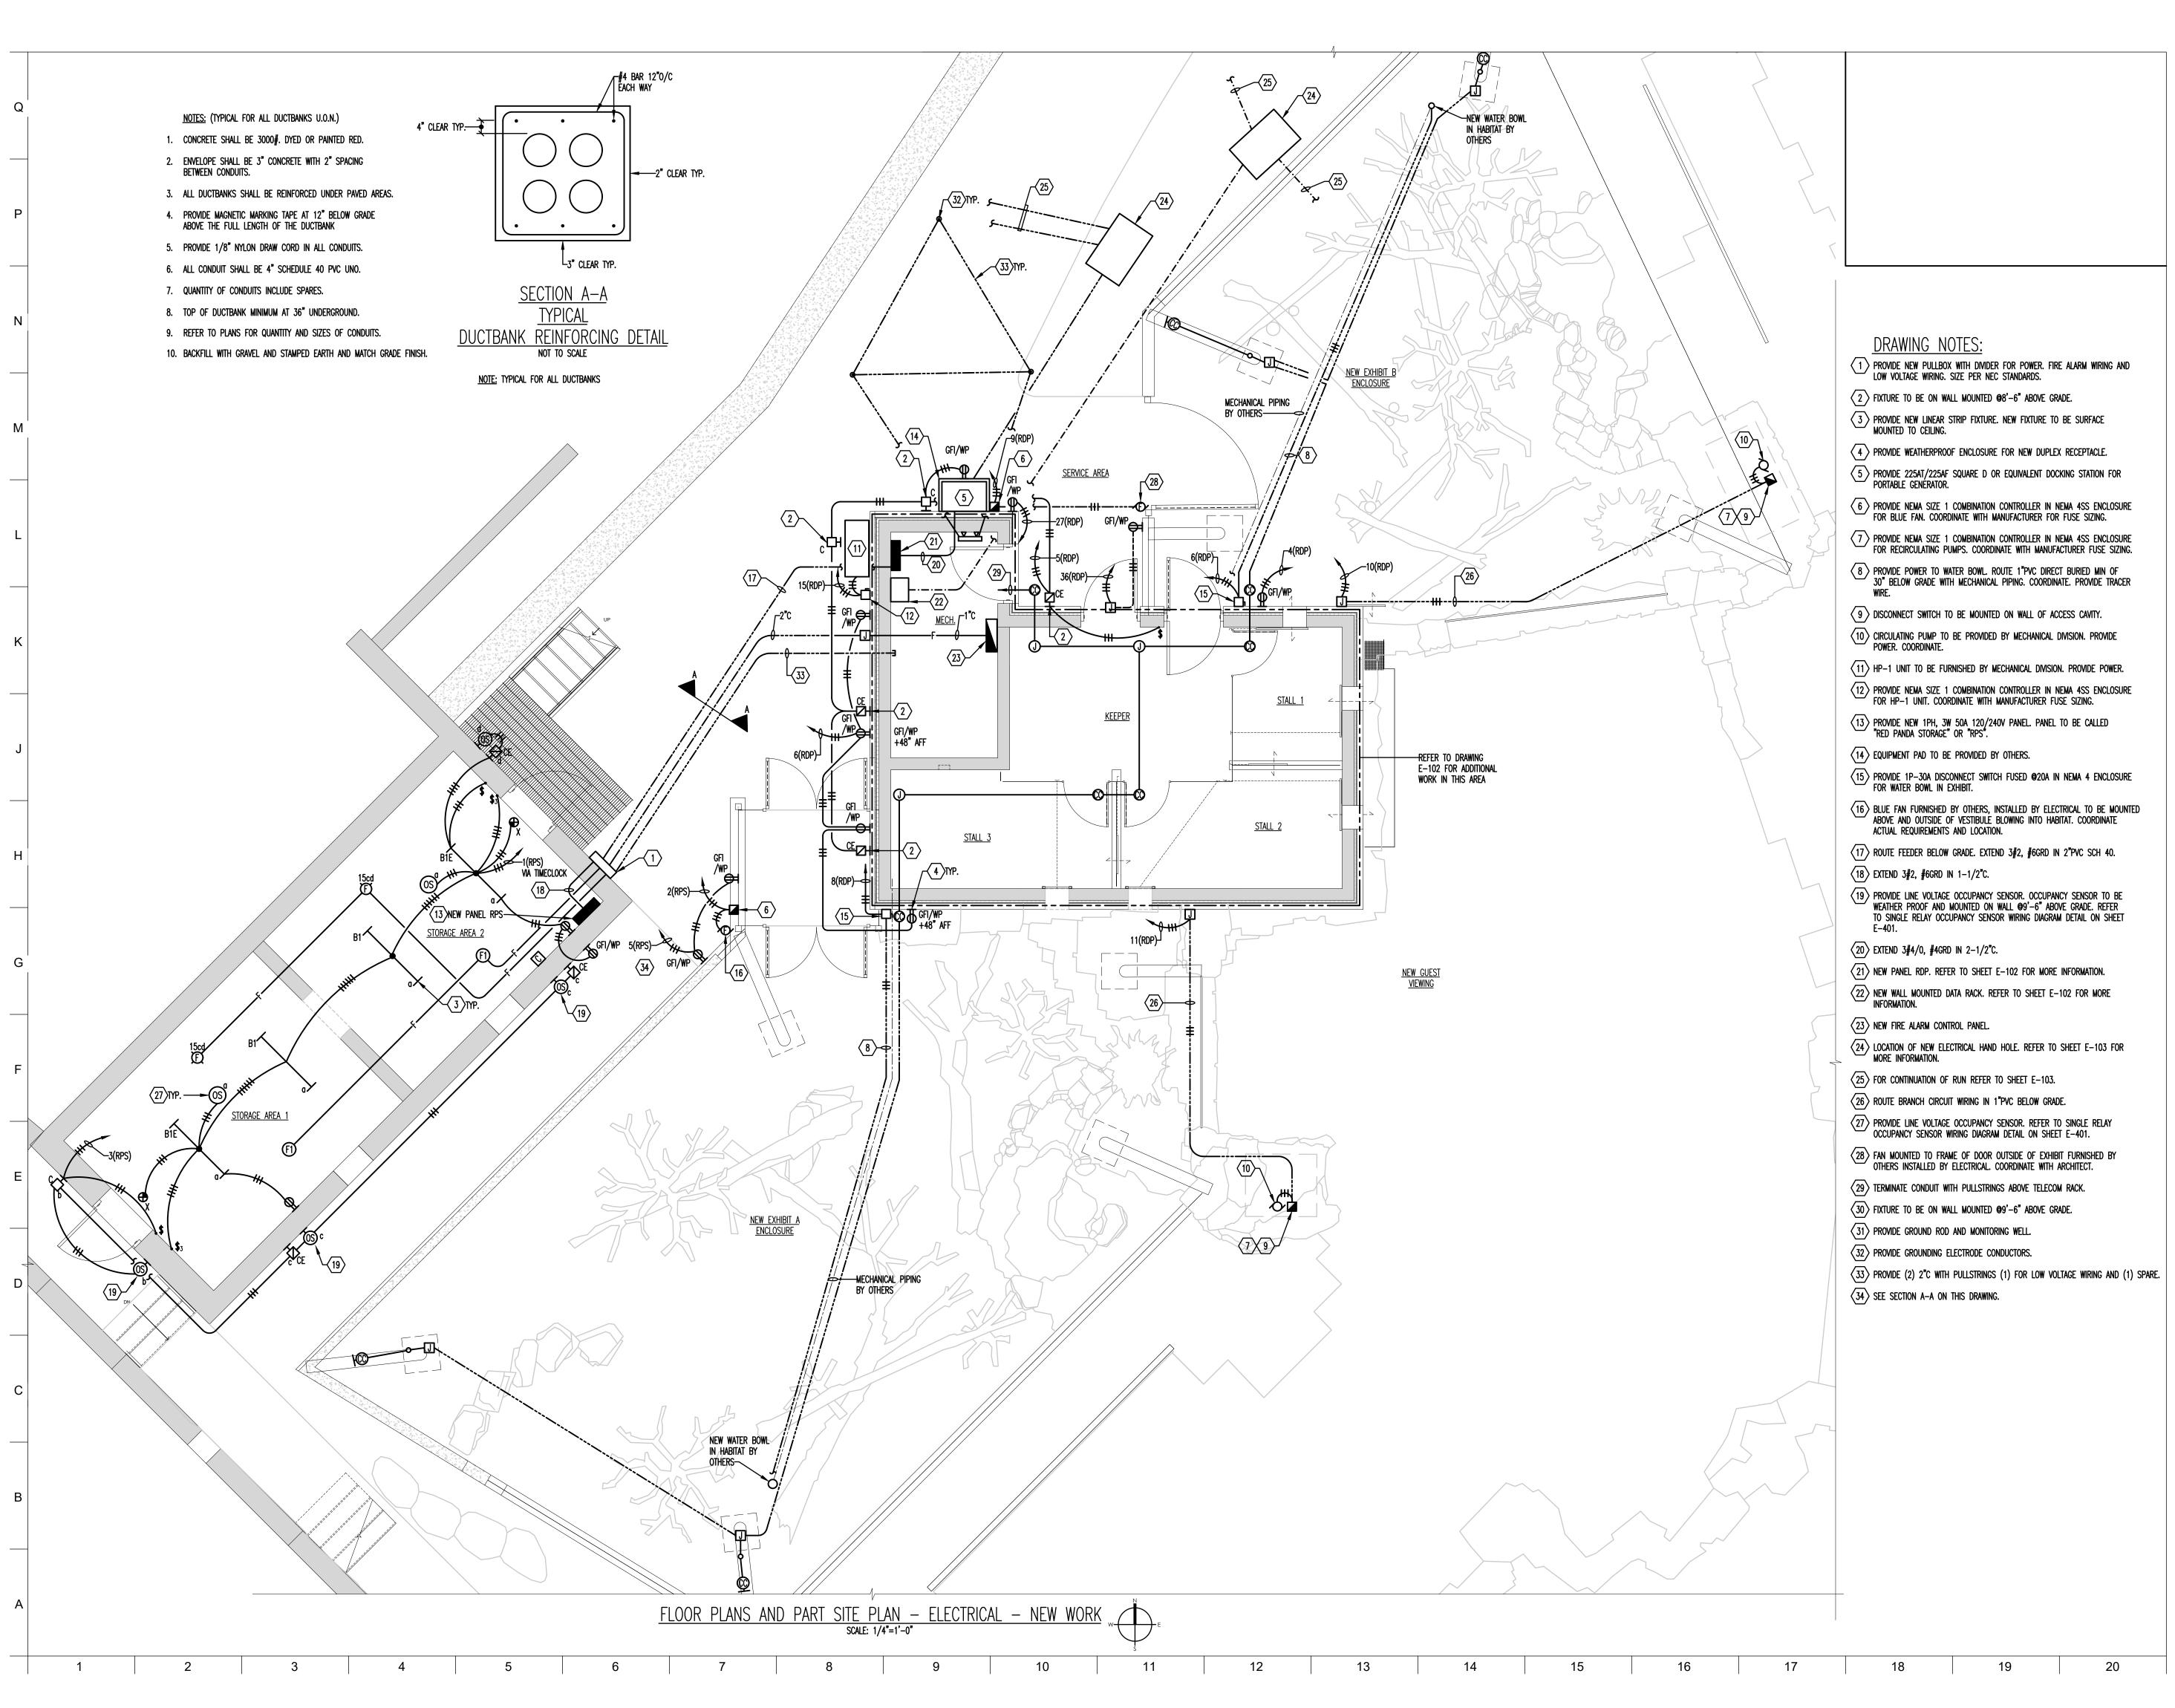


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PROJECT NO: 2023	3-10.04
DRAWN BY	KWA
CHECKED BY	KWA
SUBMISSION	DATE
PERMIT SET	11/22/2024
	_
REVISION	DATE

DRAWING TITLE: LEGEND

DRAWING NO:

20





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MARYLAND ZQO

THE MARYLAND ZOO IN BALTIMORE 1 SAFARI PLACE BALTIMORE, MD 21217

> AARYLAND ZOO BALTIMORE AFARI PLACE

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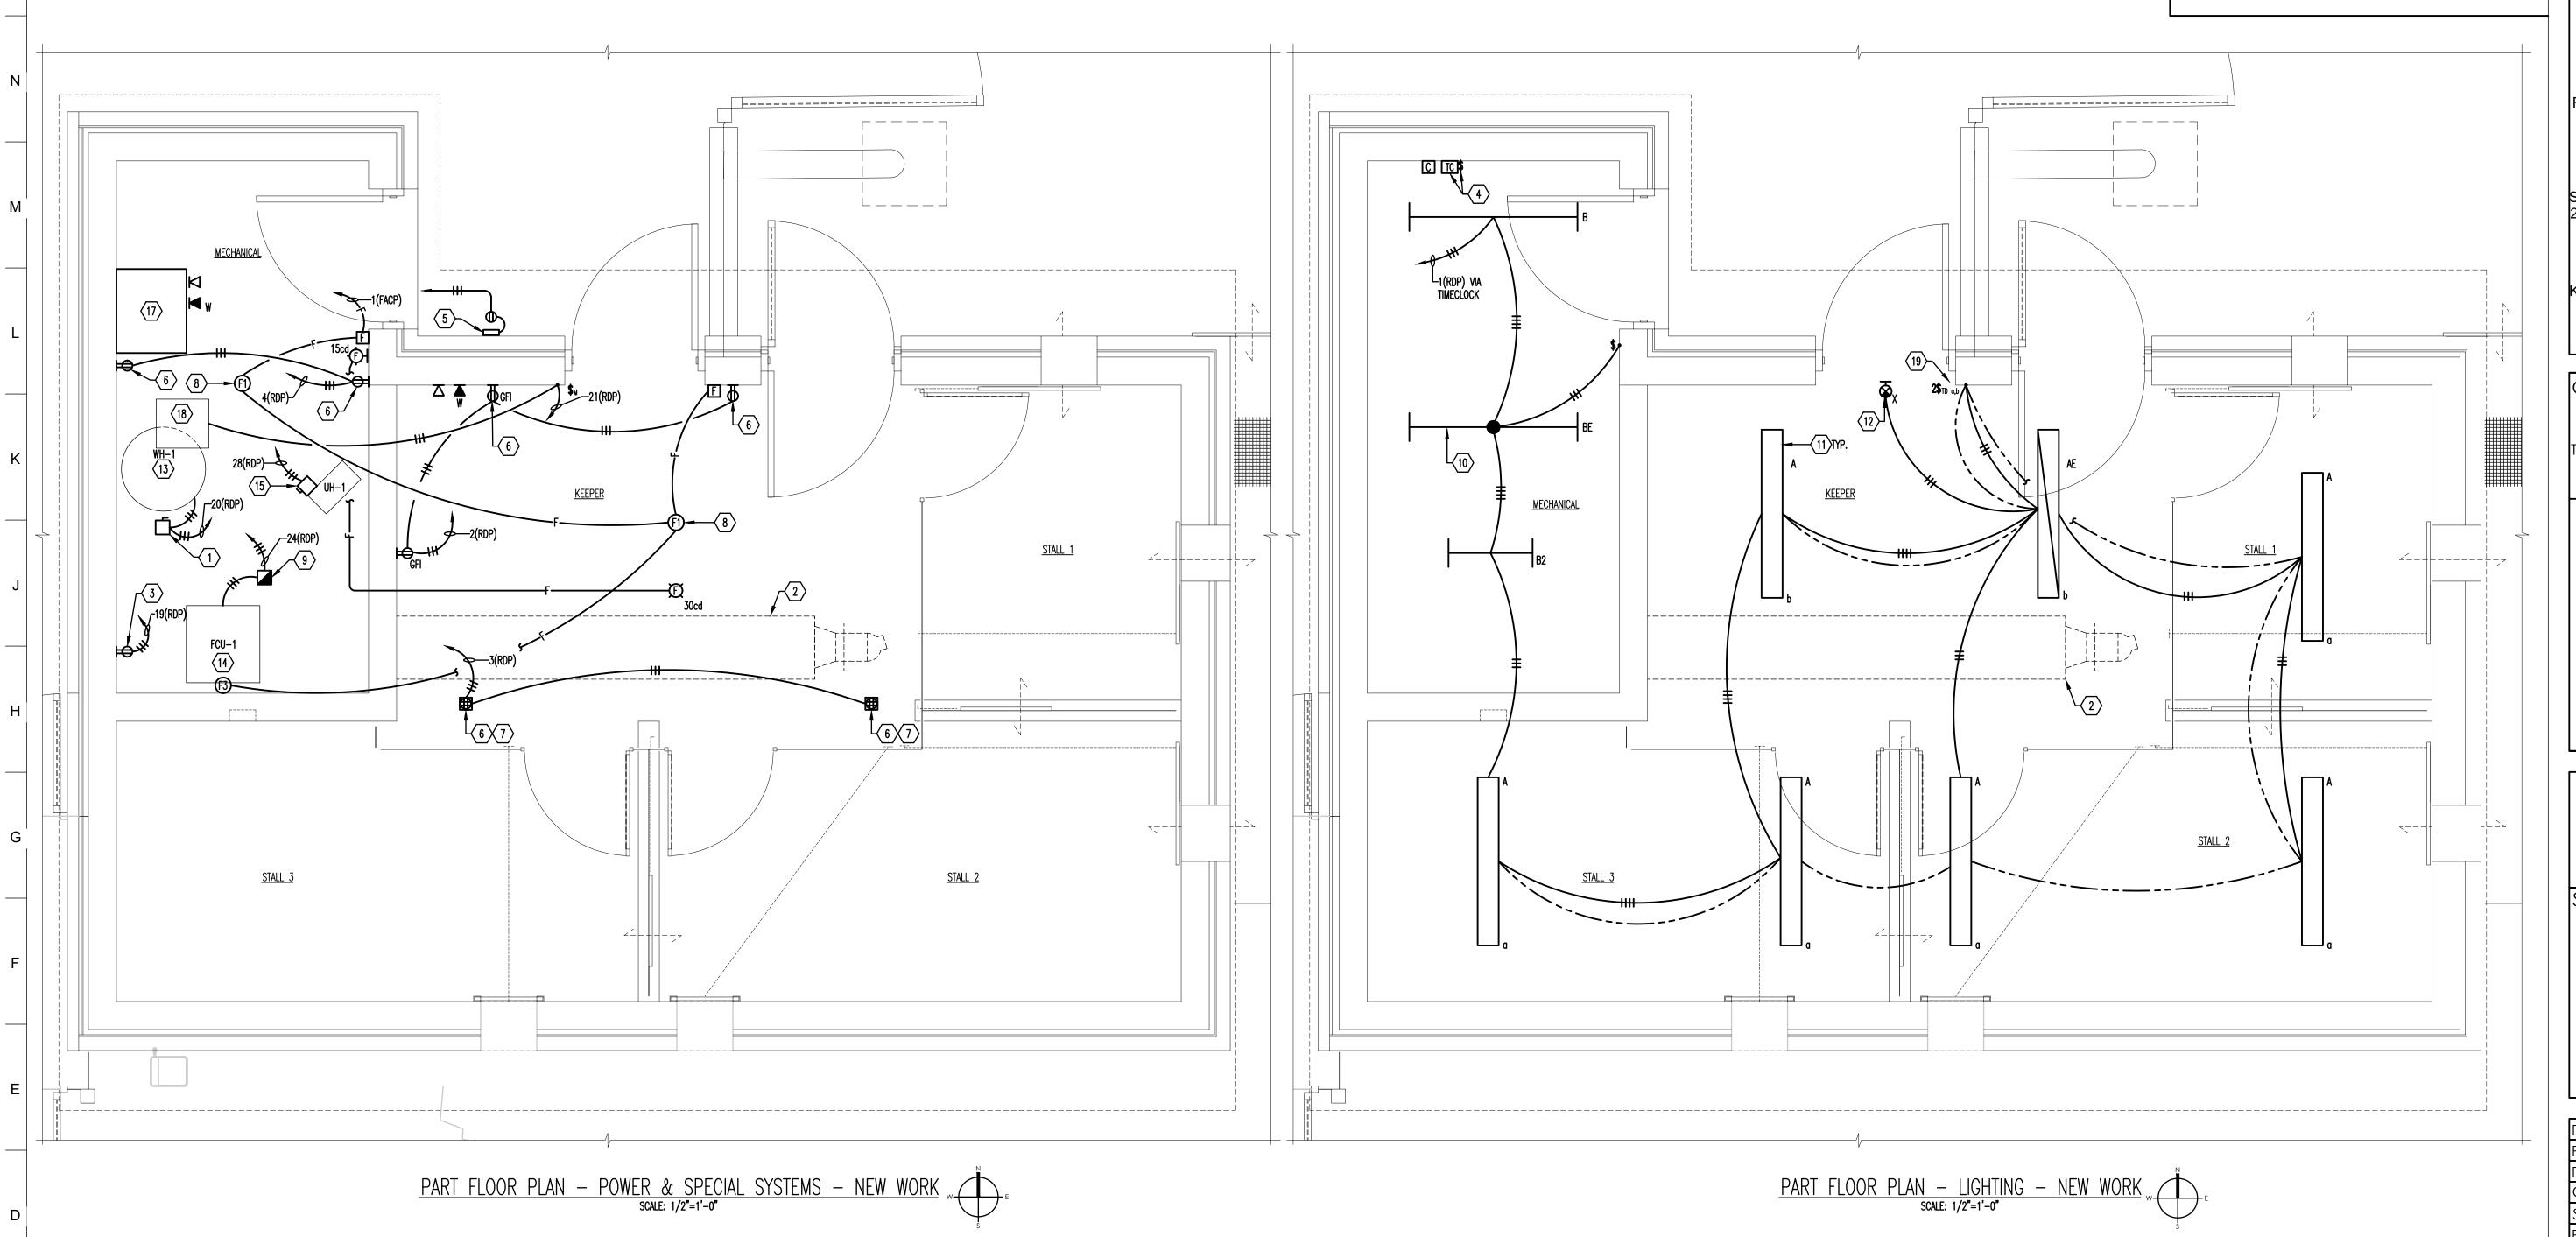


DATE: NOVEMBER 22, 2024		
PROJECT NO: 2023-10.04		
DRAWN BY KWA		
CHECKED BY	KWA	
SUBMISSION	DATE	
PERMIT SET	11/22/2024	
REVISION	DATE	

DRAWING TITLE:
PART SITE PLAN ELECTRICAL - NEW
WORK

DRAWING NO:

E-101



DRAWING NOTES:

5 PROVIDE CORD REEL.

PROVIDE 2P-30A DISCONNECT SWITCH FUSED@20A IN NEMA 1 ENCLOSURE FOR WATER HEATER.

PROVIDE DUPLEX RECEPTACLE FOR UV LIGHTS POWER SUPPLY. UV LIGHTS AND ACCESSORIES TO BE PROVIDED BY MECHANICAL.

PROVIDE PROGRAMMABLE ASTRONOMIC TIMECLOCK TO CONTROL HOLDING BUILDING INTERIOR LIGHTS, EXTERIOR LIGHTS, STORAGE BUILDING EXTERIOR LIGHTS AND POLE LIGHTS. PROVIDE OVERRIDE SWITCH.

6 PROVIDE UL LISTED "WHILE IN USE" COVER FOR NEW DUPLEX RECEPTACLE.

PROVIDE NEMA SIZE 1 COMBINATION CONTROLLER IN NEMA 1 ENCLOSURE FOR FCU-1 (31.5A MCA, 35A MOCP, 1-PHASE, 230V). COORDINATE WITH

MANUFACTURER FOR FUSE SIZING. MOUNT ON STRUT RIGIDLY SUPPORTED

7 NEW RECEPTACLE TO BE RECESSED IN CEILING.

8 PROVIDE CEILING MOUNTED SMOKE DETECTOR.

2 MECHANICAL DUCT SHOWN FOR COORDINATION PURPOSES ONLY.

 $\langle 10 \rangle$ lighting fixtures to be chain suspended from Deck 10'-0" AFF.

PROVIDE NEW EXIT SIGN. EXIT SIGN TO BE MOUNTED ON WALL ABOVE DOOR.

(13) WATER HEATER TO BE FURNISHED BY MECHANICAL DIVISION. PROVIDE POWER.

PROVIDE 2P-30A DISCONNECT SWITCH FUSED@20A IN NEMA 1 ENCLOSURE RIGIDLY SUPPORTED FROM CEILING FOR UNIT HEATER (3KW, 240V, 1-PHASE).

PROVIDE WALL MOUNTED RACK FOR CCTV AND TELECOM HEAD END EQUIPMENT. COORDINATE ACTUAL REQUIREMENTS.

EXHAUST FAN, EF-1, TO BE FURNISHED BY MECHANICAL DIVISION. PROVIDE POWER. COORDINATE.

FCU-1 TO BE FURNISHED BY MECHANICAL DIVISION. PROVIDE POWER. COORDINATE.

11) LIGHT FIXTURE TO BE SURFACE MOUNTED TO CEILING.

16 PROVIDE CEILING MOUNTED CCTV CAMERA.

PROVIDE NEW LIGHT SWITCH. LIGHT SWITCH TO TURN FIXTURES ON 50% BRIGHTNESS.

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THE MARYLAND ZOO IN BALTIMORE 1 SAFARI PLACE BALTIMORE, MD 21217

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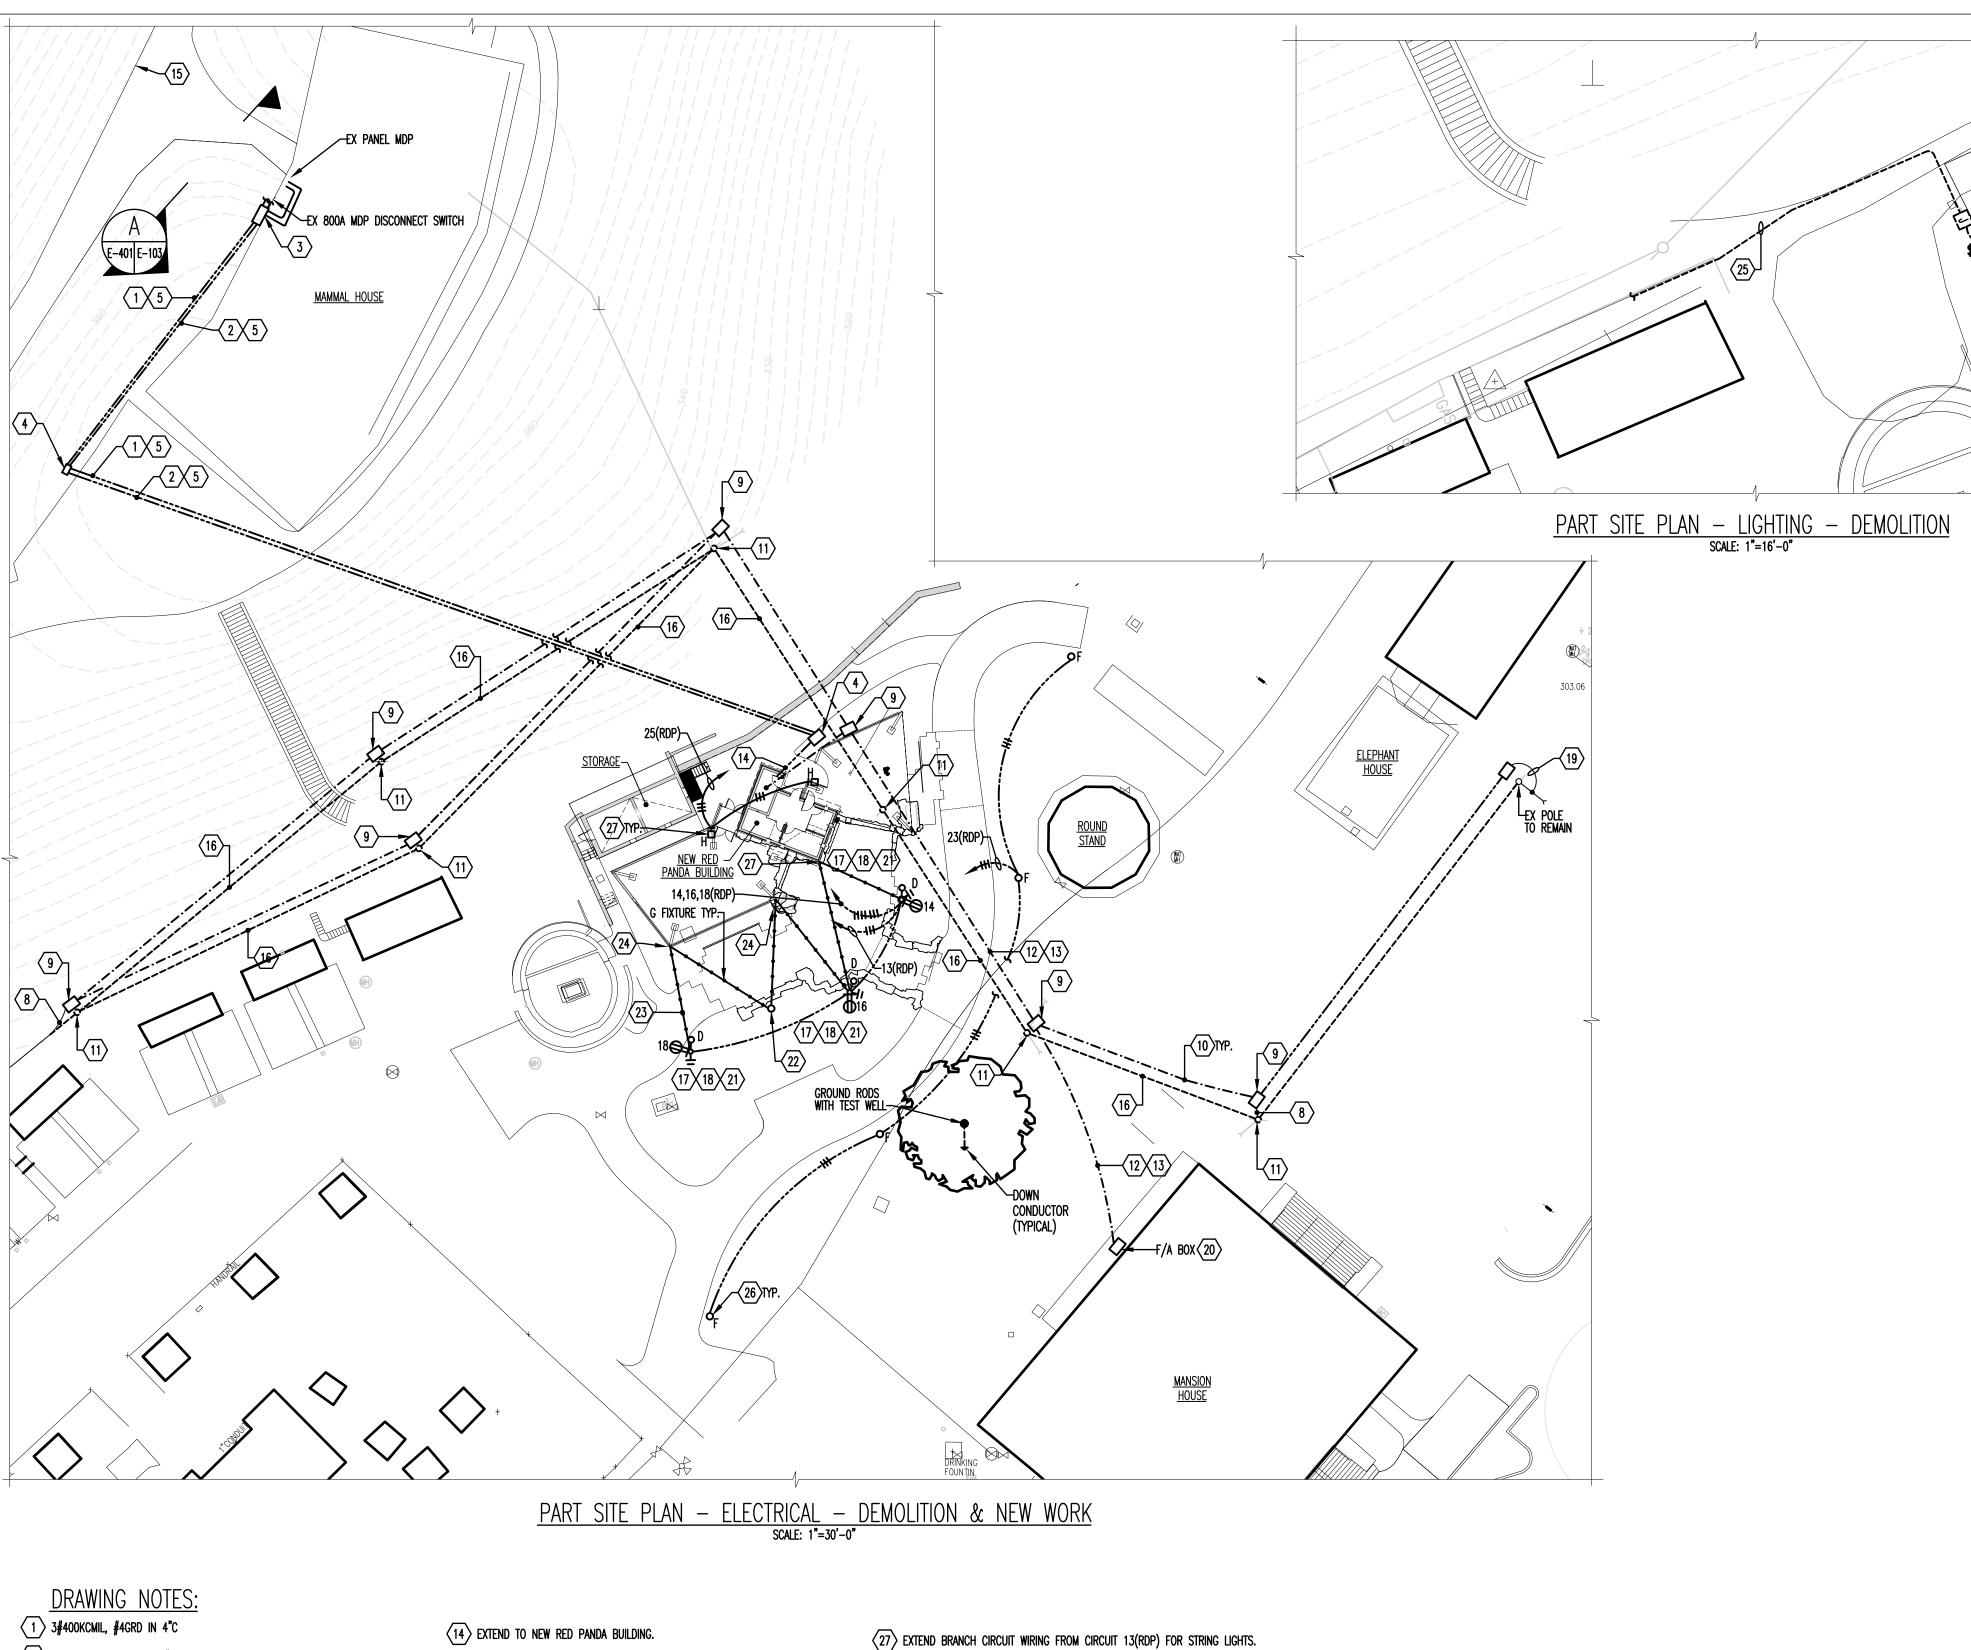
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DATE: NOVEMBER	22, 2024
PROJECT NO: 2020	3-10.04
DRAWN BY	KWA
CHECKED BY	KWA
SUBMISSION	DATE
PERMIT SET	11/22/2024
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PART FLOOR PLAN -LIGHTING & POWER & SPECIAL SYSTEMS -NEW WORK

DRAWING NO:

20

DRAWING TITLE:



 $\langle 28 \rangle$ provide external occupancy sensor for pole light fixtures.

MOUNT ABOVE SERVICE DOOR WITH BLUE FAN. COORDINATE WITH ARCHITECT COONECT VIA TIMECLOCK WITH OVERRIDE SWITCH.

14

- $\langle 2 \rangle$ provide spare empty 4"C conduit with pullstrings for future use. 3 PROVIDE NEW PULLBOX MOUNTED TO WALL. SIZE PER NEC STANDARDS.
- 4 PROVIDE NEW UNDERGROUND PULLBOX. SIZE PER NEC STANDARDS.
- 5 CONTRACTOR TO DIRECT BORE NEW UNDERGROUND CONDUIT PATH.
- 6 PROVIDE 3P-60A, F@50A, 600VAC DISCONNECT SWITCH IN NEMA 4SS ENCLOSURE.
- 7 PROVIDE 3P-400A, F@225A, 600VAC DISCONNECT SWITCH IN NEMA 4SS ENCLOSURE.
- PROVIDE SPLICE POINTS FOR EXISTING TELECOM WIRING TO NEW HANDHOLE BOX.
- 9 PROVIDE ELECTRIC TELECOMMUNICATIONS HANDBOX.
- PROVIDE NEW SINGLE MODE FIBER OPTIC CABLING. NEW PATHWAY TO BE DIRECT BORED MINIMUM 6'-0" DEEP. COORDINATE WITH TELECOM
- (11) REMOVE EXISTING TELECOM POLE ONCE NEW UNDERGROUND TELECOM INSTALLATION IS OPERATIONAL. COORDINATE WITH TELECOM PROVIDER. PATCH HOLE TO MATCH FINISH, COORDINATE.
- PROVIDE 24 STRANDS OF SINGLE MODE FIBER OPTIC CABLING FOR FIRE ALARM. NEW CABLING TO BE DIRECT BORED APPROXIMATELY MINIMUM OF 6'-0'' DEEP.
- PROVIDE 48 STRANDS OF SINGLE MODE FIBER OPTIC CABLING FOR SPECIAL SYSTEMS. NEW CABLING TO BE DIRECT BORED.

- 15 EX BGE TRANSFORMER.
- $\overline{16}$ remove existing overhead telecom cables and accessories.
- 17 INSTALL POLE MOUNTED LUMINAIRE. WOODEN POLE TO BE PROVIDED BY OTHERS, COORDINATE.
- 18 PROVIDE POLE MOUNTED GFI OUTLET WITH LISTED IN-USE COVER, 24" AFF.
- EX TELECOM WIRING TO REMAIN. INTERCEPT EX TELECOM WIRING TO NEW ELECTRIC HAND BOX. COORDINATE WITH TELECOM CONTRACTOR.
- 20) PROVIDE NEW PULLBOX AND PENETRATION TO MANSION HOUSE, FIRE PROOF.
- COORDINATE ACTUAL REQUIREMENTS AND LOCATION TERMINATIONS.

GRADE. REFER TO ARCHITECTURAL DRAWINGS FOR DETAILS.

- 21) PROVIDE BARE COPPER GROUND WIRE FOR GROUNDING. PROVIDE GROUND ROD.
- WOOD POST TO ANCHOR STRING LIGHTS. TO BE PROVIDED BY OTHERS. SHOWN FOR COORDINATION PURPOSES ONLY.
- 23 STRING LIGHTS TO BE PROVIDED BY OTHERS. ELECTRICAL CONTRACTOR TO PROVIDE STAINLESS STEEL ROPE ANCHORED TO WOODEN POSTS AND LIGHT POSTS. MOUNT STRING LIGHTS TO STAINLESS STEEL ROPE NOT TO SAG MORE THAN 12' ABOVE
- $\langle 24 \rangle$ string lights and stainless steel rope to be mounted to masts of exhibit a.
- 25) RX CONDUIT AND BRANCH CIRCUIT WIRING BACK TO CLOSEST JUNCTION BOX ALONG WALL
- (26) COORDINATE WITH ARCHITECT FOR FINAL LOCATION OF POLE LIGHT FIXTURE.



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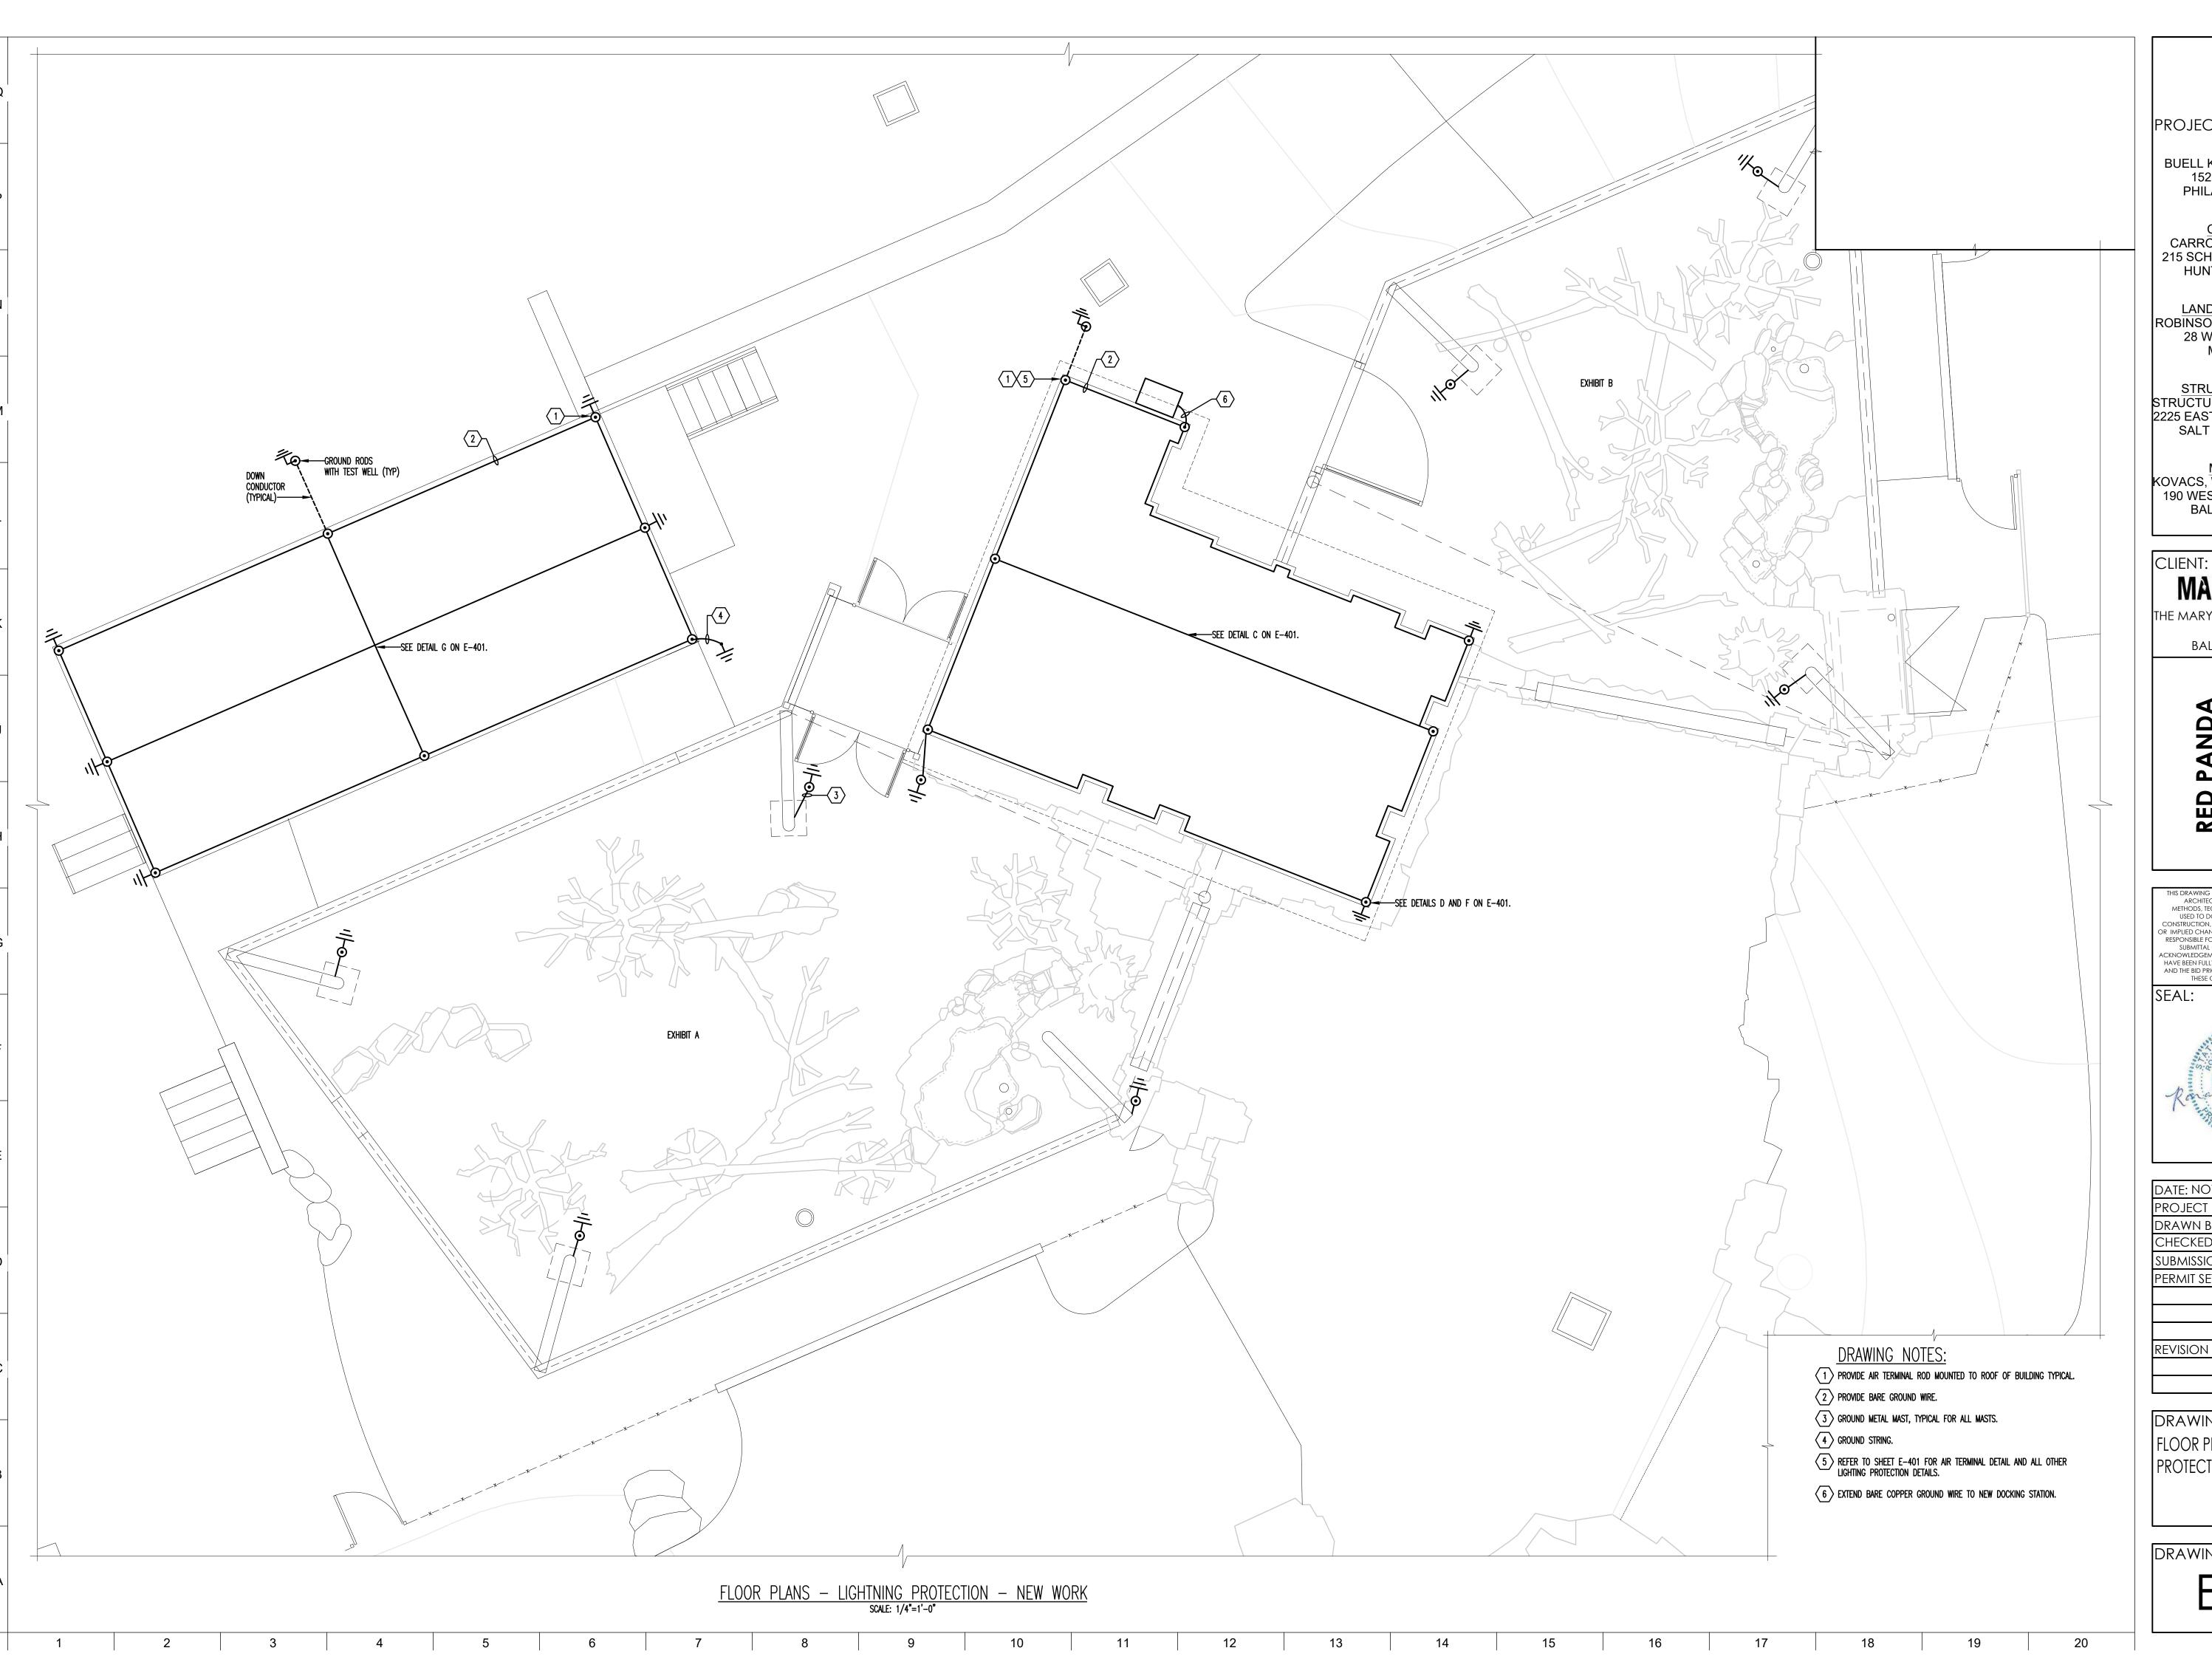


DATE: NOVEMBER	22, 2024
PROJECT NO: 2023	3-10.04
DRAWN BY	KWA
CHECKED BY	KWA
SUBMISSION	DATE
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REVISION	DATE

DRAWING TITLE: PART FLOOR PLAN -LIGHTING & POWER DEMOLITION & NEW WORK

DRAWING NO:

20



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MARYLAND ZQO


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revision	DATE	

DRAWING TITLE: FLOOR PLANS - LIGHTNING PROTECTION - NEW WORK



	SERVICE TRANSFORMER
BOND TO STEEL	SERVICE GROUNDED CONDUCTOR (NEUTRAL)
BUILDING STEEL	SERVICE GROUND
(NOTE 2)	BUILDING MAIN
	NEUTRAL BUS
WATER SERVICE (NOTE 2) A	EQUIPMENT GROUND BUS
GROUND BOND TO	BUILDING SUB-PANEL
CLAMP NEAR FOUNDATION WALL B ENCLOSURE (TYPICAL)	SOLATED NEUTRAL BUS
FOUNDATION GROUND (NOTE 1)	SOLATED GROUND-BUS (WHERE APPLICABLE)
EXOTHERMIC BOND	EQUIPMENT GROUND
GROUND ROD(S) (NOTE 3) (C) (NOTE 2)	
(NOTE 3) C (NOTE 2)	SOLATED NEUTRAL
7	J. J. ——ISOLATED GROUND (WHERE APPLICABLE)

MAIN GROUNDING ELECTRODE DETAIL

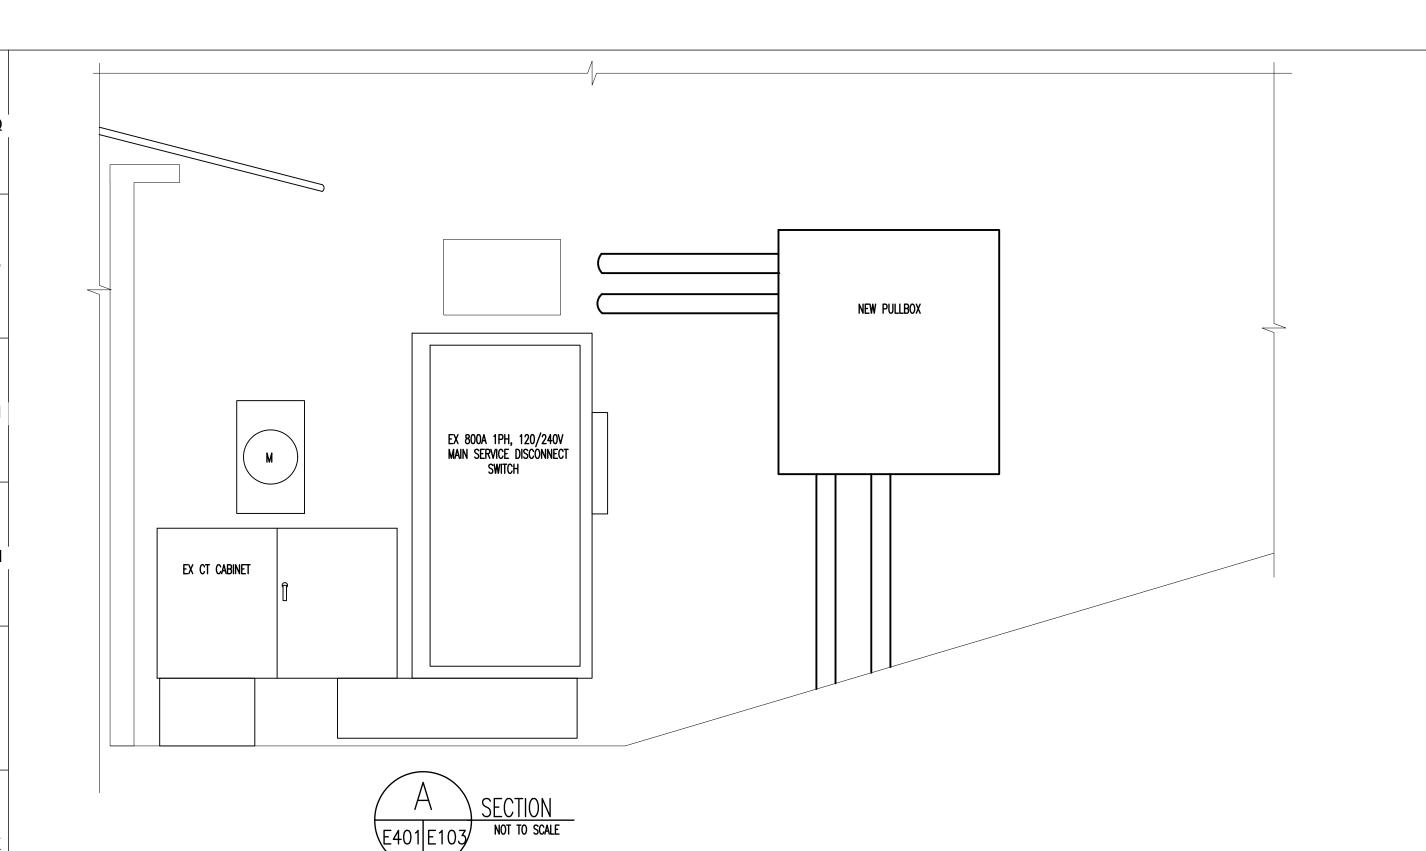GROUNDING NOTES: 1. CONCRETE ENCASED ELECTRODE (SEE DETAIL).

- 2. IF CONTINUOUS METALLIC WATER PIPE OR BUILDING STEEL IS NOT AVAILABLE THEN GROUND ROD ELECTRODE SHALL BE FULL SIZE.
- 3. ADDITIONAL RODS SHALL BE ADDED AS NEEDED FOR TOTAL RESISTANCE OF 25 OHMS OR LESS. PROVIDE GROUND WELL.

GROUND CONDUCTO	R TABLE			
SERVICE SIZE	Α	В	С	D
225	#1/0	#4	#6	#1/0
NOTES: 1. THE ABOVE CHART GIVES MINIMU	JM COPPER	GROUND S	SIZES.	

	(CONTACTO)R (CONT	ROL SCHEDU	LE	
MARK	LOAD DESCRIPTION	CIRCUITS CONTROLLED	POLES	RATING	CONTACTOR LOCATION	CONTROL	REMARKS
C1	VICTORIAN ACORN POLE LTS	23(RDP)	2	30A	NEXT TO PANEL RDP		
C2	FLOOD LIGHTS	25(RDP)	6	30A	NEXT TO PANEL RDP		
C3	POLE & STRING LTS	13(RDP)	6	30A	NEXT TO PANEL RDP		
C4	INTERIOR LIGHTS	1(RDP)	2	30A	NEXT TO PANEL RDP		
C5	STORAGE 1 AND 2	1(RPS)	2	30A	NEXT TO PANEL RPS		
C6	SPARE		_				


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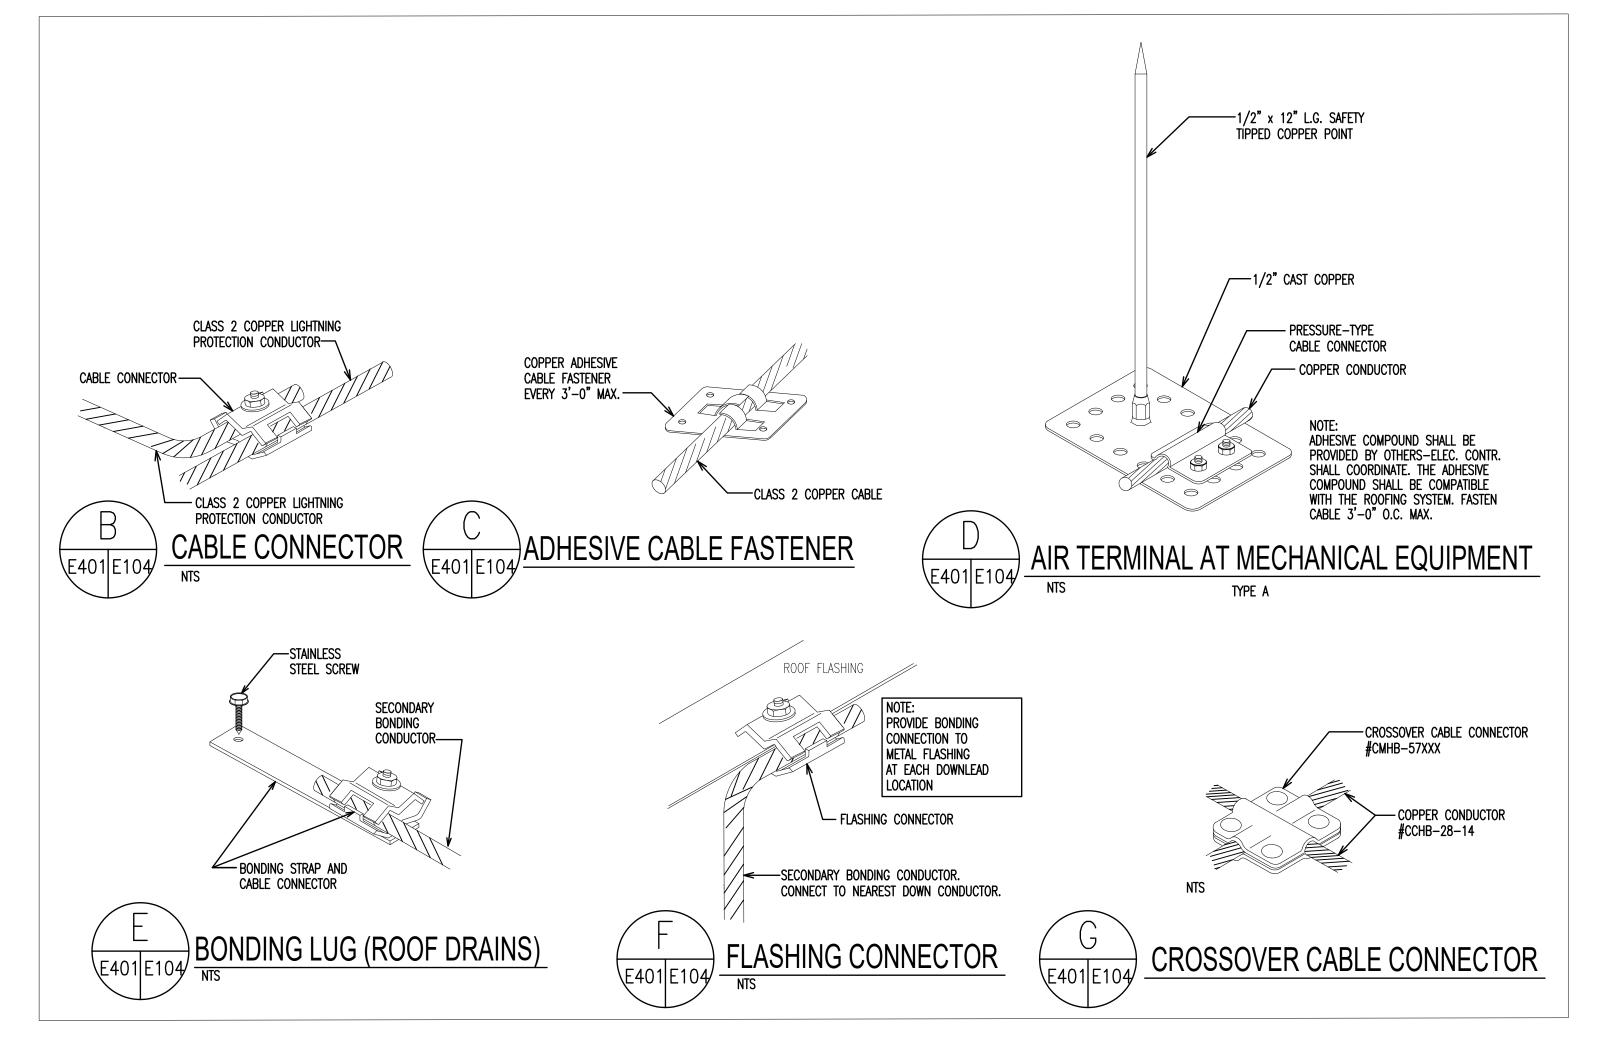
- 1. CONTACTORS TO BE MECHANICALLY HELD TYPE ASCO #917 SERIES WITH PULSE MODULE OR APPROVED EQUIVALENT. 2. CONTACTORS TO BE HOUSED IN NEMA 1 WALL MOUNTED CABINET WITH HINGED LOUVERED DOOR. LOCATE CABINET
- ADJACENT TO LIGHTING PANEL. 3. PROVIDE 277 VOLT COIL POWER.
- 4. PROVIDE PROGRAMMABLE TIME CLOCK CONTROLLER (SEE DIAGRAM).

	PROGRAMMABLE	TIME CLOCK SCHEDULE
ZONE	DESCRIPTION	CONTROL
1	VICTORIAN ACORN POLE LTS	TIME CLOCK ON/OFF
2	FLOOD LIGHTS	TIME CLOCK ON/OFF
3	POLE & STRING LTS	TIME CLOCK ON/OFF
4	INTERIOR LIGHTS	TIME CLOCK ON/OFF
5	STORAGE 1 AND 2	TIME CLOCK ON/OFF
6	SPARE	
NOTES:		

1. THE CLOCK SHALL HAVE THE FOLLOWING FEATURES: MEMORY BATTERY BACK-UP, 4 INDEPENDENT ON/OFF CHANNEL CONTROLS (ZONES), TIME OF DAY/365 DAY CALENDAR W/HOLIDAY PROGRAMMING, AUTOMATIC LEAP YEAR CORRECTION, AND PHOTOCELL INPUT FOR DUSK ON/

2. THE CONTRACTOR SHALL COORDINATE AND SET INITIAL CHANNEL CONTROL SETTINGS AS DIRECTED BY THE OWNER.



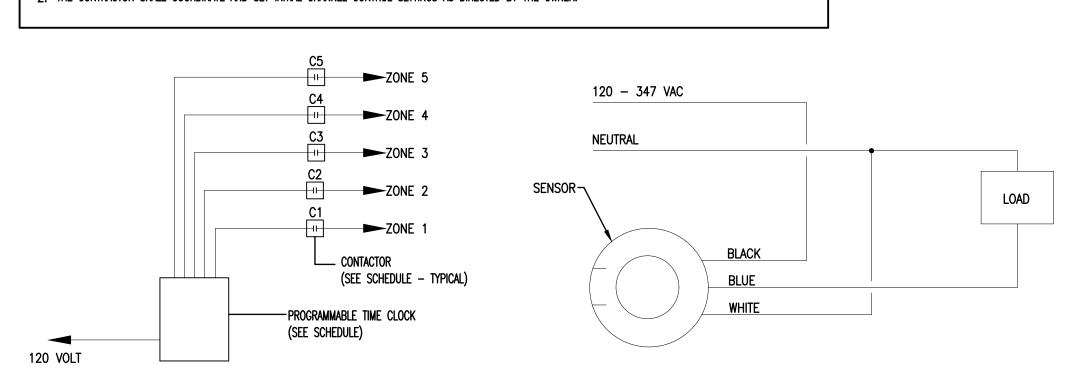

LIGHTNING PROTECTION DETAILS



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RED PANDA

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ALTIMORE, MD 2121

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SEAL:



ı		
	DATE: NOVEMBER 22,	2024
	PROJECT NO: 2023-10	0.04
	DRAWN BY	KWA
	CHECKED BY	KWA
	SUBMISSION	DATE
	PERMIT SET	11/22/2024
	REVISION	DATE

DRAWING TITLE: **DETAILS**

DRAWING NO:

LIGHTING CONTROL DIAGRAM FOR NEW LIGHTING SINGLE RELAY OCCUPANCY SENSOR WIRING DIAGRAM DETAIL

14

18

20

VOLTA	GE: 120	/ 240	BUS	800			MOU	NTING:	SURFAC	E			MANUF	: SQUARE D	
PHASE	: 1		MAIN	MLO			LOC	ATION:	MAMMA	L BUILD	ING		A.		
WIRE:	3						FEED	FROM:	INCOMIN	IG SERIO	CE (3P-8)	OOA D SV	/ITCH) TYPE	HCM	'
AIC:	65,000												100		
CVT	DESCE	UDTION	BRE	AKER	LC	DAD	NO	rre	LO	AD	BRE	AKER	DE	CODIDTION	CV
CKT	DESCR	RIPTION	POLE	TRIP	KVA	PHASE	NOT	ES	PHASE	KVA	TRIP	POLE	DE	SCRIPTION	CK
1	EX CIRCUIT		2	50	EX	Α			Α	EX	60	2	EX PANEL		2
3						В			В						4
5	EX CIRCUIT		2	50	EX	С			С	EX	40	2	PANEL ALARM	1	6
7						Α			Α						8
9	EX CIRCUIT		2	50	EX	В		1	В			1	EQUIPPED SP	ACE	10
11						С			С			1	EQUIPPED SP	ACE	12
13	EQUIPPED SPACE	3	1			А			Α			1	EQUIPPED SP	ACE	14
15	EQUIPPED SPACE	Ξ	1			В			В			1	EQUIPPED SP	ACE	16
17	EQUIPPED SPACE	Ē	1			С			С			1	EQUIPPED SP	ACE	18
19	EQUIPPED SPACE		1	3		Α	2		Α			1	EQUIPPED SP	ACE	20
21	EQUIPPED SPACE		1			В			В			1	EQUIPPED SP	ACE	22
23	EQUIPPED SPACE)	1			С			С			1	EQUIPPED SP	ACE	24
25	EQUIPPED SPACE		1			Α			А			1	EQUIPPED SP	ACE	26
27	EQUIPPED SPACE	=	1			В			В	0	100	2	SPARE		28
29	EQUIPPED SPACE		1			С			С			M3			30
31	EQUIPPED SPACE	3	1			Α		8	А	EX	100	2	BOILER ROOM	/ PANEL	32
33	EQUIPPED SPACE		1			В			В						34
35	EQUIPPED SPACE	3	1			С			С	0	100	2	SPARE		36
37	EQUIPPED SPACE		1			А			A						38
39	EX CIRCUIT		2	40	EX	В			В	0	225	2	EX UPPER PA	NEL	40

		7	÷	7	RE	VISE	D PA	NEL M	OP SCH	HEDL	JLE		Ai i	- 13
VOLTA	GE:	120 /	240	BUS:	800			MOUNTIN	G: SURFAC	E			MANUF: SQUARE D	
PHASE	:	1		MAIN:	MLO			LOCATIO	N: MAMMA	L BUILD	ING			
WIRE:		3						FEED FRO	M: INCOMIN	NG SERI	CE (3P-8	OOA D SV	VITCH) TYPE: HCM	
AIC:		65,000												
CKT		DESCRIP*	LION	BREA	AKER	LC	DAD	NOTES	LO	AD	BRE	AKER	DESCRIPTION	СКТ
CKI		DESCRIP	ION	POLE	TRIP	KVA	PHASE	NOTES	PHASE	KVA	TRIP	POLE	DESCRIPTION	CKI
1	EX CIR	CUIT		2	50	EX	Α		Α	EX	60	2	EX PANEL	2
3							В		В					4
5	EX CIR	CUIT		2	50	EX	С		С	EX	40	2	PANEL ALARM	6
7							А		Α					8
9	EX CIR	CUIT		2	50	EX	В		В		225	2	RED PANDA PANEL	10
11							С		С					12
13	EQUIPF	PED SPACE		1			А		А			1	EQUIPPED SPACE	14
15	EQUIPF	PED SPACE		1			В		В			1	EQUIPPED SPACE	16
17	EQUIPF	PED SPACE		1			С		С			1	EQUIPPED SPACE	18
19	EQUIPF	PED SPACE		1			А		Α			1	EQUIPPED SPACE	20
21	EQUIPF	PED SPACE		1			В		В			1	EQUIPPED SPACE	22
23	EQUIPF	PED SPACE		1			С		С			1	EQUIPPED SPACE	24
25	EQUIPF	PED SPACE		1			Α		А			1	EQUIPPED SPACE	26
27	EQUIPF	PED SPACE		1			В		В	0	100	2	SPARE	28
29	EQUIPF	PED SPACE		1			С		С					30
31	EQUIPF	PED SPACE		1			Α		А	EX	100	2	BOILER ROOM PANEL	32
33	EQUIPF	PED SPACE		1			В		В					34
35	EQUIPF	PED SPACE		1			С		С	0	100	2	SPARE	36
37	EQUIPF	PED SPACE		1			Α		Α					38
39	EX CIR	CUIT		2	40	EX	В	5	В	0	225	2	EX UPPER PANEL	40
41							С		С					42

VOLTA	GE:	120 /	240	BUS:				PANEL	C CONTROLLAR	and a				MANUF:	SQUARE D	
PHASE	:	1			MCB 2P	-225A		LOCATION	MECHAN	NICAL R	MOC					
MRE:		3						FEED FROM	: MDP (MA	AMMAL I	HOUSE)			TYPE:	NQO	
AIC:		22,000							100000000000000000000000000000000000000							
				BREA	AKER	LC	DAD		LO	AD	BRE	AKER				T
CKT		DESCRIF	TION	POLE	TRIP	KVA	PHASE	NOTES	PHASE	KVA	TRIP	POLE		DESC	CRIPTION	CK
1	MECH R	M LTS & RE	D PANDA LTS	1	20	0.6	Α		Α	0.18	20	1	RED P	ANDA RE	CEPT	2
3	RED PAI	NDA CEILIN	IG RECEPT	1	20	0.36	В	İ	В	0.36	20	1	GRI RE	CEPT EX	KIBIT B	4
5	EXTERIO	OR RED PA	NDA LTS	1	20	0.2	С		С	0.18	20	1	GFI RE	CEPT EX	(IBIT A	6
7	BLUE FA	N EXHIBIT	A	1	20	0.3	Α		Α	0.2	20	1	WATER	R DRINKE	R EXHIBIT A	8
9	WATER	DRINKER E	XHIBIT B	1	20	0.2	В		В	0.8	20	1	CIRCU	LATING F	PUMP EXHIBIT B	10
11	CIRCUL	ATING PUM	IP EXHIBIT A	1	20	0.8	С		С	0.1	20	1	TIME C	CLOCK		12
13	EXTR R	STRING 8	POLE LTS	1	20	0.3	Α		Α	0.3	20	1	EXTER	IOR POL	E LTS/REC CKT 1	14
15	OUTSID	E HP-1 UNI	Т	2	50	3.4	В		В	0.3	20	1	EXTER	IOR POL	E LTS/REC CKT 2	16
17							С		С	0.3	20	1	EXTER	IOR POL	E LTS/REC CKT 3	18
19	MECH R	M RECEPT	FOR UVLTS	1	20	0.2	Α		Α	3	20	2	WATER	RHEATER	RPB	20
21	EF-1 SE	RVING RED	PANDA BLD	1	20	0.5	В		В							2
23	EXTERIO	OR ACORN	LTS	1	20	0.1	С		С	1.5	35	2	FCU-1	RPB		24
25	FLOOD I	IGHT EXHI	BIT A	1	20	0.1	Α		Α							26
27	RECEPT	ACLES-EXT	TERIOR	1	20	0.2	В		В	3	20	2	UNIT H	EATER N	MECH RM RPB	28
29	SPARE			1	20	0	С		С							30
31	SPARE			1	20	0	Α		Α	2.18	100	2	PANEL	.RPS		32
33	SPARE			1	20	0	В		В							34
35	SPARE			1	20	0	С		С	0.18	20	1	EXHIBI	T B BLUE	FAN RECEPT	36
37	SPARE			1	20	0	Α		Α	0	20	1	SPARE			38
39	EQUIPPE	ED SPACE		1			В		В			1	EQUIP	PED SPC	AE	40
41	EQUIPPE	ED SPACE		1			С		С			1	EQUIP	PED SPC	AE	42

						NEW	RPS	PAN	EL S	CHE	DULE					
VOLTA	GE:	120	/ 240	BUS:	100A			MOL	INTING	SURFAC	E				MANUF: SQUARE [)
PHASE:	3	1		MAIN:	MCB 2P	-100A		LOC	CATION	RED PAN	NDA STO	RAGE				
WIRE:		3			_			FEED	FROM	PANEL R	RDP				TYPE: NQO	
AIC:		22,000														
CICT		DECODI	DTION	BREA	AKER	LC	DAD	NO	TEC	LO	AD	BRE	AKER		DESCRIPTION	CILT
CKT		DESCRI	PHON	POLE	TRIP	KVA	PHASE	NO.	IES	PHASE	KVA	TRIP	POLE		DESCRIPTION	CKT
1	STORAG	GE LTS		1	20	0.3	Α			Α	0.3	20	1	BLUE I	FAN	2
3	EXTERIO	ORLTS		1	20	0.1	В	4		В	0	20	1	SPARE	3	4
5	EXHIBIT	A BLUE F	AN RECEPT	1	20	0.18	С			С	0	20	1	SPARE	-	6
7	SPARE			1	20	0	Α			Α	0	20	1	SPARE		8
9	SPARE			1	20	0	В			В	0	20	1	SPARE		10
11	SPARE			1	20	0	С			С	0	20	1	SPARE		12
13	SPARE			1	20	0	Α	0		А	0	20	1	SPARE	3	14
15	EQUIPP	ED SPACE		1	20		В			В		20	1	EQUIP	PED SPACE	16
17	EQUIPP	ED SPACE		1	20		С			С		20	1	EQUIP	PED SPACE	18
19	EQUIPP	ED SPACE		1	20		Α		N.	Α		20	1	EQUIP	PED SPACE	20
21	EQUIPP	ED SPACE		1	20		В			В		20	1	EQUIP	PED SPACE	22
23	EQUIPP	ED SPACE		1	20		С			С		20	1	EQUIP	PED SPACE	24
25	EQUIPP	ED SPACE		1	20		Α			Α		20	1	EQUIP	PED SPACE	26
27	EQUIPP	ED SPACE		1	20		В			В		20	1	EQUIP	PED SPACE	28
29	EQUIPP	ED SPACE		1	20		С			С		20	1	EQUIP	PED SPACE	30

PANEL SCHEDULE NOTES:

- 1. PROVIDE NEW CIRCUIT BREAKER.
- 2. TRACE AND LABEL.

BKP

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CLIENT: MARYLAND ZOO

THE MARYLAND ZOO IN BALTIMORE

1 SAFARI PLACE

BALTIMORE, MD 21217

RED PANDA

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IN BALTIMORE
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REVISION	DATE

DRAWING TITLE:
PANEL SCHEDULES

DRAWING NO:

E-601

3 | 4 | 5 | 6 | 7 | 8 | 9 | 10 | 11 | 12 | 13 | 14 | 15 | 16 | 17 | 18 | 19 | 20 |

	FAN COIL UNIT SCHEDULE																					
DESIGN	LOCATION	SA CFM	OA CFM	ESP IN	TOTAL MBH	COOLING COIL SENS MBH	EATdb\wb	HEAT MBH	PUMP Eat	MBH	ELECTF KW	RIC HEAT EAT	ing coil Volts	PHASE	HP	FLA	FAN MO	TOR VOLTS	PHASE	MANUF.	MODEL NUMBER	REMARKS
FCU-1	MECH ROOM	1,050	210	0.7"	35.2	-	83.0°\71.4°	35.0	54°	27.3	5.0	54°	230	1	1/2	4.3	5.4	230	1	CARRIER	FV4CNB003L	12

NOTES:

1 HEAT PUMP SYSTEM

2 RATED HEATING CAPACITY BASED ON 5°F OUTDOOR TEMPERATURE.

			CON	IDENSI	NG UN	NT SC	HEDULE						
DESIGN	LOCATION	COOL	HEAT	OA		EL	ECTRICAL		MANUF.	MODEL	REMARKS		
BESIGN	LOOMION	MBH	MBH	TEMP	MCA	AMPS	VOLTS	PHASE	100 1101 .	NUMBER	TILINI TITIO		
HP-1	exterior	35.2	35.0	2	30 14.8 230 1 CARRIER 38MURAQ36AB3								

NOTES:

1 HEAT PUMP SYSTEM.

2 RATED COOLING AND HEATING CAPACITIES BASED ON 95'F DB/ 75'FWB (COOLING), 5'F DB (HEATING).

					EXHAUS	T FAN	SCHEDI	JLE				
DESIG.	LOCATION	TYPE	CFM	FAN RPM	TOTAL S.P. IN WG	BHP	MOTOR HP	MOTOR RPM	BELT/ DIRECT	VOLTS/PHASE	COOK MODEL NUMBER	REMARKS
EF-1	MECH ROOM	IN-LINE BLOWER	400	1720	0.5	118 WATTS	1/6	1302	DIRECT	115/1	90SQN17DEC	1
NOTES:			-	-				-		-		

1 ELECTRONICALLY COMMUNICATED MOTOR WITH INTEGRAL POTENTIOMETER FOR SPEED ADJUSTMENT.

			SCH	EDULE	OF AIR	DEVICES						
	DESIGN	MAX AIRFLOW (CFM)	FACE SIZE	NECK SIZE	AIR SERVICE	TYPE	TITUS Model	REMARKS				
Ī	1	110	-	8	SA	NOZZLE	TND-AA	1				
	2	660	ı	30x6	SA	Supply Grille	300R	1				
	3	400	ı	12x10	EA	EXHAUST GRILLE	350RL	2				
	4	1050	-	18x14	RA	return grille	350RL	2				

NOTES:

1 BALANCE AIR DEVICE TO AIRFLOW SHOWN ON PLAN.

2) PROVIDE SURFACE MOUNT BORDER.

			U	NIT HEA	ATER	SCHE	DULE	- - -			
DESIGN	LOCATION	CFM	HEATING	ELECTRIC	HEATING	COIL	VOLTS	PHASE	AMP	QMARK	REMARKS
DESIGN	LOCATION	CFM	CAP BTUH	KW	LATdb	EATdb	VULIS	FIMOL	AMIT	MODEL NUMBER	KEIMAKKS
UH-1	MECH ROOM	350	10,200	3	87	60	240	1	12.5	MUH03-21	1
NOTES:											
1 PROVID	E WITH THERMOSTAT.										

ME	CHANICAL	
<u>SYMBOL</u>	ABBREV	DESCRIPTION NEW WORK
	СХ	CONNECT NEW WORK TO EXISTING
	EX	EXISTING WORK TO REMAIN
	RX	REMOVE EXISTING WORK
		RELOCATED WORK
	RL	REFRIGERANT LIQUID
——RS——	RS	REFRIGERANT SUCTION
—— CD ——	CD	CONDENSATE DRAIN
	SAN	SANITARY LINE
	VP	VENT PIPE
	CW	COLD WATER
	HW	HOT WATER
	HWR	HOT WATER RECIRCULATING
—TW—	TW	TEMPERED WATER
—	G	GAS
— —		SHUT OFF VALVE IN RISER
-₩ <u></u> Ō-		GATE VALVE, GLOBE VALVE
GPM		CHECK VALVE
		STATIONARY FLOW METER, PORTABLE FLOW METER, GPM
—	BFP	BACK FLOW PREVENTER
—————————————————————————————————————		BALANCING VALVE
- X - X -		TEMPERATURE CONTROL VALVE(2 WAY,3 WAY)
		PRESSURE REDUCING VALVE
		RELIEF OR SAFETY VALVES
		BUTTERFLY VALVE
Q Q		MANUAL AIR VENT AUTOMATIC AIR VENT
		STRAINER
		UNION
Φ	T'STAT	THERMOSTAT
		THERMOMETER
		PRESSURE GAUGE
—o—		PIPE TURNED UP, PIPE TURNED DOWN
Ø	FD	FLOOR DRAIN
	FC	FLEXIBLE CONNECTION
 	FD	FIRE DAMPER
	VD	VOLUME DAMPER
	MOD	MOTOR OPERATED DAMPER
	SD	SMOKE DAMPER
	F3	SMOKE DUCT DETECTOR
		SUPPLY DUCT TURNED UP, TURNED DOWN
		RETURN DUCT TURNED UP, TURNED DOWN
		DIRECTION OF RISE IN DUCT
		SQUARE TO ROUND TRANSITION
(1)		REFER TO NOTE 1 ON THIS SHEET
	AFF	ABOVE FINISHED FLOOR
	AHU	AIR HANDLING UNIT
	FCU	FAN COIL UNIT
	DSD	DUCT SMOKE DETECTOR
	CLG CFM	CEILING CUBIC FEET PER MINUTE
	DN	DOWN
	EF	EXHAUST FAN
	EXH	EXHAUST
	OA	OUTSIDE AIR
	SA	SUPPLY AIR
	TYP	TYPICAL
	CU	CONDENSING UNIT
	НР	HEAT PUMP
	• • •	



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PERMIT SET	11/22/2024					
revision	DATE					


DRAWING TITLE:

MECHANICAL SCHEDULES

AND LEGEND

DRAWING NO:

A-001

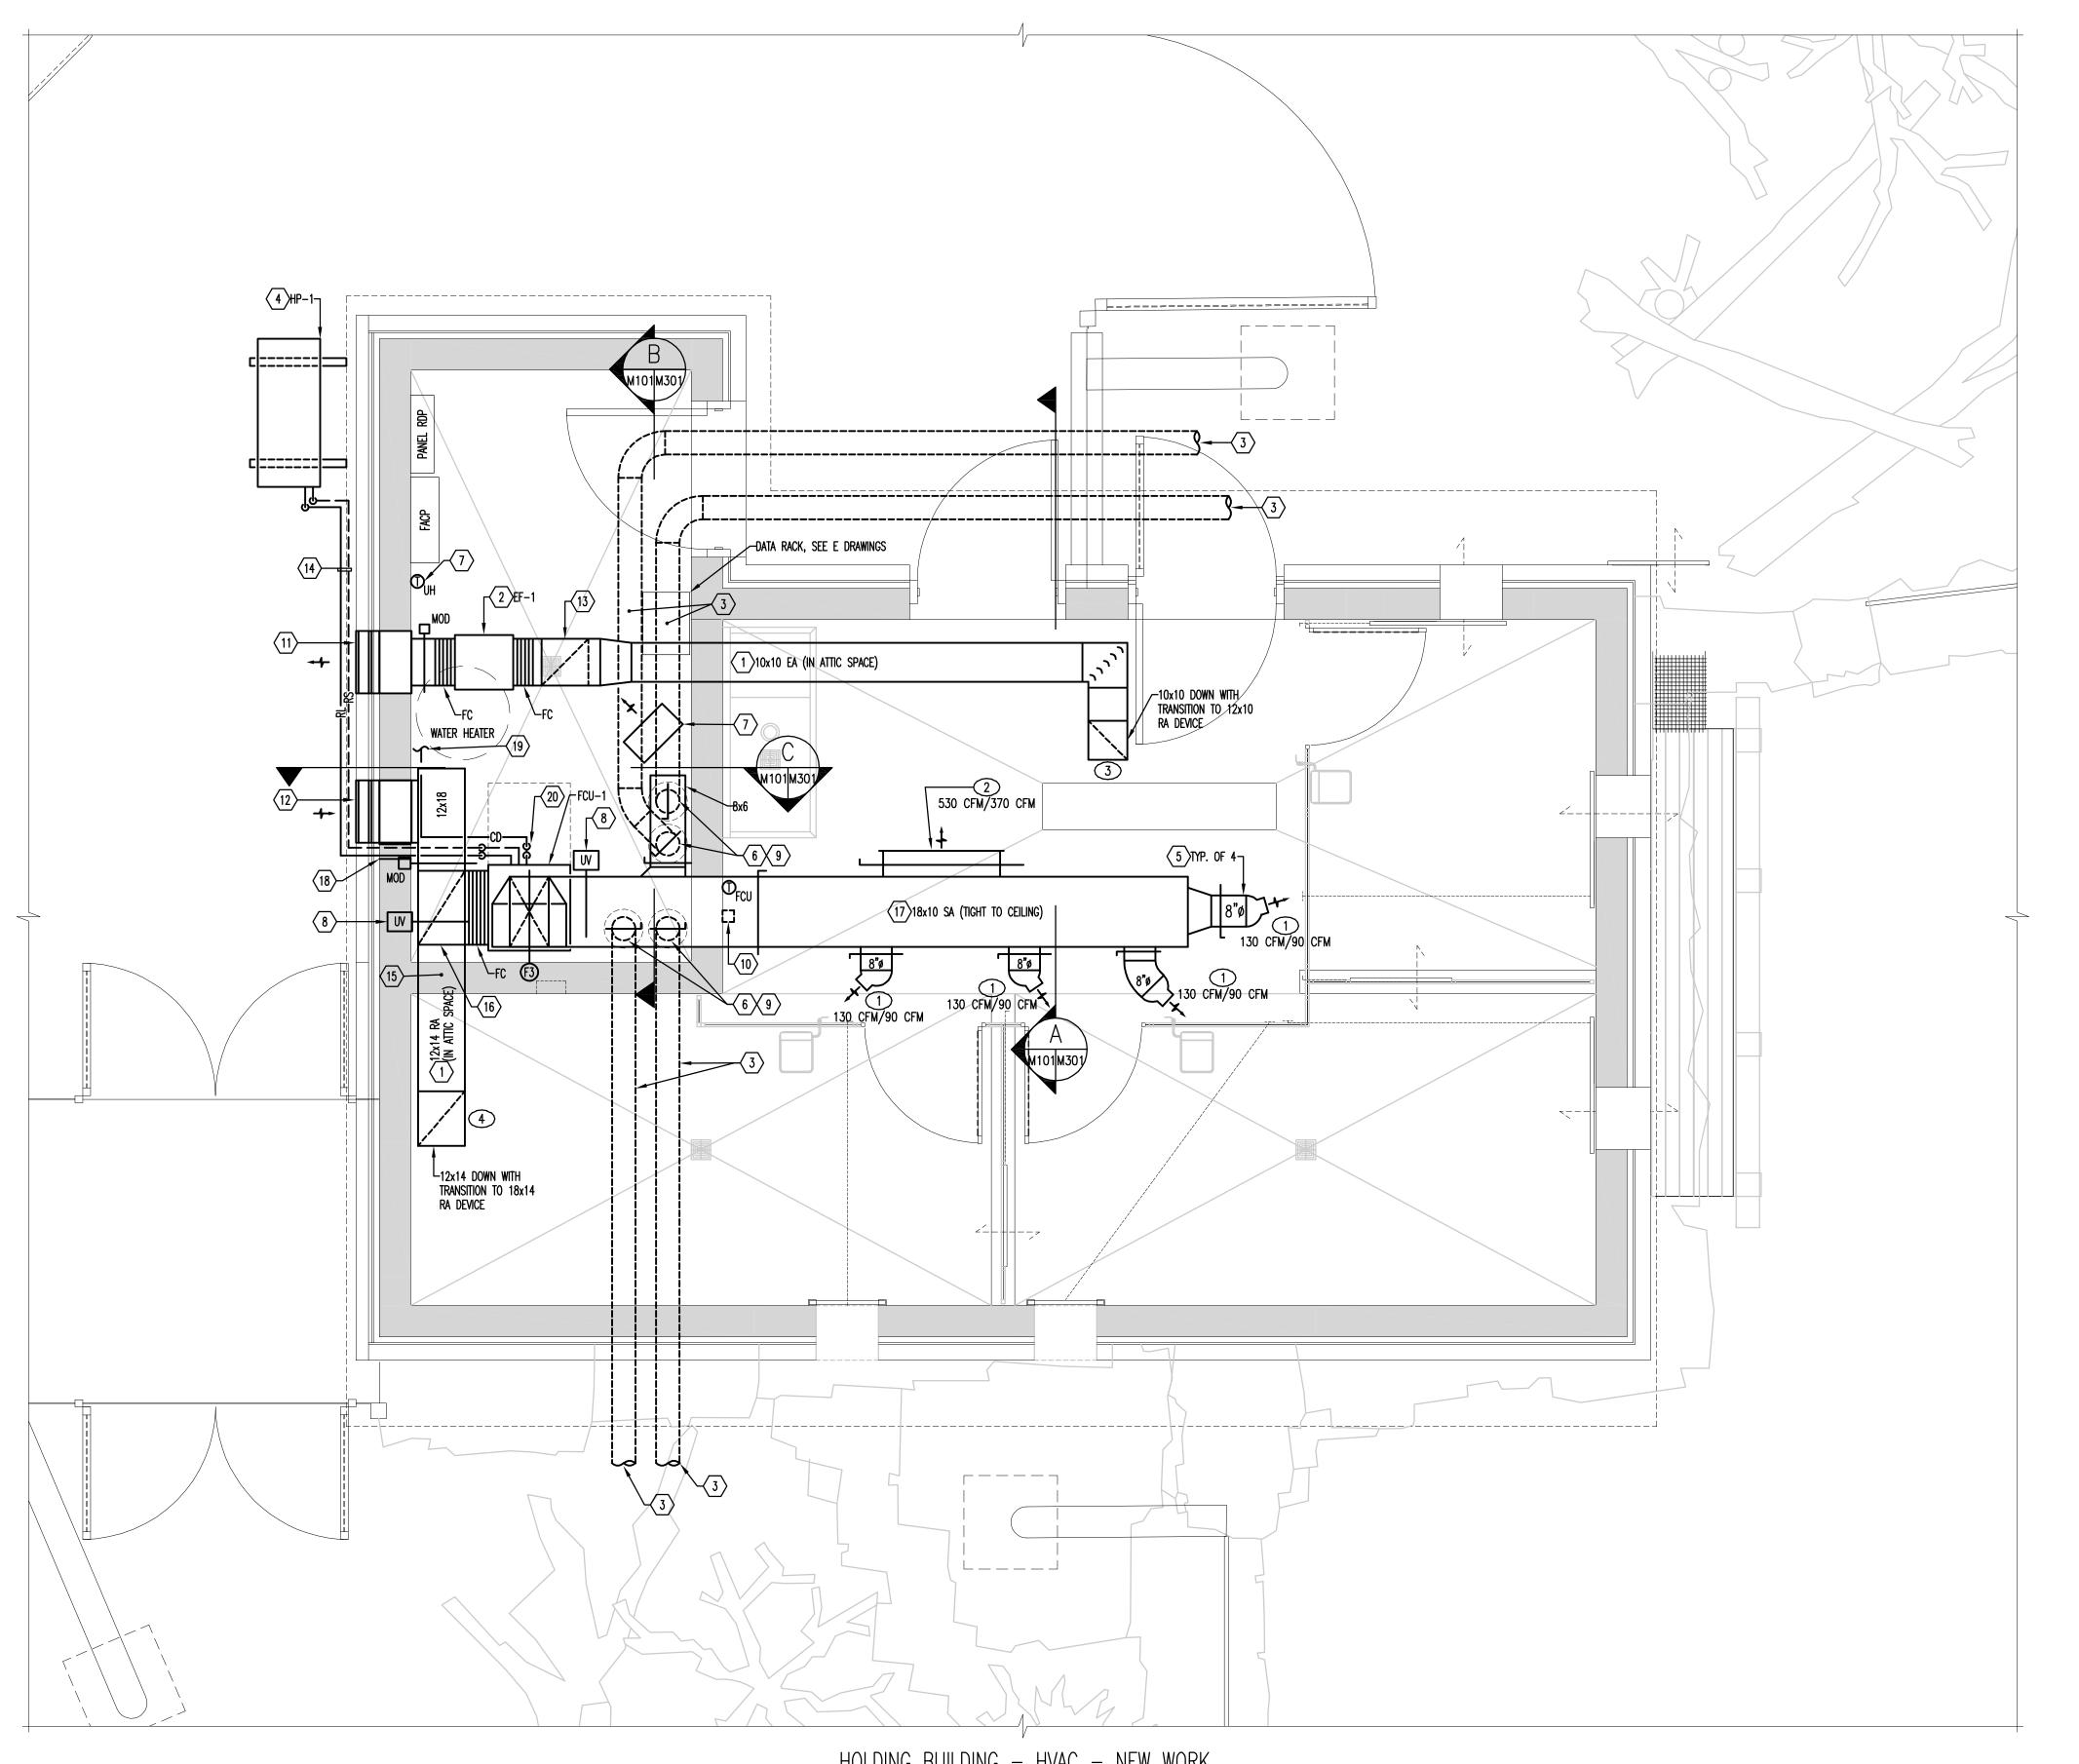

HOLDING BUILDING — HVAC — NEW WORK SCALE: 1/2"=1'-0"

DRAWING NOTES:

- 1) PROVIDE DUCTWORK ABOVE CEILING IN ATTIC SPACE.
- PROVIDE EXHAUST FAN SUSPENDED FROM STRUCTURE. REFER TO EXHAUST FAN INSTALLATION DETAIL ON SHEET M-501.
- 3 6" PVC SA DUCTWORK BELOW GRADE TO HABITAT FEATURES. REFER TO SITE PLANS ON SHEET M-102 FOR CONTINUATION.
- PROVIDE HEAT PUMP MOUNTED TO WALL, 24" ABOVE GRADE. PROVIDE MANUFACTURER'S WALL MOUNT KIT AND INSTALL RECOMMENDED CLEARANCE AWAY FROM BUILDING WALL.
- 5 NOZZLE-TYPE AIR DEVICE. DIRECT AIR INTO STALLS AND AWAY FROM EXTERIOR WALL OPENINGS.
- PROVIDE TWO MANUAL VOLUME DAMPERS FOR EACH 6"Ø SA DUCT. ONE DAMPER NEAR THE TAKE OFF SHALL BE USED FOR BALANCING THE SYSTEM. THE OTHER DAMPER SHALL BE APPROX. 48" AFF, HAVE IT'S "OPEN" AND "CLOSE" POSITIONS LABELED FOR MANUAL CONTROL AND BE ACCESSIBLE TO ZOO PERSONNEL. BALANCE EACH 6" TAKEOFF TO 80 CFM.
- 7 PROVIDE UNIT HEATER SUSPENDED FROM STRUCTURE ABOVE. PROVIDE WALL MOUNTED THERMOSTAT FOR THE UNIT HEATER. REFER TO UNIT HEATER INSTALLATION DETAIL ON SHEET M-501.
- PROVIDE (2) UV LAMPS WITH POWER SOURCE FOR FCU. MOUNT POWER SOURCE TO WALL UNDER OA LOUVER. INSTALL PER MANUFACTURER'S RECOMMENDATION. PROVIDE (1) LAMP IN THE RETURN PLENUM AND (1) LAMP IN THE SUPPLY PLENUM.
- 9 DROP (2) 6"Ø SHEETMETAL SA DUCTS DOWN ALONG WALL TO FLOOR AND TRANSITION TO 6"Ø PVC DUCT APPROX. 6" AFF, BEFORE PENETRATING FLOOR SLAB.
- 10 PROVIDE FCU/EF SWITCH. REFER TO ATC.
- PROVIDE BOX STYLE 16x16 EXHAUST DISCHARGE LOUVER. REFER TO DETAIL ON SHEET M-501.
- PROVIDE BOX STYLE 16x16 OA INTAKE LOUVER. REFER TO DETAIL ON SHEET M-501.
- (13) 12x12 EXHAUST DUCT UP INTO ATTIC SPACE.
- PROVIDE 1/2"RL & 7/8"RS RACKED ALONG EXTERIOR WALL BETWEEN FCU-1 AND HP-1. CONFIRM PIPE SIZING WITH MANUFACTURER.
- 15 12x14 RA DUCT. CONNECT RA PLENUM EXTENDED ABOVE MECHANICAL ROOM INTO ATTIC SPACE
- (16) 20x12 RETURN AIR PLENUM DOWN.
- (17) SUSPEND DUCT BELOW AND TIGHT TO CEILING. REFER TO SECTION ON M-301.
- PROVIDE SLEEVES FOR REFRIGERANT PIPE PENETRATIONS IN WALL. MAKE PENETRATIONS WEATHER TIGHT. REFER TO DETAIL ON SHEET M-501.
- (19) EXTEND 1"CD TO FLOOR DRAIN.
- $\overline{\langle 20 \rangle}$ provide condensate drain trap. Refer to detail on sheet M=501.

BALANCE NOTES:

- 1. BALANCE FCU-1 TO 1050 CFM.
- 2. BALANCE SUPPLY AIR DEVICES TO CFM NOTED ON PLAN AND BALANCE 6" DUCT DROPS TO CFM NOTED IN DRAWING NOTE 6, THIS SHEET. SECONDARY MANUAL CONTROL DAMPERS IN 6" SA DUCTS SHALL BE FULLY OPEN.
- 3. PROVIDE ADDITIONAL CFM READINGS AT EACH SA DEVICE WHILE SECONDARY MANUAL CONTROL DAMPERS IN 6"0 SA DUCTS ARE FULLY CLOSED.



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CLIENT:

MARYLAND ZQO

THE MARYLAND ZOO IN BALTIMORE

1 SAFARI PLACE

BALTIMORE, MD 21217

E MARYLAND ZOO IN BALTIMORE
1 SAFARI PLACE
TIMORE, MD 21217

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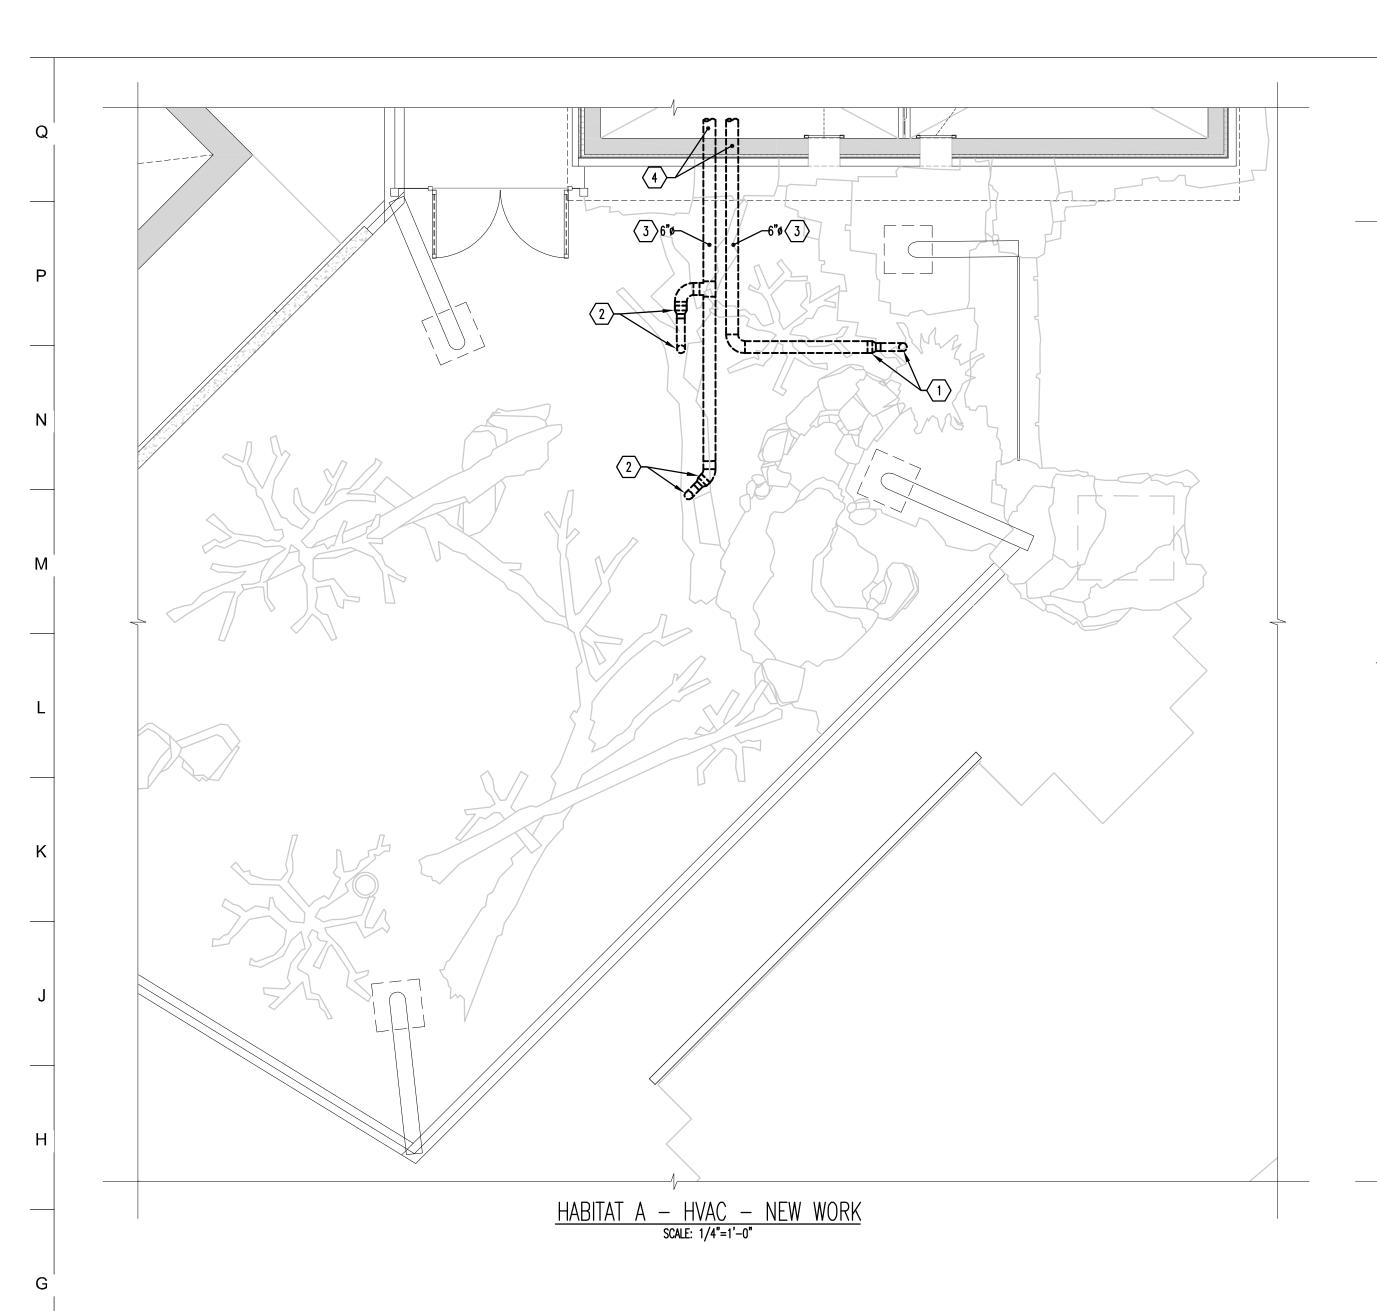



DATE: NOVEMBER 22, 2024					
PROJECT NO: 2023-10.04					
DRAWN BY	KWA				
CHECKED BY	KWA				
SUBMISSION	DATE				
PERMIT SET	11/22/20				
REVISION	DATE				

DRAWING TITLE:
HOLDING BUILDING - HVAC
- NEW WORK

DRAWING NO:

N-101



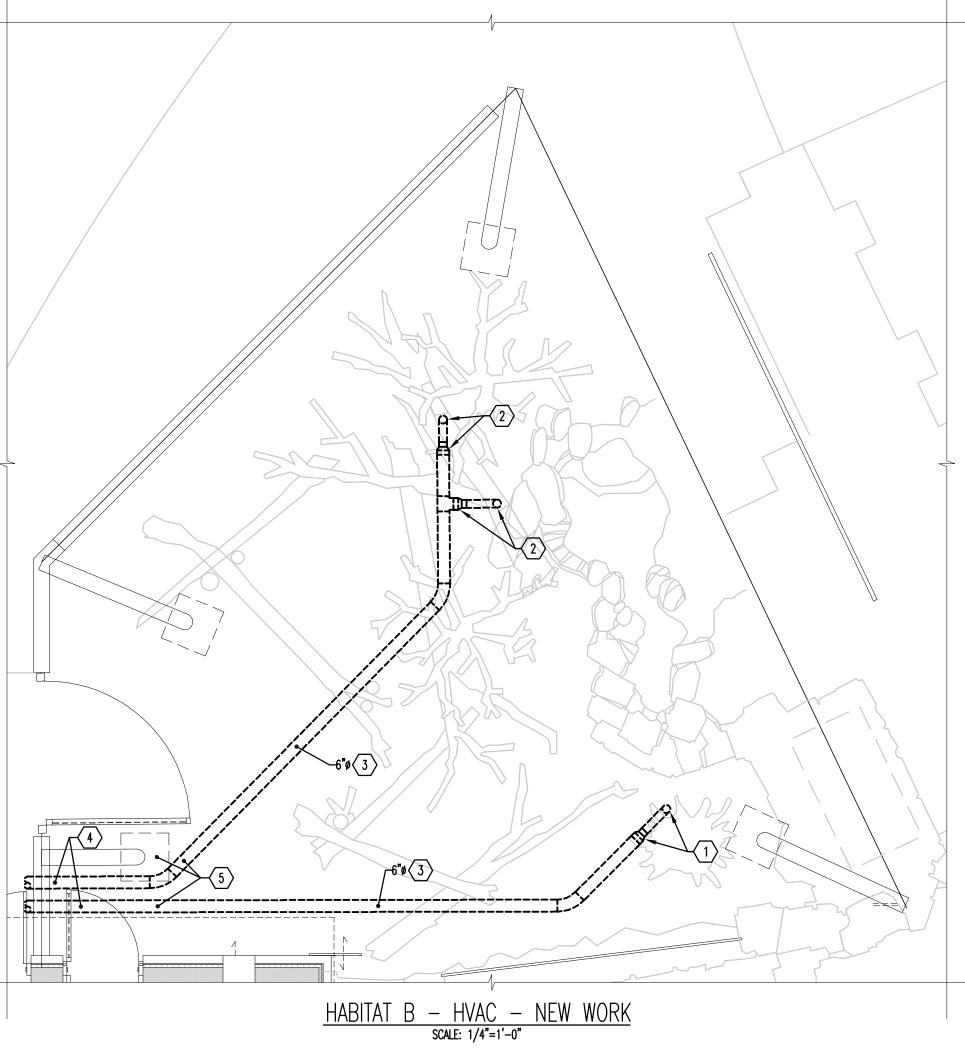

DRAWING NOTES:

- 6°ø (PVC) SA DUCT TO HABITAT FEATURE. TRANSITION 6°Ø SA DUCT TO 4°Ø DUCT AT FAUX TREE STUMP, THEN UP WITHIN FAUX STUMP TO SA OUTLET. COVER OPENING WITH 1/4" STAINLESS STEEL SCREEN. REFER TO SHEET L-410 FOR ADDITIONAL DETAILS.
- 6"0 (PVC) SA DUCT TO HABITAT FEATURE. TRANSITION 6"0 SA DUCT TO 4"0 DUCT AT FAUX FALLEN TREE, THEN RISE UP WITHIN FAUX TREE TO SA OUTLET. COVER OPENING WITH 1/4" STAINLESS STEEL SCREEN. REFER SHEET L-410 FOR ADDITIONAL DETAILS.
- $\boxed{3}$ 6" (PVC) DUCT BELOW GRADE.
- 4 REFER TO FLOOR PLAN ON SHEET M-101 FOR CONTINUATION.
- 5 COORDINATE INSTALLATION OF DUCT WITH MAST FOOTERS. DUCT SHALL BE ABOVE FOOTER.



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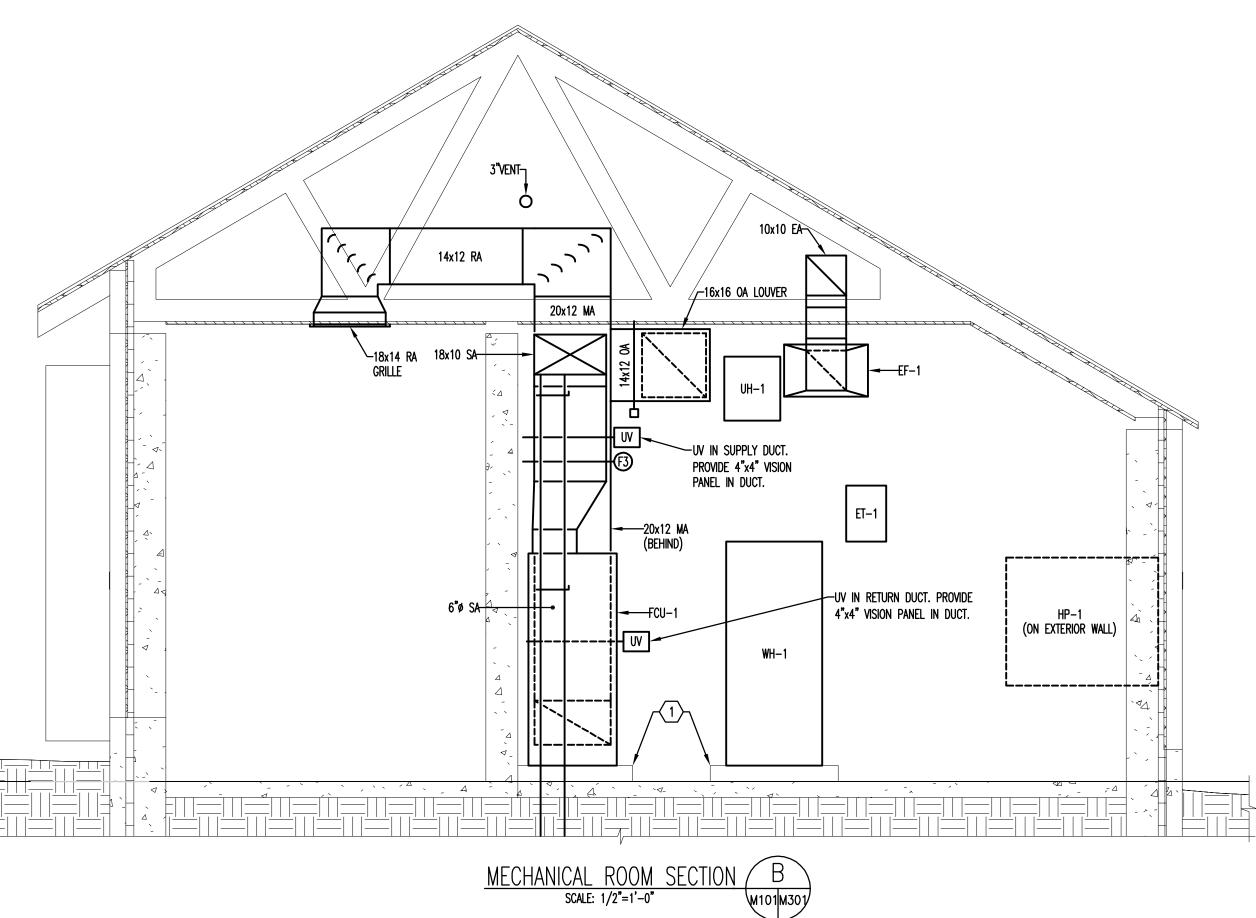



	DATE: NOVEMBER 22, 2024					
	PROJECT NO: 2023-10.0	4				
	DRAWN BY	KWA				
	CHECKED BY	KWA				
	SUBMISSION	DATE				
	PERMIT SET	11/22/2024				
	REVISION	DATE				
1						

DRAWING TITLE: SITE PLAN - HVAC - NEW

DRAWING NO:

M-102



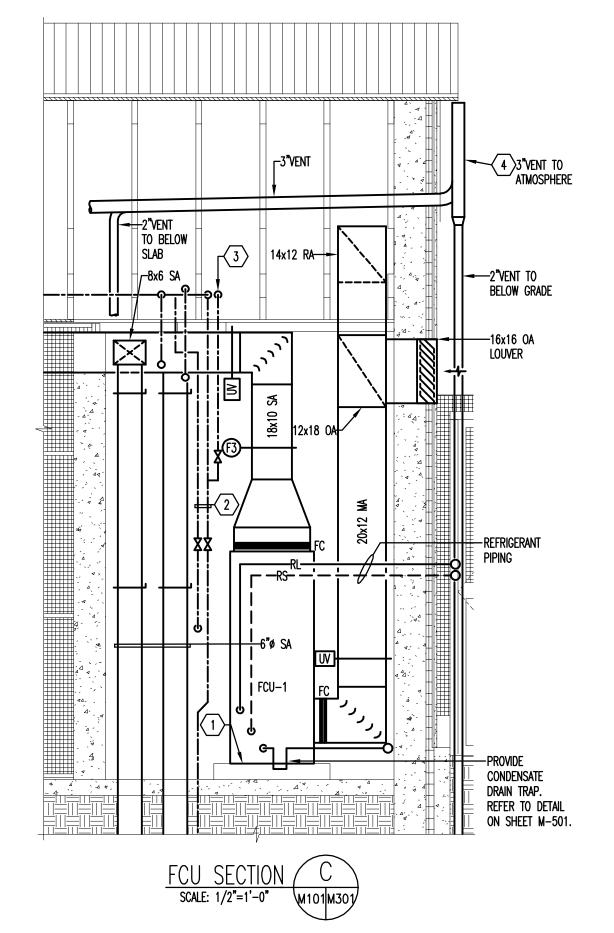



- 1 PROVIDE HOUSEKEEPING PAD. REFER TO S501 DETAIL M17.
- 2 3/4"TW DOWN ALONG WALL AND THROUGH WALL. 1/2"DCW DOWN ALONG WALL AND THROUGH SLAB.
- $\sqrt{3}$ 3/4"DCW IN ATTIC SPACE.
- 4 TERMINATE VENT AT LEAST 60" ABOVE THE TOP OF 16x16 OA LOUVER.

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RED PANDA

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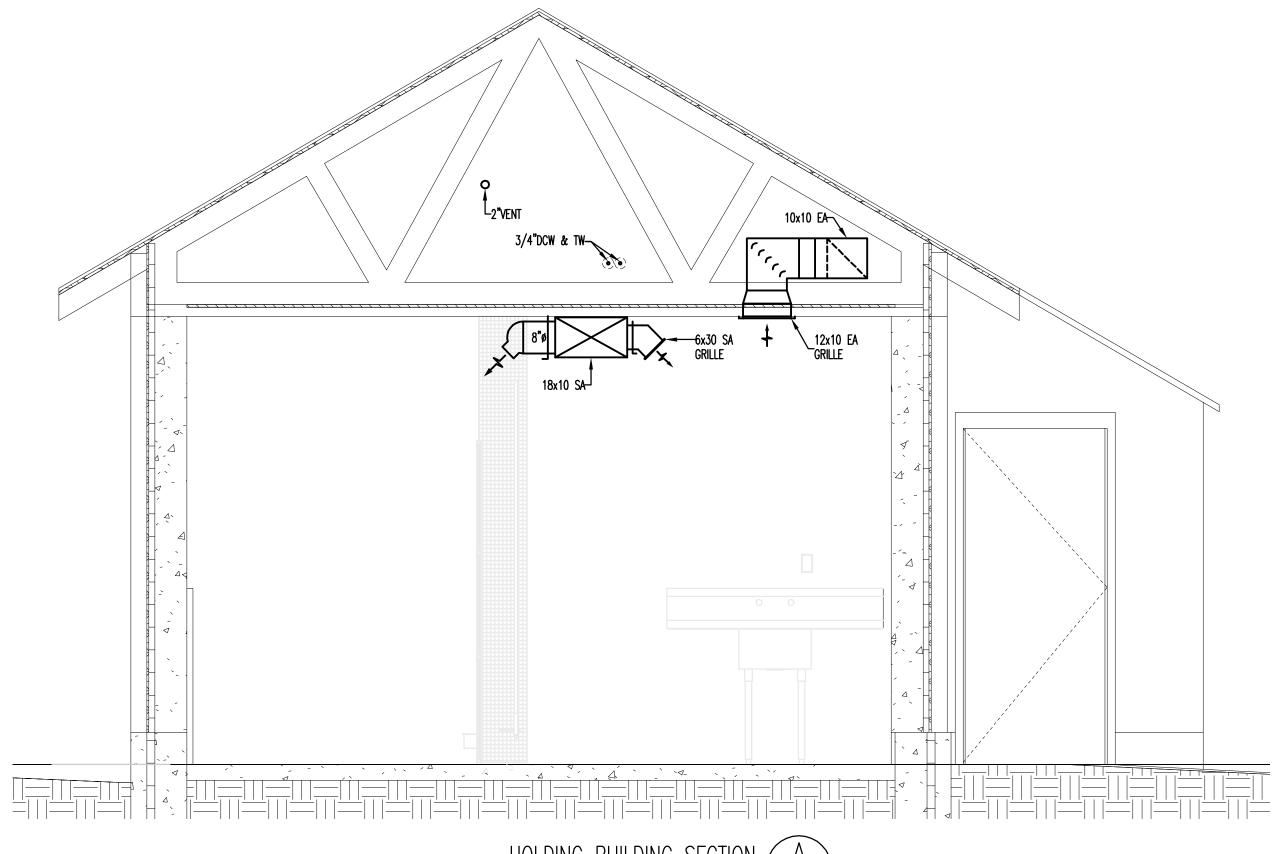
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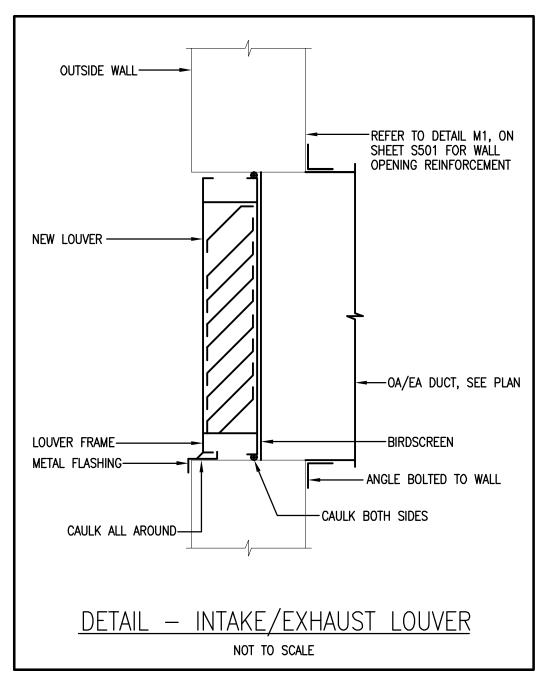
DATE: NOVEMBER 2	22 2024			
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CHECKED BY	KWA			
submission	DATE			
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REVISION	DATE			


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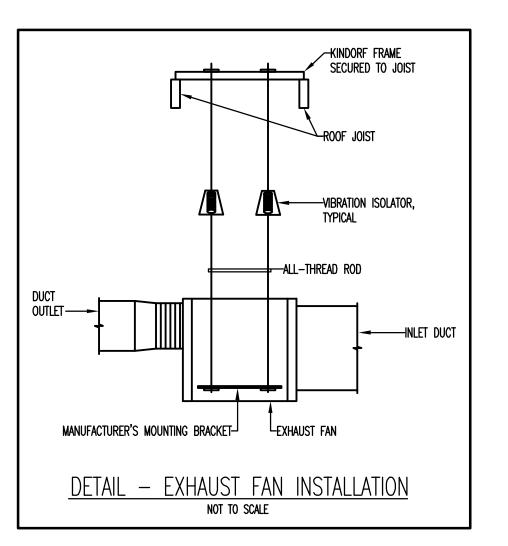
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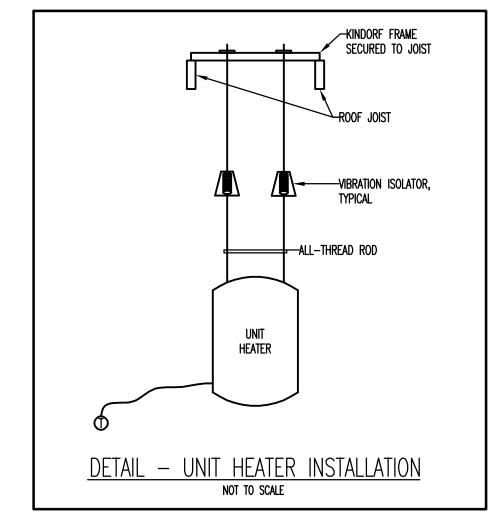













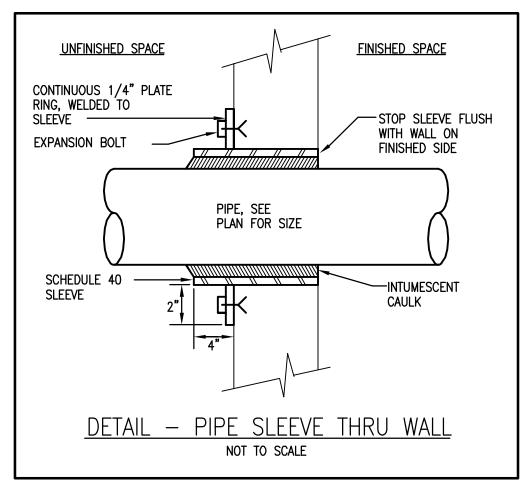

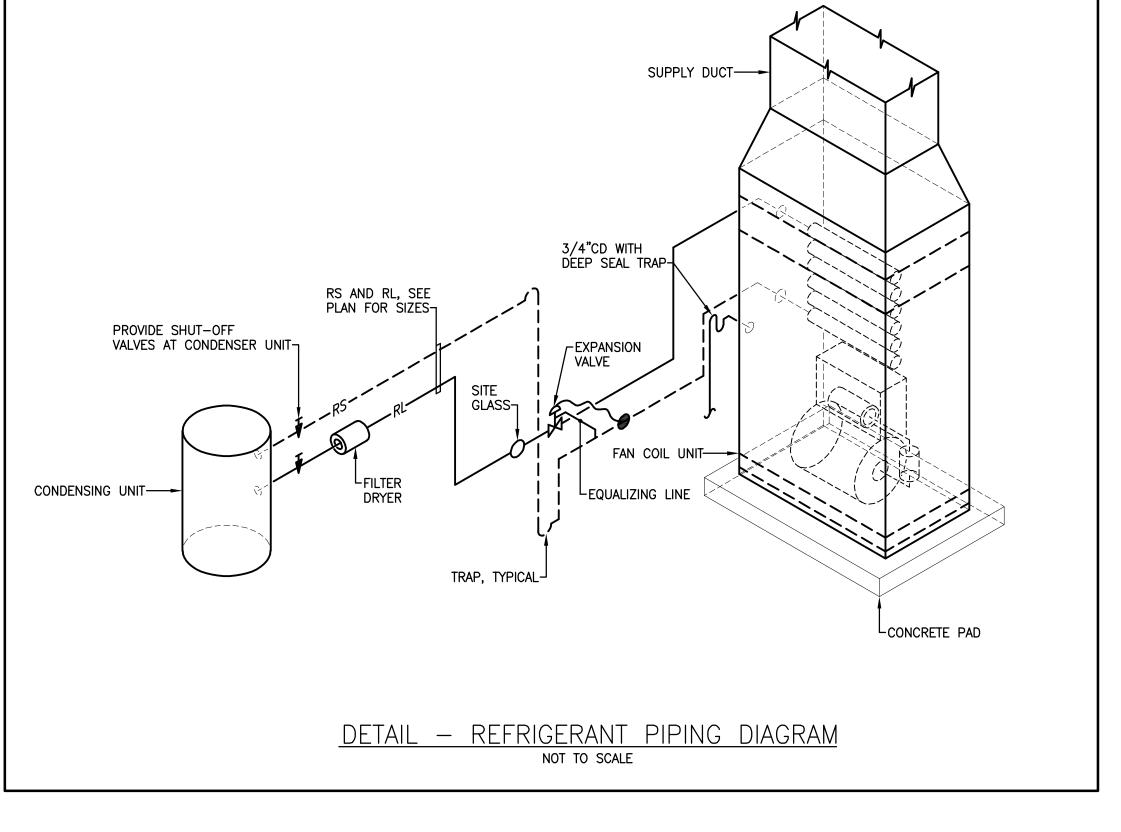


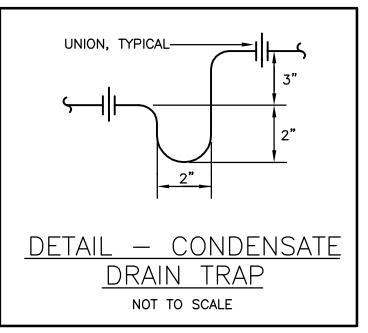


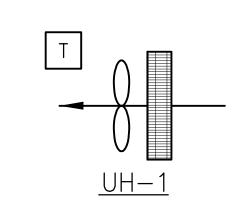

UNIT HEATER SEQUENCE OF AUTOMATIC CONTROL

1. IF TEMPERATURE AS SENSED BY SPACE THERMOSTAT T-1 FALLS BELOW 60°F, THEN ELECTRIC HEATER UNIT HEATER SHALL BE ENERGIZED. ON A RISE IN TEMPERATURE ABOVE SETPOINT AS SENSED BY T-1, UNIT HEATER SHALL BE DE-ENERGIZED.

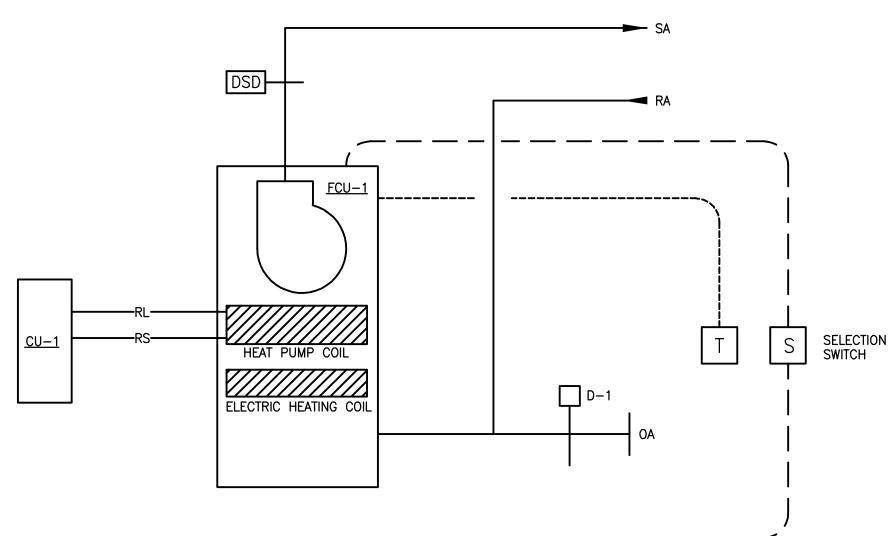

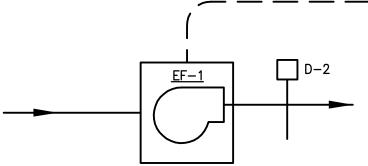

FCU-1 / CU-1

FAN COIL UNIT / EXHAUST FAN SEQUENCE OF AUTOMATIC CONTROL

- ATC CONTRACTOR TO PROVIDE SYSTEM SELECTION SWITCH THAT WILL ALLOW ZOO PERSONNEL TO HAVE THREE OPTIONS.
 OPTION 1 SELECTION ENERGIZE AC/HEAT PUMP SYSTEM
 OPTION 2 SELECTION ENERGIZE EXHAUST FAN
 OPTION 3 SELECTION BOTH SYSTEMS OFF.
- 2. PROVIDE PROGRAMMABLE AUTOMATIC CHANGE-OVER THERMOSTAT WITH OFF-FAN-ON-AUTO SUBBASE AND 7-DAY TIME CLOCK. PROGRAM AC/HEAT PUMP SYSTEM SCHEDULES AND TEMPERATURES AS DIRECTED BY THE ZOO PERSONNEL.
- 3. WHEN SELECTION SWITCH IS IN THE AC/HEAT PUMP SYSTEM POSITION, THE THERMOSTAT SHALL ENERGIZE COOLING OR HEATING TO SATISFY THE SPACE TEMPERATURE SETTINGS. MOTOR OPERATED DAMPER D-1 SHALL OPEN WHEN UNIT IS ENERGIZED AND CLOSED WHEN UNIT IS DE-ENERGIZED. UPON SWITCH SELECTING EITHER OFF POSITION OR EXHAUST FAN POSITION, AC/HEAT PUMP SYSTEM SHALL BE DE-ENERGIZED AND DAMPER D-1 SHALL CLOSE.
- 4. WHEN SELECTION SWITCH IS IN THE EXHAUST FAN POSITION, DAMPER D-2 SHALL OPEN. UPON DAMPER D-2 OPENIING TO 75%, END SWITCH SHALL ENERGIZE EF-1. UPON SWITCH SELECTING EITHER OFF POSITION OR AC/HEAT PUMP POSITION, EF-1 SHALL BE DE-ENERGIZED AND DAMPER D-2 SHALL CLOSE.
- 5. DUCT SMOKE DETECTOR UPON SENSING PRODUCTS OF COMBUSTION SHALL DE-ENERGIZE THE AC/HEAT PUMP SYSTEM.



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DRAWING TITLE:
DETAILS AND ATC

DRAWING NO:

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